PROPOSED DESIGN DRAWINGS

SHEET LIST

P200 P201

P300

P400

S100


S101

S300

CITY OF GAITHERSBURG - MINIATURE GOLF PARK OFFICE BUILDING RENOVATION

514 S FREDERICK AVE, GAITHERSBURG, MARYLAND 20877

PERMIT / BID SUBMISSION JUNE 30, 2016

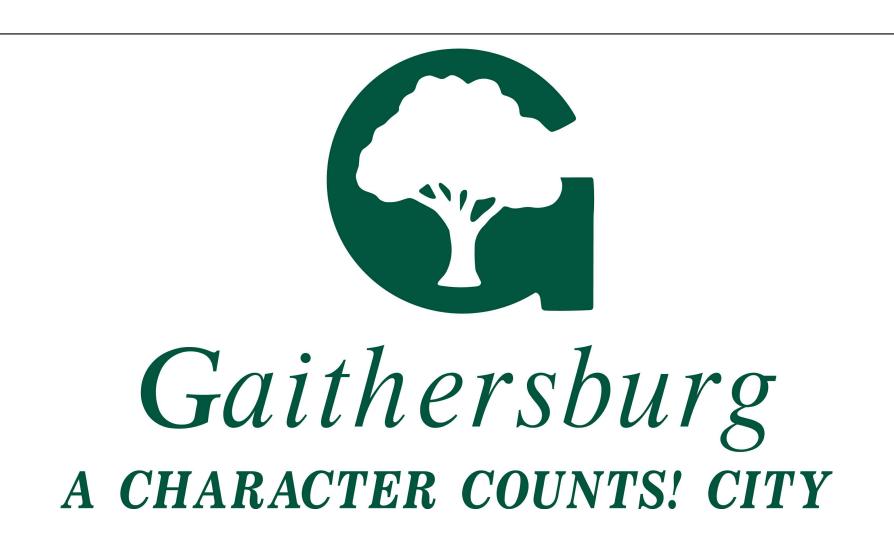





A001 COVER SHEET A002 GENERAL NOTES, ABBREVIATIONS & SYMBOLS AS001 SITE PLAN - EXISTING & DEMOLITION AS002 SITE PLAN - PROPOSED D101 GROUND FLOOR - DEMOLITION A102 GROUND FLOOR - PROPOSED A103 REFLECTED CEILING PLAN A104 ROOF PLAN

SHEET LIST

D101	GROUND FLOOR - DEMOLITION
A102	GROUND FLOOR - PROPOSED
A103	REFLECTED CEILING PLAN
A104	ROOF PLAN
A200	WEST ELEVATION
A201	EAST ELEVATION
A202	SOUTH ELEVATION
A203	NORTH ELEVATION
A300	LONG BUILDING SECTION
A301	SHORT SECTION THROUGH LOBBY
A500	INTERIOR ELEVATIONS
A501	ROOF DETAILS
A600	WALL SCHEDULE
A601	FINISH SCHEDULE
A602	DOOR SCHEDULE & DETAILS
A603	WINDOW SCHEDULE & DETAILS
A604	BATHROOM FIXTURE SCHEDULE
M001	COVER SHEET - MECHANICAL
M101	MECHANICAL FLOOR PLANS
M501	MECHANICAL SCHEDULES AND DETAILS
E001	ELECTRICAL SYMBOLS AND ABBREVIATIONS
ES101	ELECTRICAL SITE PLAN
EDL101	ELECTRICAL LIGHTING PLAN - DEMOLITION
EDP101	ELECTRICAL POWER PLAN - DEMOLITION
EDP501	ELECTRICAL - POWER RISER DIAGRAM - EXISTING
EP101	ELECTRICAL POWER PLAN
EP501	ELECTRICAL CONDUIT RISER DIAGRAM (IT AND POWER ONLY)
EP601	ELECTRICAL PANEL SCHEDULES
EL101	ELECTRICAL LIGHTING PLAN
EL501	ELECTRICAL LUMINARES SCHEDULE
EL601	LIGHTING CALCULATIONS - INTERIOR
EL602	LIGHTING CALCULATIONS - SITE
EY501	SECURITY RISER DIAGRAM
E501	ELECTRICAL DETAILS
P001	GENERAL NOTES, PLUMBING ABBREVIATIONS & SYMBOLS
P100	PLUMBING FLOOR PLAN-DEMOLITION
P101	PLUMBING FLOOR PLAN

SANITARY RISER DIAGRAM

DOMESTIC WATER RISER DIAGRAM

PLUMBING - DETAILS


PLUMBING SCHEDULES


STRUCTURAL - FLOOR PLAN


STRUCTURAL ROOF PLAN

STRUCTURAL - SECTION DETAILS

LOCATION MAP

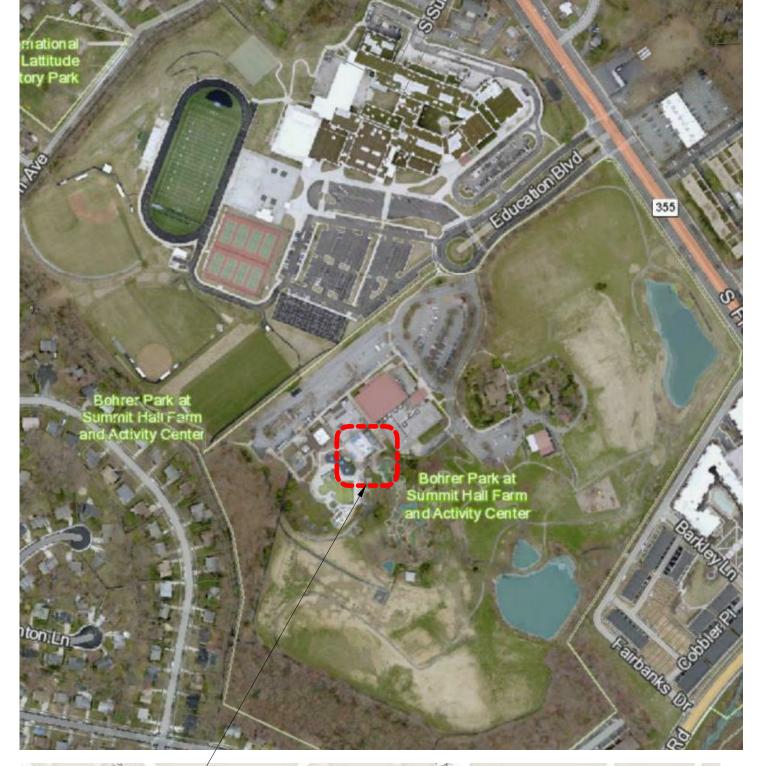

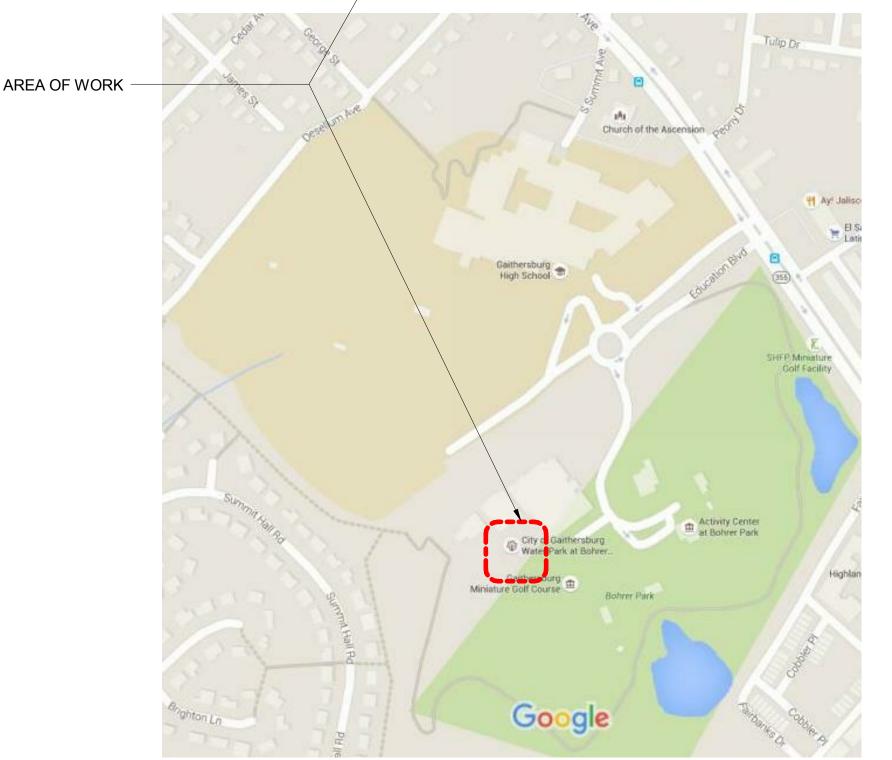

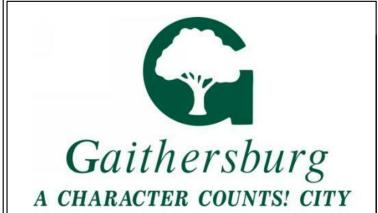

MINIATURE GOLF PARK OFFICE BUILDING RENOVATION

514 S Frederick Ave, Gaithersburg, MD 20877

NIKA

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451 HUNGERFORD DRIVE (P)301.770.352 4TH FLOOR (F)301.770.352

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No.	Description	Date
1	REVISION # 1	06/30/2016
2	REVISION # 2	07/12/2016
3	REVISION # 3	07/19/2016
Revisions	ı	

COVER SHEET

Revision

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Drawing Scale: AS NOTED

CADD Filename CADD Plot Scale
Revit Model 1:1

Drawn By ASM

Sheet Number
A001

MATERIAL SYMBOLS **ABBREVIATIONS: RETURN AIF** <u>G</u> RELILIENT ATHLETIC FLOORIN FIBER BOARD OR GA GAL **GAUGE** AND EARTH RAD/r RADIUS RIGID INSULATION **GALLON ANGLE** GALV **GALVANIZED** RCP REFLECTED CEILING PL N **REINFORCING BAI** GRAB BAR/GYPSUM BOARD **CENTER LINE** GB REBAR **GENERAL CONTRACTOR** RECEPTACLE REC DIAMETER **GFCI** REFERENCE GOVERNMENT-FURNISHED PLATE PLASTER, GYPSUM **REGISTRATIO** POUND/NUMBER CONTRACTOR-INSTALLED **GRAVEL OR** WALL BOARD, GFGI REINFORCING/REINFORCE **GOVERNMENT-FURNISHED** REINF POROUS FILL MORTAR, OR **GOVERNMENT-INSTALLED** REM REMOVE **ABOVE** PARTICLE BOARD **REPLACE** GFE REPL GOVERNMENT FURNISHED AIR CONDITIONING REQUIRE **EQUIPMENT** REQD ASPHALT CONCRETE GLASS/GLAZED RESIL **RESILIEN** ACOUST ACOUSTICAL RFTURN AIR GOVT ADJUSTABLE/ADJACENT **GOVERNMENT** CONCRETE GND GR REVISE/REVISIO GROUND ABOVE FINISHED FLOOR FINISHED WOOD MASONRY UNIT ROUGH FINISH GRADING/GRADE AIR HANDLING UNIT **GWB** GYPSUM WALLBOARD RIGID GALVANIZED STEEL ALTERNATE GYP BD RIGHT HAND GYPSUM BOARD **ALUMINUM** ROOM ANC **ANCHOR ROUGH OPENIN** ANOD ANODIZED HOLLOW CORE RAIN WATER LEADE APPROX APPROXIMATE BRICK **ROUGH WOOD** HD HEAD/HEAVY DUTY RWD REDWOOL ARCH ARCHITECTURAL HDWD **HARDWOOD** ASPH **ASPHALT HARDWARF** ASTM AMERICAN SOCIETY FOR SUPPLY AIR HAND HOLE TESTING AND MATERIALS SUSPENDED ACOUSTICAL CEILI G ATTCH **HOLLOW METAL** ATTACHMENT HOR SOLID CORE AUTO AUTOMATIC HORIZONTAL SCH SDG SCHEDUL **HORSEPOWER** AUX AUXILIARY STONE PLYWOOD SIDING HOUR STATIC DISSIPATIVE TIL HTG **HEATING/HEAT** SDT SECT HT/H HEIGHT/HIGH SECTION BASE BID SEAMLESS FLOORING HEATING, VENTILATING **BRICK COURSE** SG(#) DUCT SECURITY GRILL (TYPE & AIR CONDITIONING BOARD HERTZ SHFLE **BROOM FINISH** 4 4 4 CONCRETE STEEL OR IRON SHTH **SHEATHING BUILDING LINE** SIMII AR INSIDE DIAMETER/ SIM BUILDING INTERIOR DIMENSION STEEL JOIS BLKG BLOCKING SURFACE MOUNTED INSULATED GLASS BLKHD **BULKHEAD SPECIFICATIO** IMPACT INSULATION CLAS **SPEC** BM BEAM/BENCHMARK SQUARE BY OTHERS/BOTTOM OF **FIBROUS** SQUARE YARD INCL INCLUDIN(SQ YD BOT **BOTTOM ALUMINUM** INSULATION SQUARE FOO **INFORMATION** SQ FT **BEARING PLATE BOTH SIDES INSULATION** STAINLESS STEE STA STATION BSMT **BASEMENT** INTERIOR **STANDARD** STD BTWN BETWEEN **JANITOR** STAINLESS STEE BUR **BUILT-UP ROOF** SUSPENDED JOIST SUSP CONDUIT SHEET VINYL CAB CAP JOINT **CABINET** CAPACITY **SYMMETRICAL** KNOCK-DOWN/KILN-DRIED SYM CATALOG SYSTEM CIRCUIT BREAKER/CATCH BASIN KIT KITCHE SYS KO KNOCK OUT SHFF" CCTV CLOSED CIRCUIT TELEVISION SHT, SH STORAGE KILOPASCAL STOR KPA CEM CEMENT/CEMENTITIOUS STRUCTURE STRUCT KW **KILOWAT1** CUBIC FEET CFCI CONTRACTOR-FURNISHED TREAD/THICK LONG CONTRACTOR-INSTALLED **TOWEL BAR** L/S LAM LITERS PER SECON CEILING HEIGHT TOP OF CURB I AMINATE(D) CAST IRON POUND/LOAD-BEARIN TELE TELEPHONE/TELEC(v CIR CIRCLE **TEMP TEMPORAR** CIRC CIRCUMFERENCE TERRAZZO TER LINEAR FEE **CONTROL JOINT** TROWEL FINISH LONG/LENGTH CLKG CAULKING **TONGUE & GROOVE** T&G LEFT HAND CLG CEILING THICK/THICKNESS CLR LIVE LOAD CLEAR THRESHOLE THR LOW POINT CENTIMETER THRU THROUGH CONCRETE MASONRY UNIT CMU LTG LIGHT/LIGHTING TOP OF CLEAN OUT/CASED OPENING CO TOP OF CONCRET COL COLUMN TOS TOP OF STEEL **MFTFR** CONC CONCRETE TOP OF WALL MAS MASONRY TOW CONSTR CONSTRUCTION REFERENCE SYMBOLS MAT/MATI MATERIAL TOP OF WALL CONT CONTINUOUS MAXIMUM TYP TYPICAL CORR CORRIDOR MECH **MECHANICAI** CHROME PLATED **UNDERCUT** MED MEDIUM CS COUNTERSINK DETAIL/ SECTION NUMBER UNDERWRITER'S LABORATORIE MEMB **MEMBRANE** CSMT CASEMENT MET/MTL UNFINISHED CERAMIC TIL **MANUFACTUREI** UNO UNLESS NOTED OTHERWI CTR CENTER WALL SECTION MOUNTING HEIGH UNREINFORCED MASONR URM **CLEAR WIRE GLASS** NINIMUI CUBIC YARDS SHEET NUMBER MIR MIRROR VENT/VOLT/VALVE MISC MISCELLANEOU VFRIFY VARIABLE AIR VOLUM MIX **MIXTURE DECIBELS DETAIL/ SECTION NUMBER** VAPOR BARRIEF MATCH LINE DBL DOUBLE DEMOLISH/DEMOLITION MLD MOLDING VCB VCT VINYL COVE BASE DEMO SIMILAR INDICATION VINYL COMPOSITION TIL DET MM MILLIMETER DETAIL MO MS **BUILDING SECTION** DRINKING FOUNTAIN MASONRY OPENING VOLUME DAMPER/VAULT DOC DF VENT'D VENTED MOTOR STARTER SHEET NUMBER DG DAY GATE MT **VERT VERTICAL DOUBLE HUNG** MARBLE THRESHOL DH MTD VEST **VESTIBULE** MOUNTED DIA DIAMETER **DETAIL/ SECTION NUMBER** MTG MOUNTING V-JOINT DIM DIMENSION MULL VOLUME MULLION VOL DISP DISPENSER SIMILAR INDICATION VINYL TILE DEAD LOAD DI DETAIL SECTION VINYL WALL COVERING NORTH VWC DN DOWN N/A NIC NLB **DAMPPROOFING** NOT APPLICABLE $\underline{\mathbf{W}}$ SHEET NUMBER NOT IN CONTRACT WOOD DR DOOR NON-LOAD BEARING DS DOWNSPOUT NO NOM NUMBEF **ELEVATION NUMBER** DWG DRAWING DWR DRAWER NOMINAL **TRANSFORMER** NTS NOT TO SCALE **EXISITING EXTERIOR ELEVATION** OC OD OFF ON CENTER A101 EAST OUTSIDE DIAMETE SHEET NUMBER EACH FACE OFFICE OVERHEAD OH EG FOR EXAMPLE **EPOXY GLAZED COATING** OPPOSITE HAND EGC OPNG OPENING **EXPANSION JOINT ELEVATION NUMBER** OPP ELEC **ELECTRICAL** OPPOSITE HAND OUNCE(S) ELEVATOR/ELEVATION ELEV INTERIOR ELEVATION **ENCL ENCLOSURE** PASCAL **ENTR** ENTRANCE PC PCF PORTLAND CEMENT SHEET NUMBER EQ **EQUAL EQUIPMENT** POUNDS PER CUBIC FOILT EQUIP POLISH FINISH EXTERIOR INSULATION PFB **PREFABRICATE** & FINISH SYSTEM ARCHITECTURE / INTERIORS SYMBOLS PLAM PLASTIC LAMINAT **ESCALATOR** PLASTER EST ESTIMATED PLF POUNDS PER LINEAR FOC EW **EACH WAY** PNL EXH **EXHAUST** PARTITION NUMBER PNT POLY PAINT **EXIST** EXISTING PARTITION TYPE POLYETHYLENE EXP EXPANSION/EXPANDED PR PRESS T EXT EXTERIOR PRESSURE TREATE PRF PSF **PREFINISHE** FLAME/FLUSH POUNDS PER SQUARE FOO FIRE ALARM FBG FOIL-BACKED GYPSUM BOARD PRECAST PRCST FDN **FOUNDATION** FORCED-ENTRY/BALLISTIC-RESISTANT POLYVINYL CHLORIDE FE/BR DOOR SYMBOL PWD PLYWOOD FEW FIRE EXTINGUISHER WALL MOUNTED **PARTITION** FIG **FIGURE** DOOR OR BORROWED PRESSURE TREATED WOOD FIN **FINISH** LIGHT NUMBER FIXT FIXTURE QUARRY TILE FLASH FLOOR EXTERIOR WINDOW FLEX FLEXIBLE QTB QUARRY TILE BASE SYMBOL QUAL QUALITY **FLUORESCENT** FLUOR FACTORY MUTUAL RESEARCH CORP. WINDOW NUMBER FACE OF FRT FIRE RETARDANT TREATED FOOT/FEET FOOTING FURNITURE/FURNISHED **FURN FURR FURRING ROOM NAME**

ROOM NAME

100

ROOM NUMBER


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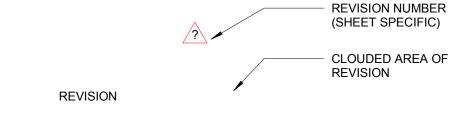
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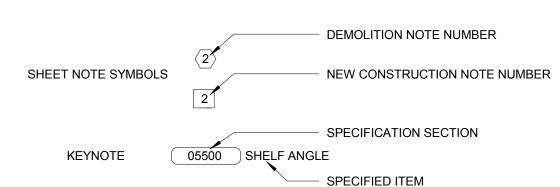
GENERAL NOTES:

- . CONTRACTOR SHALL AT ALL TIMES RETAIN AN APPROVED SET OF PERMIT DRAWINGS ON THE CONSTRUCTION PREMISE
- 2. CONTRACTOR SHALL BE RESPONSIBLE FOR OBTAINING ADDITIONAL TRADE PERMITS FOR ELECTRICAL, MECHANICAL ETC. WORK AS REQUIRED
- 3. CONTRACTOR SHALL COMPLY WITH THE BUILDING RULES AND REGULATIONS FOR WORKING HOURS, DELIVERY AND HANDLING OF MATERIAL, AND CONSTRUCTION WASTE REMOVAL.
- 4. IN ORDER TO FACILITATE MINIMUM DISRUPTION TO ROUTINE OPERATIONS OF THE STATION, THE CONTRACTOR SHALL BE REQUIRED TO SCHEDULE PORTIONS OF THE CONSTRUCTION DURING WEEKENDS, AND AFTER HOURS.
- 5. DO NOT SHORE OR HANDLE ANY CONSTRUCTION MATERIAL IN THE PATH TO EGRESS UNDER ANY CIRCUMSTANCES
- 6. DURING CONSTRUCTION, PORTIONS OF THE BUILDING OUTSIDE OF THE SCOPE OF WORK SHALL REMAIN OCCUPIED AND OPERATIONAL. OCCUPIED PORTIONS OF THE STRUCTURE WILL BE SEPARATED FROMORTIONS OF THE STRUCTURE UNDERGOING ALTERATION, CONSTRUCTION, OR DEMOLITION OPERATIONS BY TEMPORARY WALLS WITH A MINIMUM 1-HR FIRE RESISTANCE RATING IN ACCORDANCE WITH NFPA 241 §8.6.2. OPENING PROTECTIVES WILL HAVE AT LEAST A 45 MINISTE FIRE PROTECTION RATING
- 7. EXTREME CARE SHALL BE EXERCISED IN CUTTING, DRILLING OR ANCHORING TO THE EXISTING STRUCTURE. IF ANY DETERIORATION OR DAMAGE TO THE EXISTING STRUCTURE OCCURS DURING CONSTRUCTION, IT SHALL BE IMMEDIATELY REPORTED TO THE CITY AND ARCHITECT-ENGINEER OF RECORD.
- CONTRACTOR SHALL BE RESPONSIBLE FOR SCHEDULING ALL CONSTRUCTION INSPECTION WITH APPROPRIATE CODE OFFICER DURING CONSTRUCTION AS REQUIRED.
- 9. CONTRACTOR IS RESPONSIBLE FOR ALL TEMPORARY SHORING, SUPPORT AND PROTECTION OF EXISTING CONDITIONS TO REMAIN DURING CONSTRUCTION.
- 10. CONTRACTOR IS RESPONSIBLE FOR MAINTAINING SAFE WORK ENVIRONMENT AND COMPLIANCE WITH OSHA SAFETY STANDARD DURING CONSTRUCTION.
- 11. CONTRACTOR SHALL COORDINATE WITH THE CITY FOR TEMPORARY SHUT DOWN OF ANY BUILDING SYSTEM DURING CONSTRUCTION.
- 12. REMOVE ANY NAILS, SCREWS, SURFACE MOUNTED RACEWAY, HARDWARE, NON-FUNCTIONING ELECTRICAL DEVICES AND OTHER EXPOSED ITEMS ON EXISTING WALLS/PORTIONS IN THE AREA OF NEW WORK.
- 13. PATCH AND REPAIR RESULTING WALL/PARTITION DAMAGE AS REQUIRED PREPARING SURFACES TO RECEIVE NEW FINISHES AS SCHEDULED.
- 14. CONTRACTOR SHALL AT ALL TIMES KEEP THE PREMISE CLEAN AND FREE OF ACCUMULATIONS OF WASTE MATERIAL AND RUBBISH CAUSED BY THE CONSTRUCTION.
- 15. MANUFACTURER NAMES AND PRODUCTS ARE INDICATED ON DRAWINGS TO INDICATE MINIMUM PERFORMANCE CRITERIA. EQUALS OR COMPARABLE MAY BE SUBMITTED FOR REVIEW DURING THE SUBMITTAL PROCESS.
- 16. CONTRACTOR SHALL FULLY COMPLY WITH ALL REQUIREMENTS OF "GENERAL CONDITIONS" FURNISHED BY THE CITY
- 17. CONTRACTOR SHALL COORDINATE CONSTRUCTION PHASING WITH THE CITY. PRIOR TO COMMENCEMENT OF ANY CONSTRUCTION ACTIVITY.
- 8. ALL DIMENSIONS FOR NEW WALLS ARE FROM FACE OF STUD FRAMING UNLESS OTHERWISE NOTED.
- 19. ALL DIMENSIONS FOR NEW INTERIOR DOORS ARE TO THE CENTER OF DOORS, UNLESS OTHERWISE NOTED.
- 20. ALL EXISTING CONDITIONS, UTILITY SURVEY, ELEVATIONS & DIMENSIONS TO BE FIELD VERIFIED BY GENERAL CONTRACTOR.
- 21. CONTRACTOR SHALL PROVIDE A SITE UTILIZATION PLAN AND SUBMIT IT TO THE CITY OF GAITHERSBURG DEPARTMENT OF PUBLIC WORKS FOR APPROVAL.
- 22. CONTRACTOR SHALL OBTAIN WSSC PERMIT PRIOR TO COMMENCEMENT OF ANY PLUMBING INSTALLATION.
- 23. CONTRACTOR SHALL SURVEY AND VERIFY AND CONFIRM ALL WET AND DRY UNDERGROUND UTILITY AND CONFIRM ELEVATIONS

NORTH ARROW W E TRUE NORTH





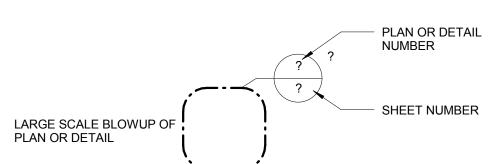

STANDARD AND AUTHORITY ALL WORK RELATED TO THIS PROJECT SH PERFORMED IN ACCORDANCE WITH THE R

ALL WORK RELATED TO THIS PROJECT SHALL BE PERFORMED IN ACCORDANCE WITH THE FOLLOWING CODES, AND CRITERIA AS APPLICABLE.

2012 International Building Code (IBC)

APPLICABLE CODES,

- 2012 International Building Gode (IBC)
 2012 International Mechanical Code (IMC)
- 2012 International Fuel Gas Code (IFGC)
- 2012 International Energy Conservation Code (IECC)
 2012 Life Safety Code NFPA 101(LSC)
- 2011 National Electric Code NFPA 70 (NEC)
- Maryland Accessibility Code ADAAG/2010
 Fire Safety Codes The Fire Safety Code of
- Montgomery County, Maryland, as it existed on August 1 1996, being Chapter 22 of the Montgomery County Code, 1984 (1994 Replacement Volume), the 2012 Editions of the National Fire Protection Association Uniform Fire Code (NFPA 1) and Life Safety Code® (NFPA 101®), all associated NFPA codes or standards incorporated by reference, and the latest editions of certain other NFPA codes not incorporated by reference into NFPA 1 or NFPA 101®

APPROVING AUTHORITY: City of Gaithersburg Planning and Code Administration Permits and Inspections 31 S. Summit Ave. Gaithersburg, MD 20877 301-258-6330 301-258-6336 (fax)

- Plumbing and natural gas
 Plumbing and natural are under the authority of the
 Washington Suburban Sanitary Commission (WSSC),
 which currently uses the 2012 International Plumbing
 Code (IPC) and the 2012 International Fuel Gas Code
 (IECC)
- Health review, when required, is performed by the Montgomery County Department of Health and Human Services, Regulatory Division 240-777-398



MINIATURE GOLF PARK OFFICE BUILDING RENOVATION

514 S Frederick Ave, Gaithersburg, MD 20877



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Professional Certification.

I certify that these documents were prepared or approved by me, and that I am a duly licensed architect under the laws of the State of Maryland, license number 15975, expiration date 10.16.2015

No.	Description	Date
1	REVISION # 1	06/30/2016
2	REVISION # 2	07/12/2016

Drawing Title

GENERAL NOTES,
ABBREVIATIONS & SYMBOLS




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Sheet Number

A002

CADD Plot Scale

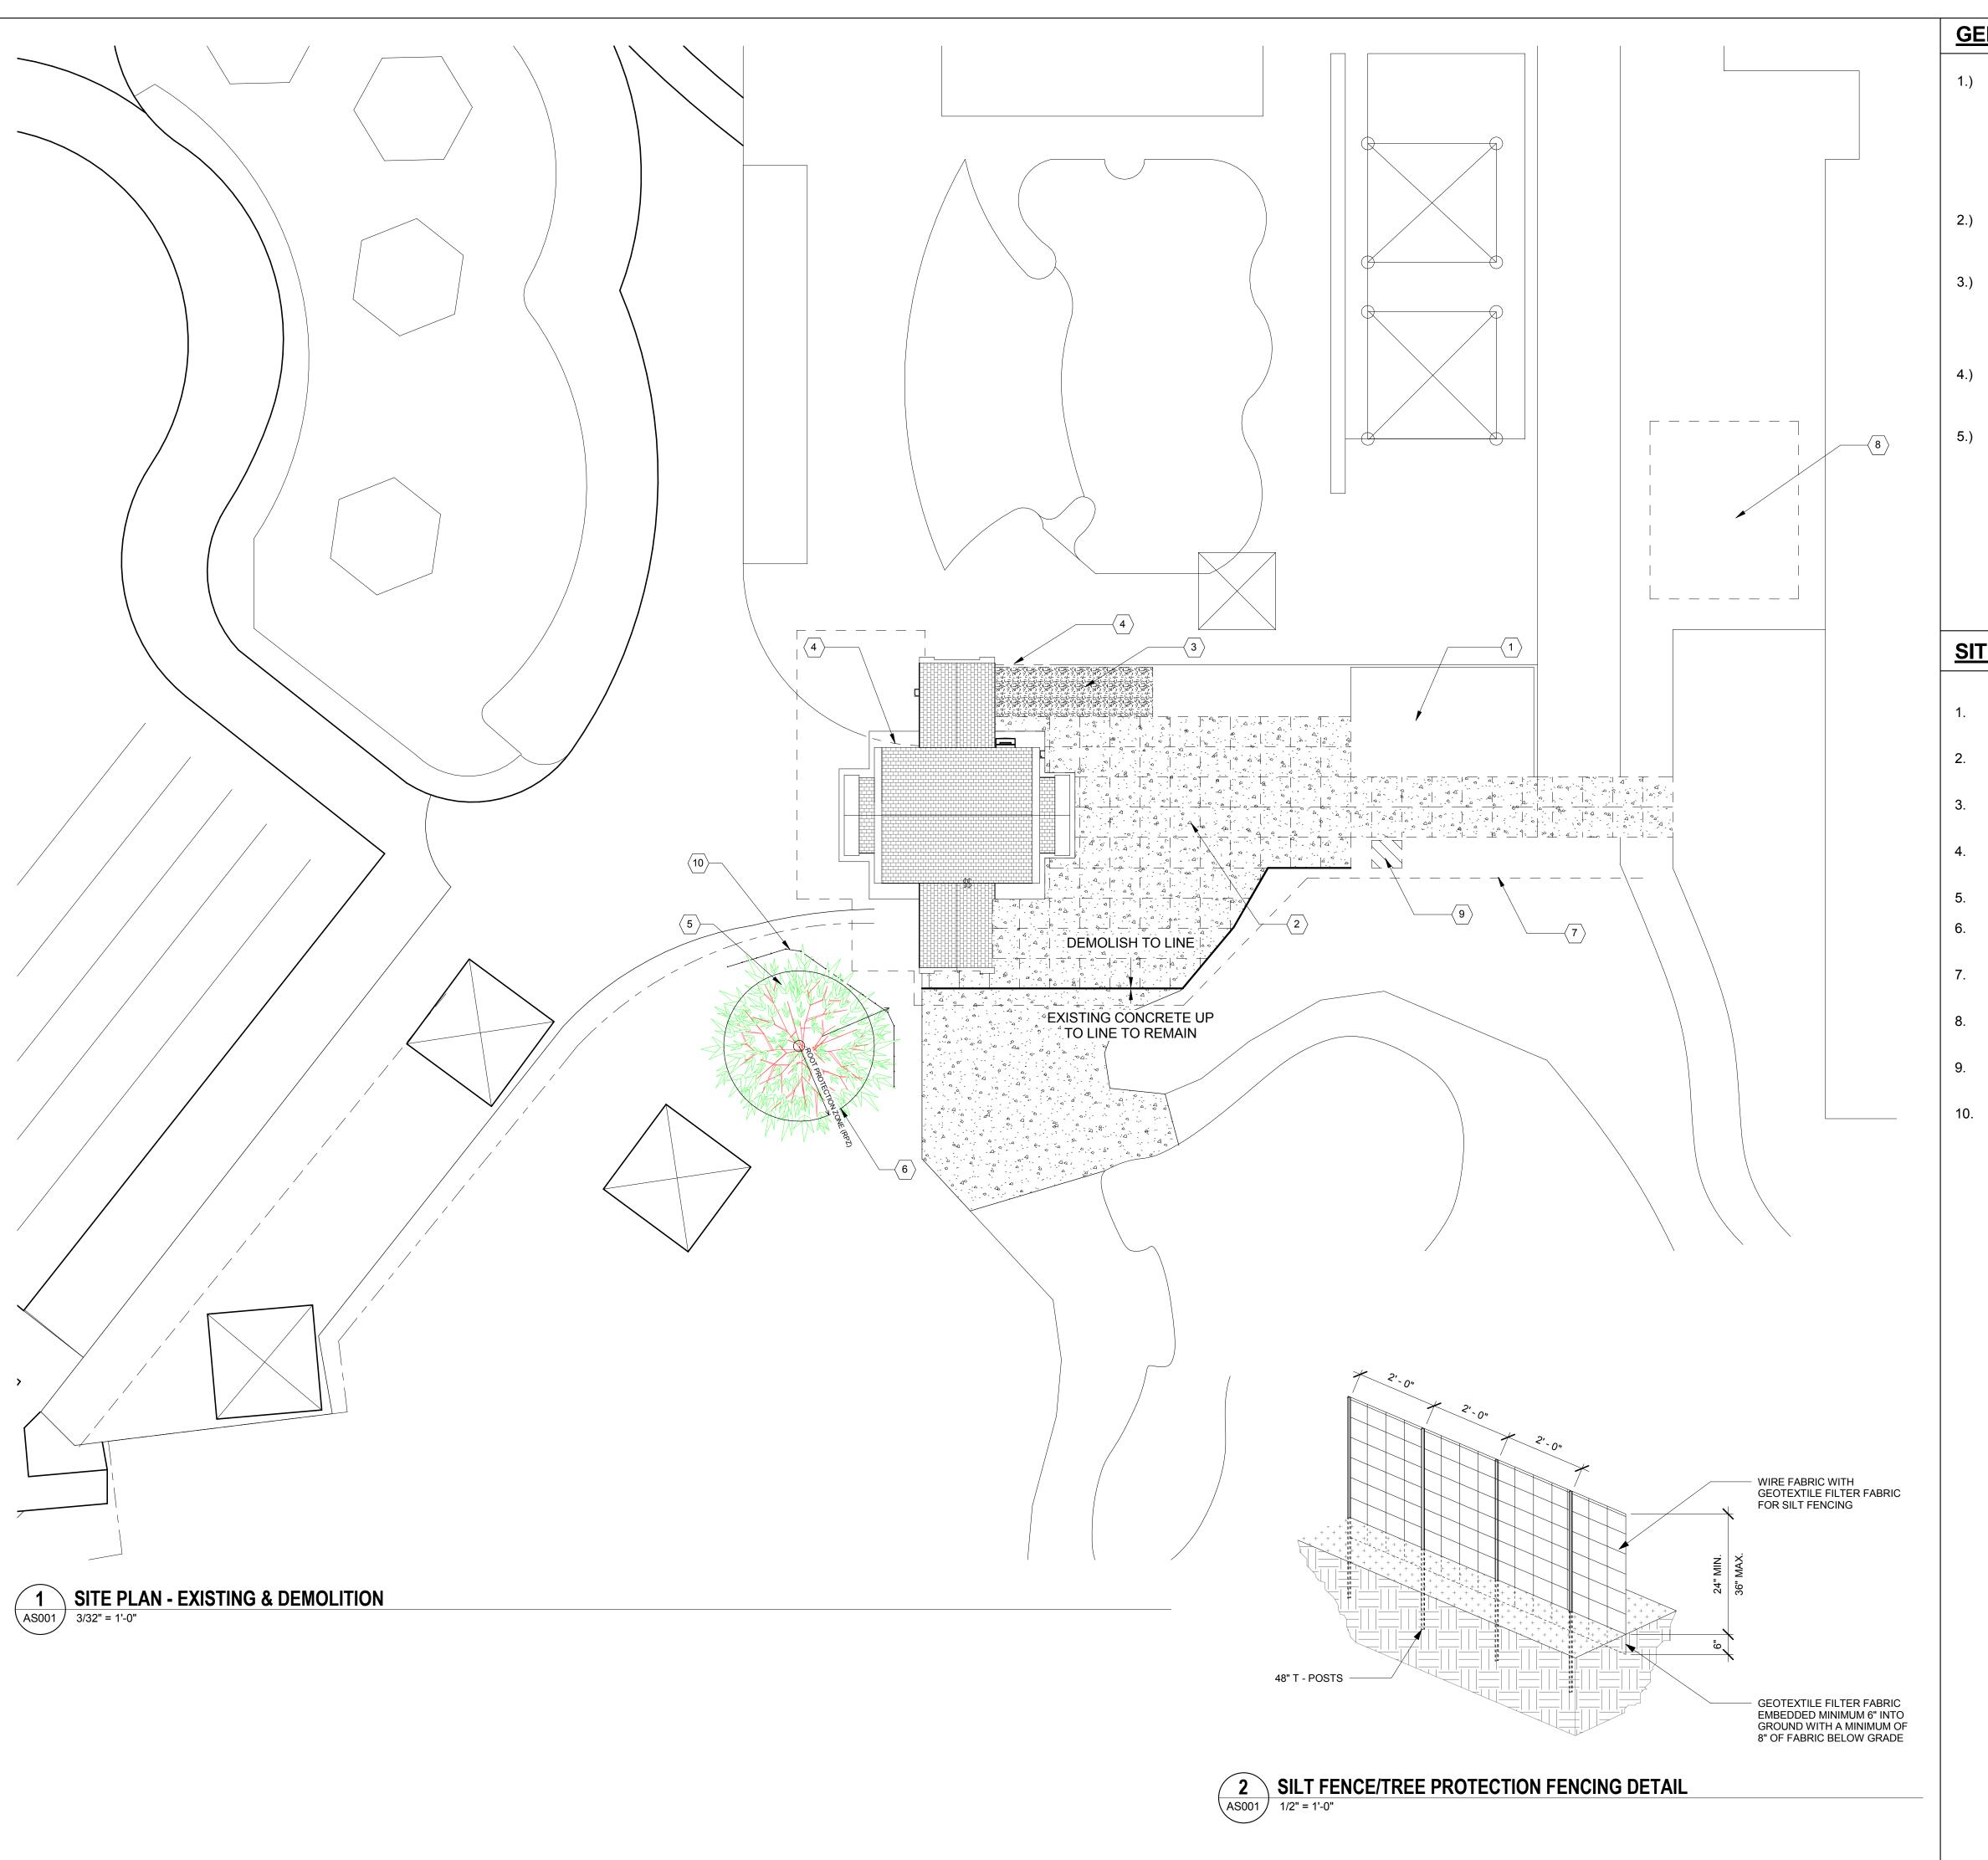

GENERAL SITE PLAN NOTES

- 1.) AT ALL TIMES DURING CONSTRUCTION, THE CONTRACTOR SHALL BE RESPONSIBLE FOR MAINTAINING SAFE WORKING ENVIRONMENT PER OSHA STANDARDS. ROOF INSTALLERS SHALL BE CERTIFIED AND EXPERIENCED. THE CREW MEMBERS AND SUPERVISORS SHALL WEAR ALL REQUIRED PERSONAL PROTECTION EQUIPMENT, SAFE SAFETY HARNESS AND USE SECURED SHORING.
- 2.) THE SUBSTRATE MUST BE SECURELY FASTENED TO STRUCTURE. IF IT IS FOUND UNSTABLE, IMMEDIATELY NOTIFY THE ARCHITECT AND THE OWNER.
- 3.) THE SUBSTRATE MUST BE CLEAN, DRY, STRUCTURALLY SOUND, FREE OF LOOSE MATERIAL, VOIDS, PROJECTIONS, HOT SPOTS, RELEASE AGENTS, COATINGS, OR OTHER MATERIALS THAT MAY AFFECT
- 4.) THERE SHALL BE NO PLANAR IRREGULARITIES GREATER THAN 6.4 MM (1/4 IN) WITHIN ANY 1.2 (4 FT)
- 5.) PRODUCTS AND INSTALLATION SHALL BE SUBJECTED TO A WRITTEN WARRANTY FROM THE CONTRACTOR FOR A PERIOD OF 20 YEARS MINIMUM, WITH PROVISION TO RENDER ALL SERVICES NECESSARY TO MITIGATE ANY AND ALL DAMAGE TO THE PROPERTY IF OCCURS DURING THE WARRANTED PERIOD DUE TO FAILURE OF ROOFING, AT NO COST TO THE GOVERNMENT (OWNER).

Gaithersburg A CHARACTER COUNTS! CITY

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SITE DEMOLITION WORK NOTES

- EXISTING CONCRETE SLAB IN PICNIC TABLE AREA TO
- EXISTING CONCRETE SLAB TO BE DEMOLISHED AND REPLACED.
- EXISTING ASPHALT PAVING AREA TO BE DEMOLISHED AND REPLACED WITH CONCRETE.
- EXISTING FENCING TO BE DEMOLISHED TO ACCOMODATE NEW CONSTRUCTION.
- PROTECT EXISTING TREE.
- MAINTAIN PROTECTION ZONE CLEAR OF CONSTRUCTION ACTIVITY.
- CONSTRUCTION FENCING. COORDINATE WITH CITY'S APPOINTED PROTECTION MANAGER.
- PROPOSED LAYDOWN AREA. COORDINATE WITH CITY'S APPOINTED PROTECTION MANAGER.
- 9. EXCAVATE EARTH TO CREATE LOCATION OF NEW LIGHTING/AMPLIFIER POLE.
- 10. INSTALL NEW SILT / TREE PROTECTION FENCING TO ESTABLISH A PROTECTIVE ZONE AROUND EXISTING

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Revisions		

SITE PLAN - EXISTING & **DEMOLITION**

CONCEPT 35% 60% 80% 100%


A/E Project Number



AS001

Drawing Scale: AS NOTED

Revit Model

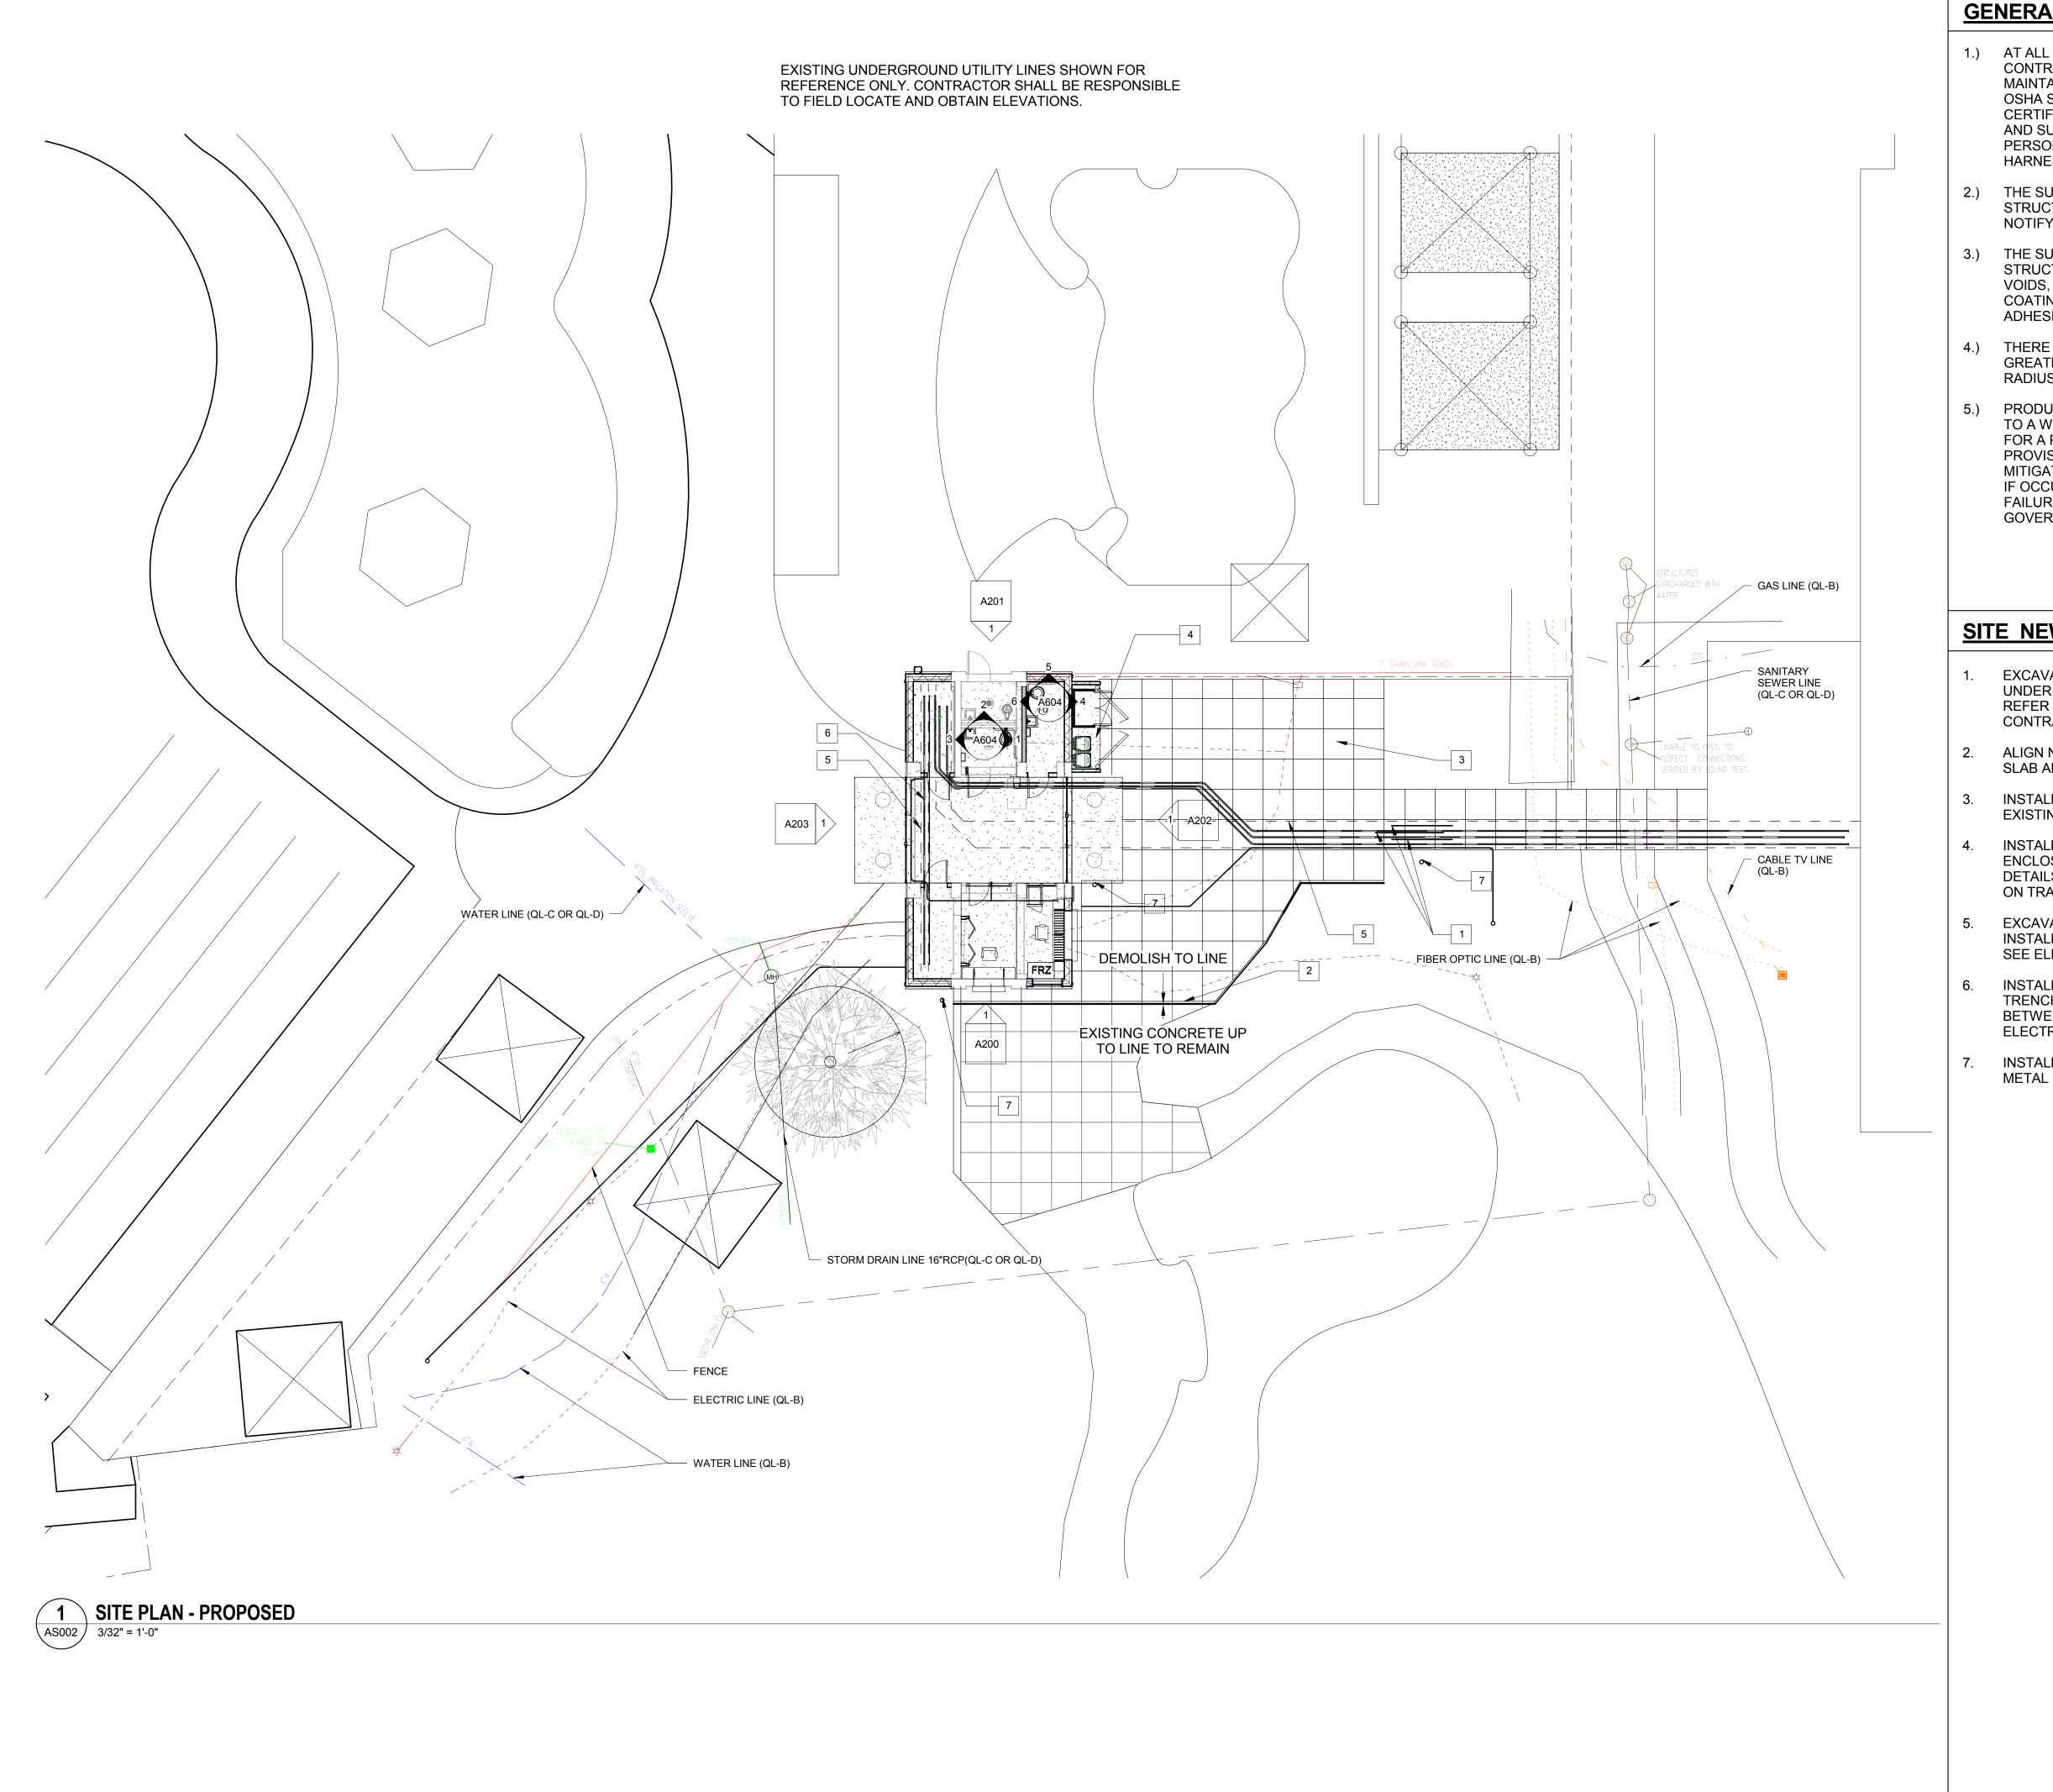

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SITE NEW WORK NOTES

- 1. EXCAVATE TRENCH AND INSTALL ELECTRICAL CONDUIT UNDER NEW SLAB TO EXISTING COMMUNITY CENTER. REFER TO SHEET ES101 FOR SIZE AND QUANTITY. CONTRACTOR SHALL FIELD DETERMINE ROUTING.
- 2. ALIGN NEW CONCRETE SLAB TO ELEVATION OF EXISTING SLAB ALONG EDGE OF EXISTING SLAB.
- 3. INSTALL NEW CONCRETE SLAB WITH PROFILE TO MATCH EXISTING 4' X 4' SQUARES.
- 4. INSTALL NEW CONCRETE SLAB FOR NEW TRASH ENCLOSURE AND STORAGE. SEE ARCH A601 FOR DETAILS
- ON TRASH ENCLOSURE FENCING.
- 5. EXCAVATE NEW TRENCHING FOR CONDUIT INSTALLATION.
 SEE ELECTRICAL E501 FOR DETAILS ON TRENCHING
- 6. INSTALL ELECTRICAL CONDUIT IN UNDERGROUND TRENCH
 BETWEEN NORTH AND SOUTH STORAGE ROOMS. SEE ELECTRICAL ES101 FOR DETAILS
- 7. INSTALL NEW 6" DIAMETER METAL POLE SEE E501 FOR METAL POLE BASE DETAIL

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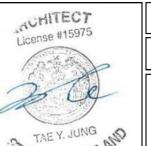
No.	Description	Date
1	REVISION # 1	06/30/2016
2	REVISION # 2	07/12/2016
		,

Revisions

Drawing Title

SITE PLAN - PROPOSED


SSE CONCEPT 35% 60% 80% 100%



Checked By AV

Sheet Number

AS002

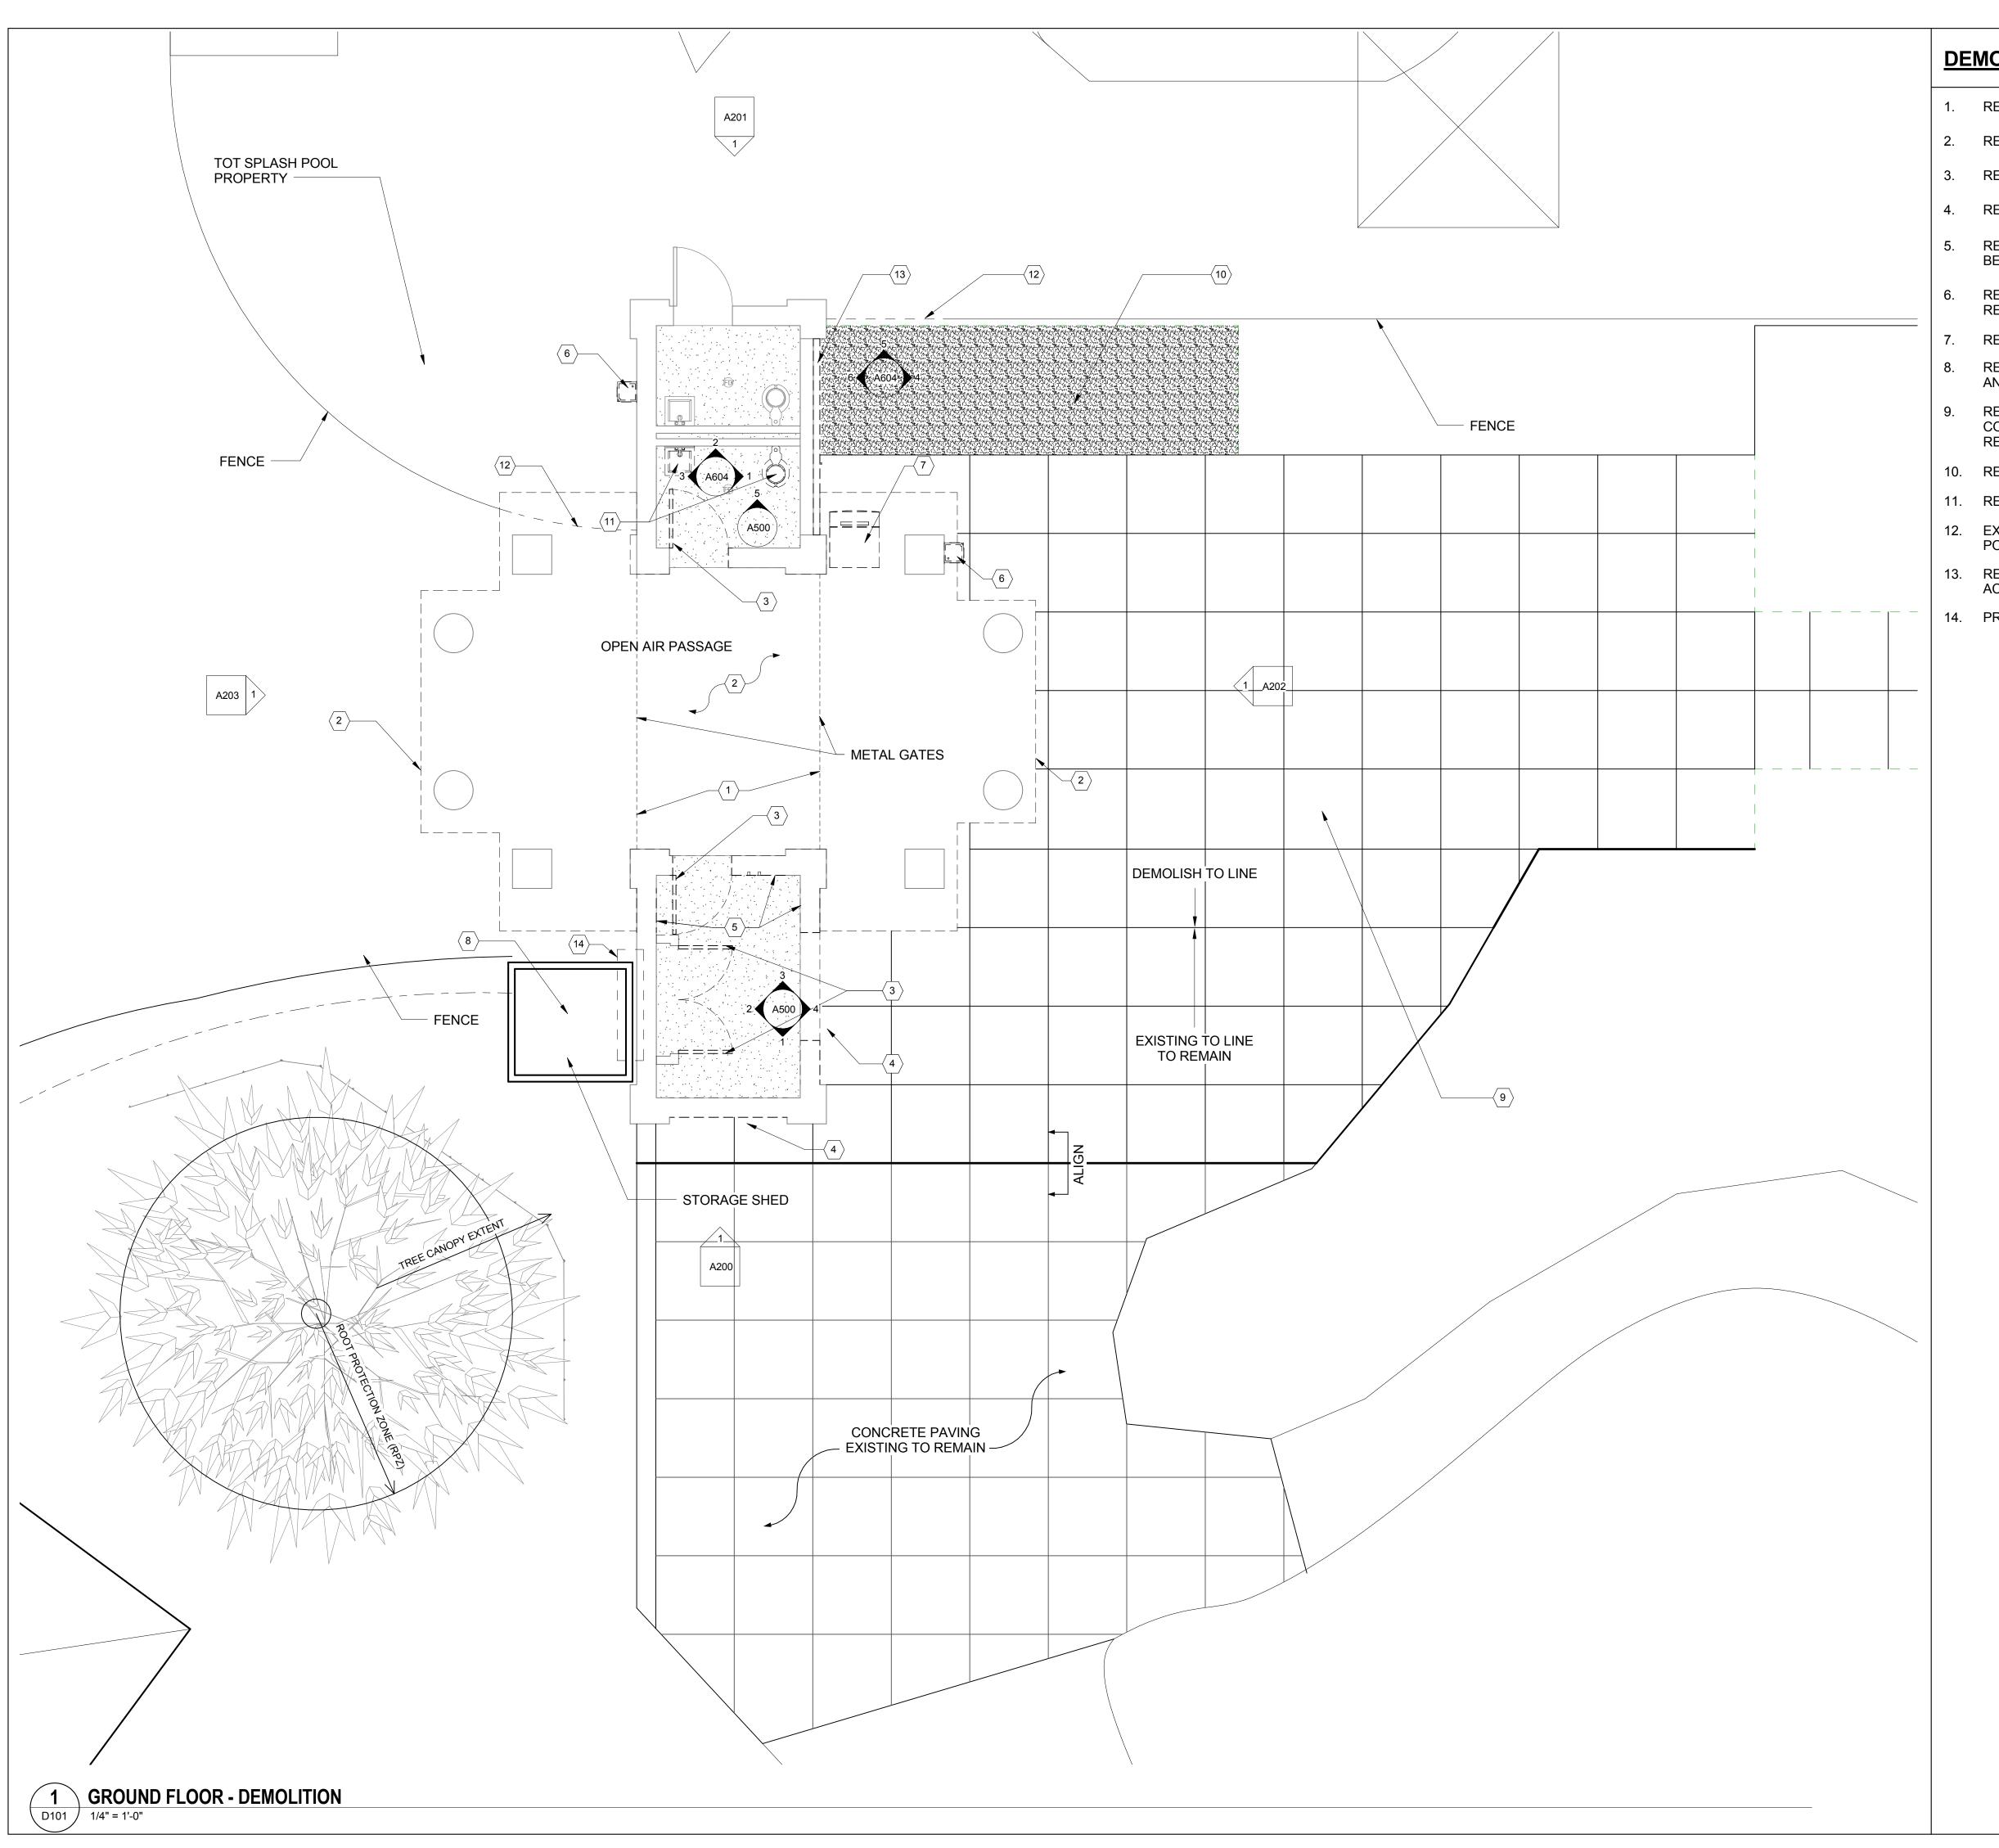

DEMOLITION LEGEND

- 1. REMOVE EXISTING METAL GATES AND HARDWARE
- 2. REMOVE EXISTING STONE PAVING TO BOUNDARY
- 3. REMOVE EXISTING DOOR
- 4. REMOVE EXISTING SHUTTER
- REMOVE EXISTING NON-BEARING INFILL TO BOTTOM OF BEAM ± 7'-4".
- REMOVE AND SALVAGE EXISTING WATER FOUNTAIN FOR RELOCATION. CAP EXISTING PLUMBING AT LOCATION.
- REMOVE EXISTING ICE MACHINE
- REMOVE EXISTING STORAGE SHED, ANY SUPPORTS OR ANCHORING, AND EXISTING ENTRY SLAB
- REMOVE CONCRETE FOR INSTALLATION OF NEW CONDUIT AND CORRECTION OF SLOPE FOR ADA REQUIREMENTS
- 10. REMOVE EXISTING ASPHALT PAVING
- 11. REMOVE EXISTING PLUMBING FIXTURES
- 12. EXISTING FENCING TO BE DEMOLISHED TO NEAREST POST TO ACCOMODATE NEW CONSTRUCTION
- 13. REMOVE 4" FACE BRICK OFF EXISTING WALL TO ACCOMODATE NEW INTERIOR PLUMBING WALL.
- 14. PROTECT AND MAINTAIN ELECTRICAL STUBS.



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No.	Description	Date
1	REVISION # 1	06/30/2016
2	REVISION # 2	07/12/2016
Doviniona		

GROUND FLOOR -**DEMOLITION**


D101

CONCEPT 35% 60% 80% 100%

ACHITECT	Drawn By ASM	
Date 06.30.2016	CADD Filename CADD Plot Scal Revit Model 1:1	
A/E Project Number 12-0009.012	Drawing Scale: AS NOTED	





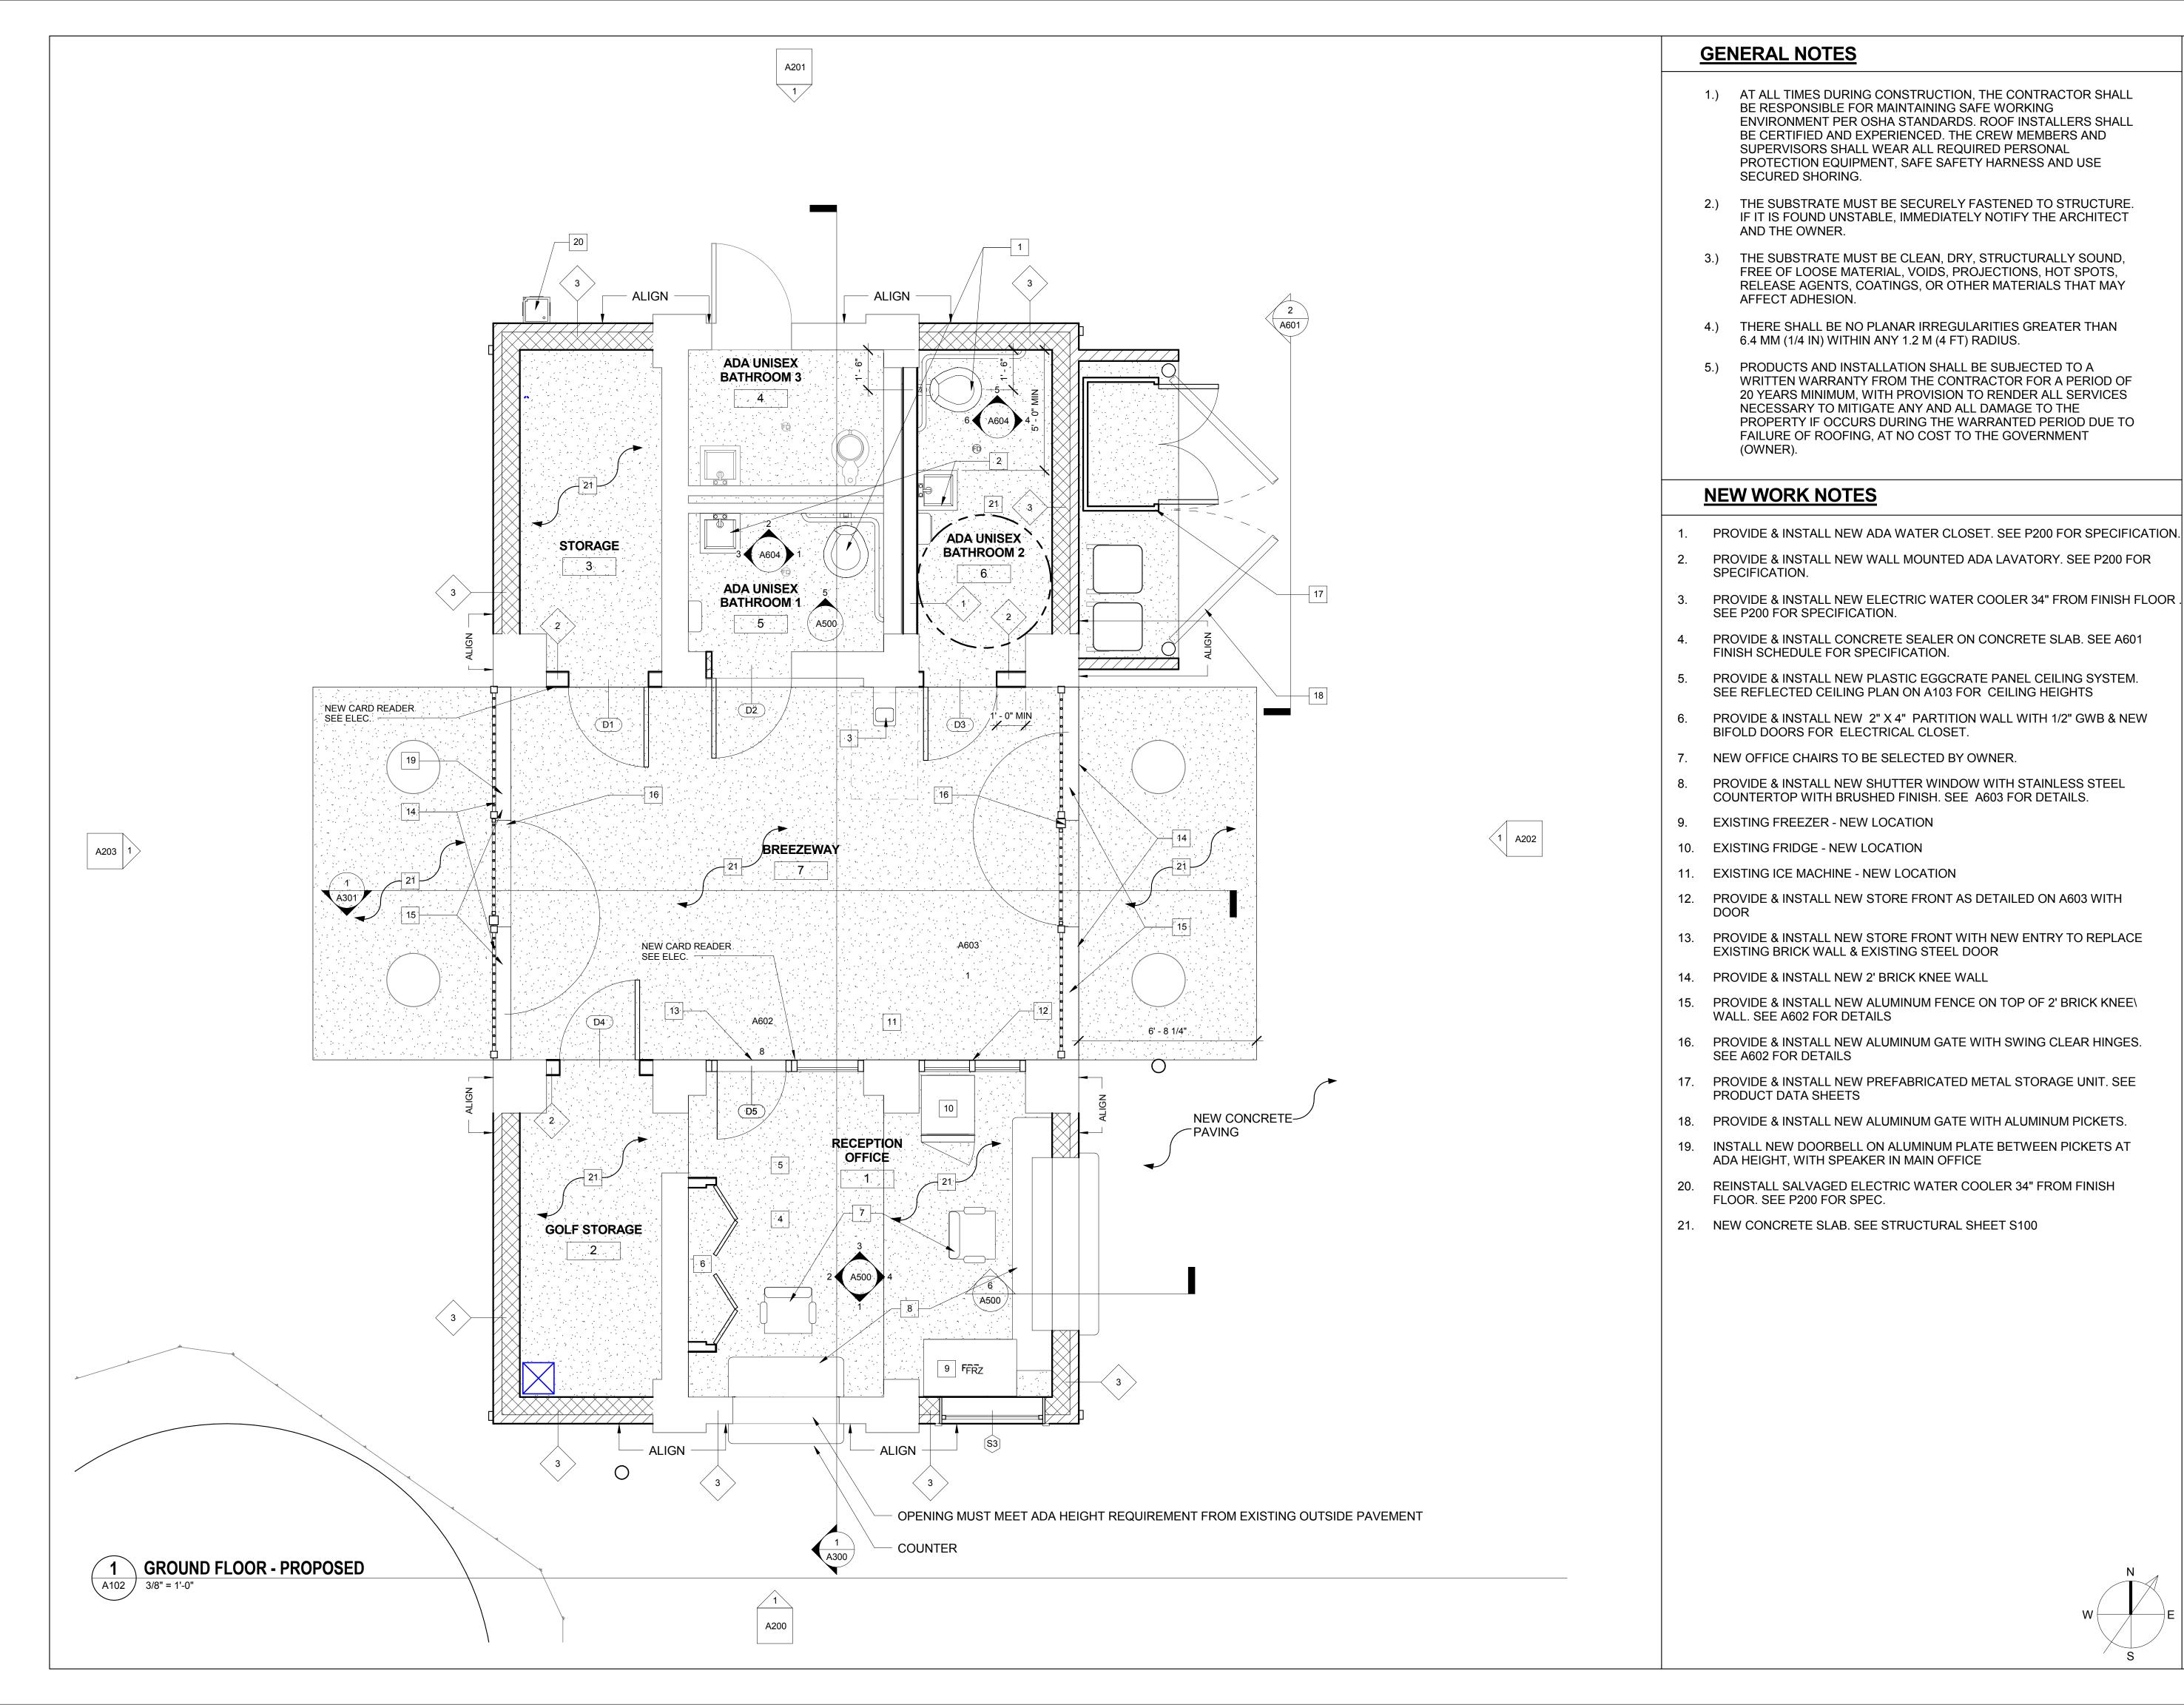

NEW WORK NOTES

SEE P200 FOR SPECIFICATION.

FINISH SCHEDULE FOR SPECIFICATION.

BIFOLD DOORS FOR ELECTRICAL CLOSET.

NEW OFFICE CHAIRS TO BE SELECTED BY OWNER.

EXISTING BRICK WALL & EXISTING STEEL DOOR

ADA HEIGHT, WITH SPEAKER IN MAIN OFFICE

WALL. SEE A602 FOR DETAILS

SEE A602 FOR DETAILS

PRODUCT DATA SHEETS

FLOOR. SEE P200 FOR SPEC.

SPECIFICATION.

- 1.) AT ALL TIMES DURING CONSTRUCTION, THE CONTRACTOR SHALL BE RESPONSIBLE FOR MAINTAINING SAFE WORKING ENVIRONMENT PER OSHA STANDARDS. ROOF INSTALLERS SHALL BE CERTIFIED AND EXPERIENCED. THE CREW MEMBERS AND SUPERVISORS SHALL WEAR ALL REQUIRED PERSONAL PROTECTION EQUIPMENT, SAFE SAFETY HARNESS AND USE SECURED SHORING.
- 2.) THE SUBSTRATE MUST BE SECURELY FASTENED TO STRUCTURE IF IT IS FOUND UNSTABLE, IMMEDIATELY NOTIFY THE ARCHITECT AND THE OWNER.
- 3.) THE SUBSTRATE MUST BE CLEAN, DRY, STRUCTURALLY SOUND, FREE OF LOOSE MATERIAL, VOIDS, PROJECTIONS, HOT SPOTS, RELEASE AGENTS, COATINGS, OR OTHER MATERIALS THAT MAY AFFECT ADHESION.
- 4.) THERE SHALL BE NO PLANAR IRREGULARITIES GREATER THAN 6.4 MM (1/4 IN) WITHIN ANY 1.2 M (4 FT) RADIUS.
- 5.) PRODUCTS AND INSTALLATION SHALL BE SUBJECTED TO A WRITTEN WARRANTY FROM THE CONTRACTOR FOR A PERIOD OF 20 YEARS MINIMUM, WITH PROVISION TO RENDER ALL SERVICES NECESSARY TO MITIGATE ANY AND ALL DAMAGE TO THE PROPERTY IF OCCURS DURING THE WARRANTED PERIOD DUE TO FAILURE OF ROOFING, AT NO COST TO THE GOVERNMENT (OWNER).

PROVIDE & INSTALL NEW WALL MOUNTED ADA LAVATORY. SEE P200 FOR

PROVIDE & INSTALL CONCRETE SEALER ON CONCRETE SLAB. SEE A601

PROVIDE & INSTALL NEW PLASTIC EGGCRATE PANEL CEILING SYSTEM.

SEE REFLECTED CEILING PLAN ON A103 FOR CEILING HEIGHTS

PROVIDE & INSTALL NEW SHUTTER WINDOW WITH STAINLESS STEEL COUNTERTOP WITH BRUSHED FINISH. SEE A603 FOR DETAILS.

PROVIDE & INSTALL NEW ELECTRIC WATER COOLER 34" FROM FINISH FLOOR

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GROUND FLOOR - PROPOSED


A102

CONCEPT 35% 60% 80% 100%

A/E Project Number Drawing Scale: AS NOTED Revit Model



Checked By AV

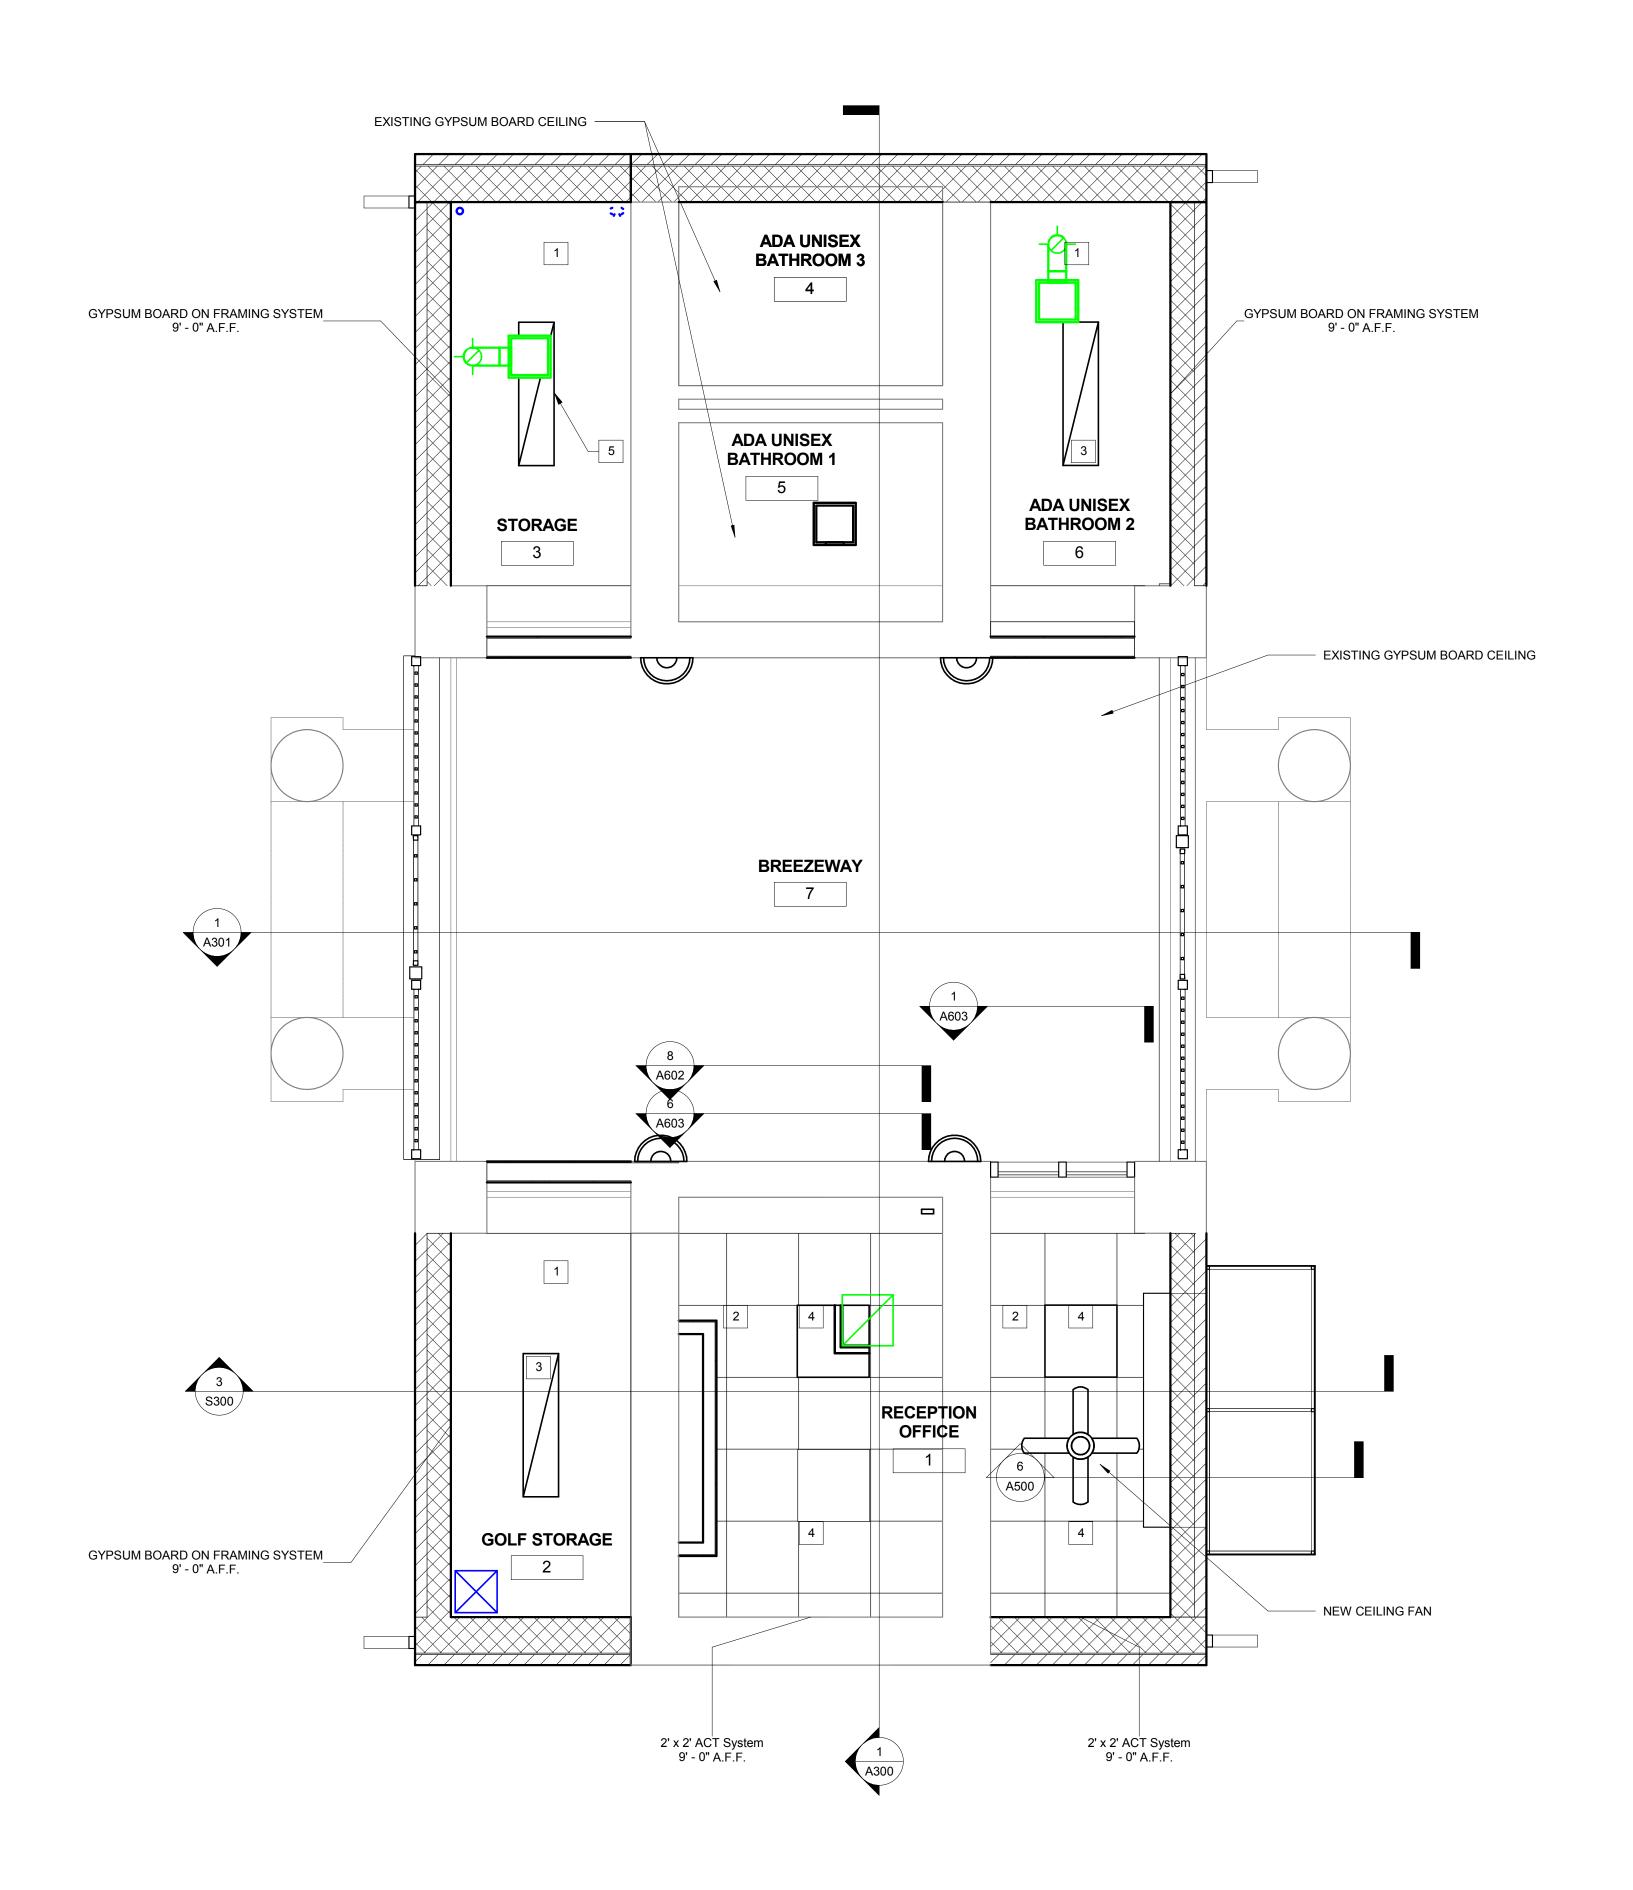

REFLECTED CEILING PLAN

A103 / 3/8" = 1'-0"

GENERAL NOTES

- 1.) AT ALL TIMES DURING CONSTRUCTION, THE CONTRACTOR SHALL BE RESPONSIBLE FOR MAINTAINING SAFE WORKING ENVIRONMENT PER OSHA STANDARDS. ROOF INSTALLERS SHALL BE CERTIFIED AND EXPERIENCED. THE CREW MEMBERS AND SUPERVISORS SHALL WEAR ALL REQUIRED PERSONAL PROTECTION EQUIPMENT, SAFE SAFETY HARNESS AND USE SECURED SHORING.
- 2.) THE SUBSTRATE MUST BE SECURELY FASTENED TO STRUCTURE. IF IT IS FOUND UNSTABLE, IMMEDIATELY NOTIFY THE ARCHITECT AND THE OWNER.
- 3.) THE SUBSTRATE MUST BE CLEAN, DRY, STRUCTURALLY SOUND, FREE OF LOOSE MATERIAL, VOIDS, PROJECTIONS, HOT SPOTS, RELEASE AGENTS, COATINGS, OR OTHER MATERIALS THAT MAY AFFECT ADHESION.
- 4.) THERE SHALL BE NO PLANAR IRREGULARITIES GREATER THAN 6.4 MM (1/4 IN) WITHIN ANY 1.2 M (4 FT) RADIUS.
- 5.) PRODUCTS AND INSTALLATION SHALL BE SUBJECTED TO A WRITTEN WARRANTY FROM THE CONTRACTOR FOR A PERIOD OF 20 YEARS MINIMUM, WITH PROVISION TO RENDER ALL SERVICES NECESSARY TO MITIGATE ANY AND ALL DAMAGE TO THE PROPERTY IF OCCURS DURING THE WARRANTED PERIOD DUE TO FAILURE OF ROOFING, AT NO COST TO THE GOVERNMENT (OWNER).

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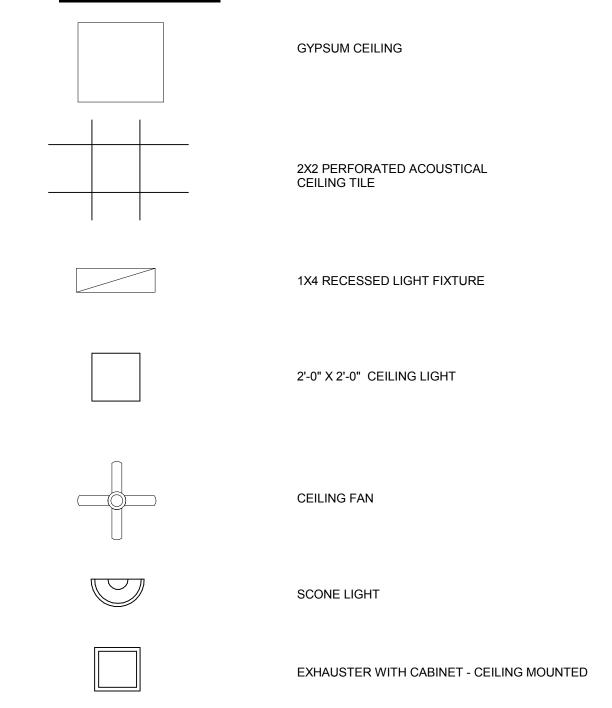


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NEW WORK LEGEND

- 1.) INSTALL NEW GYPSUM BOARD CEILING SYSTEM COMPRISED OF A FURRING CHANNEL @ 24" O.C. WITH 1/2" GYPSUM BOARD TAPED, FINISHED AND PAINTED.
- INSTALL NEW 2' X 2' ACOUSTICAL CEILING TILE SYSTEM.
- INSTALL NEW 1' X 4' CEILING MOUNTED LIGHT FIXTURE AS SPECIFIED ON
- INSTALL NEW 2' X 2' CEILING MOUNTED LIGHT FIXTURE AS SPECIFIED ON PAGE EL501.
- INSTALL NEW 1' X 4' CEILING MOUNTED LIGHT FIXTURE AS SPECIFIED ON PAGE EL501.

RCP LEGEND



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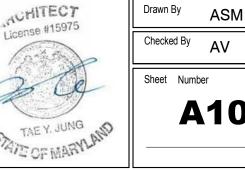
No.	Description	Date
1	REVISION # 1	06/30/2016
2	REVISION # 2	07/12/2016
<u> </u>		


REFLECTED CEILING PLAN

CONCEPT 35% 60% 80% 100%

A/E Project Number Drawing Scale: AS NOTED CADD Filename CADD Plot Scale Revit Model 1:1





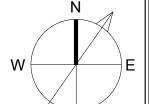

DEMOLITION NOTES

- 1. REMOVE ALL EXISTING GUTTERS FROM ROOF
- 2. REMOVE ALL EXISTING SHINGLE ROOFING AND UNDERLAYMENT FROM ENTIRE ROOF
- 3. REMOVE ALL EXISTING ROOF ACCENTS AND FLASHING AS NECESSARY FOR SHINGLE REPLACEMENT
- 4. DEMOLISH ROOF FAN

NEW WORK NOTES

ROOF PLAN - PROPOSED

- 1. PROVIDE AND INSTALL NEW GUTTER TO MATCH PROFILE AND FINISH OF EXISTING, WITH DOWNSPOUT TO DRAIN TO DAYLIGHT
- 2. INSTALL NEW ELASTOMERIC MEMBRANE AND ARCHITECTURAL 3D SHINGLES TO MATCH EXISTING WATERPARK ADMIN. BUILDING ON ENTIRE ROOF
- 3. INSTALL NEW ROOF ACCENTS AND FLASHING TO MATCH EXISTING



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No.	Description	Date
1	REVISION # 1	06/30/2016
2	REVISION # 2	07/12/2016
Revisions		

Revisions

Drawing Title


ROOF PLAN

CONCEPT 35% 60% 80% 100

 A/E Project Number
 Drawing Scale: AS NOTED

 12-0009.012
 CADD Filename
 CADD Plot Scale


 Revit Model
 1:1

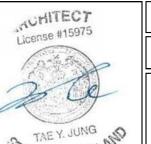



Checked By AV

Sheet Number

A104

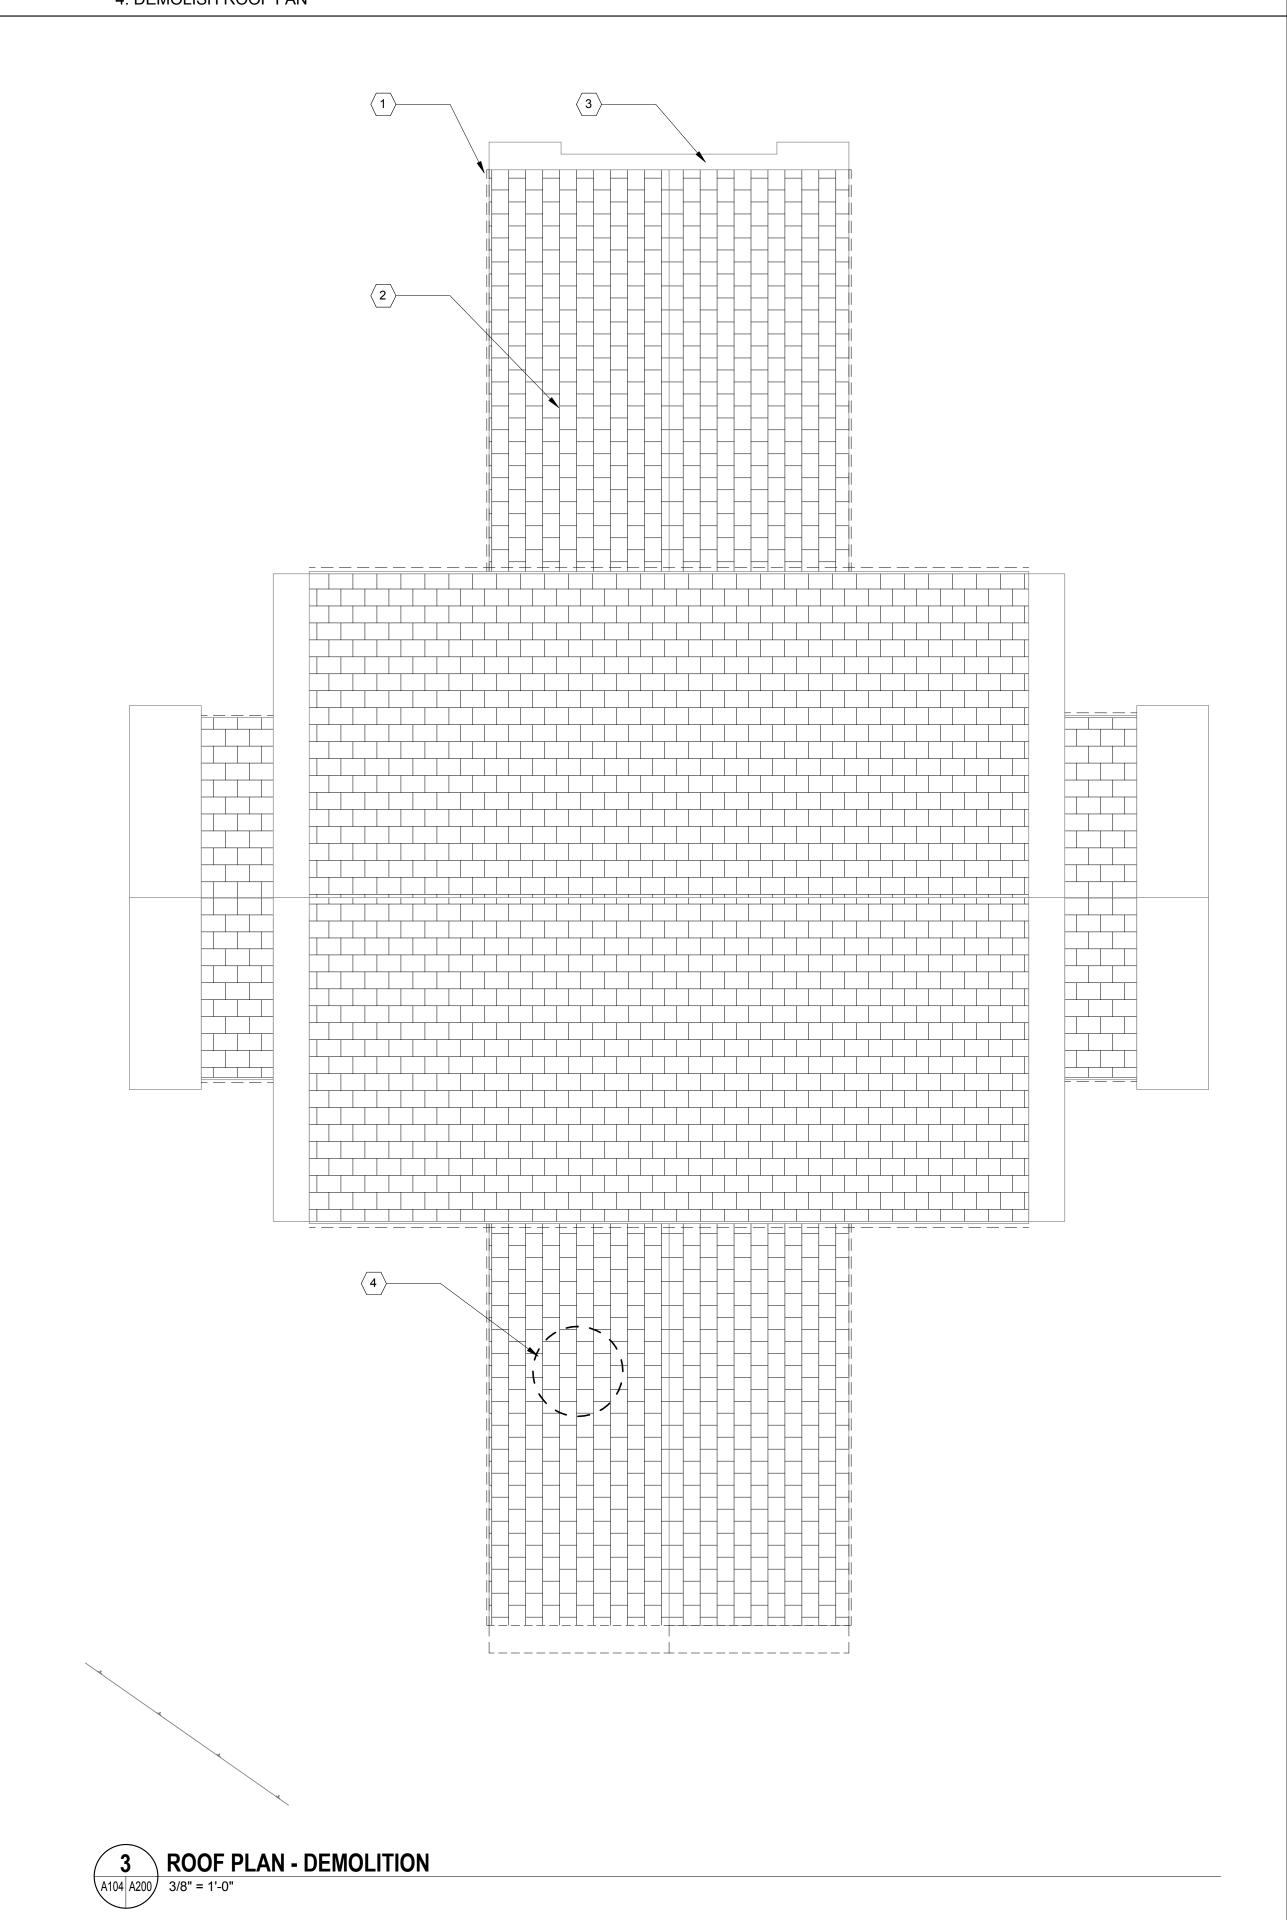

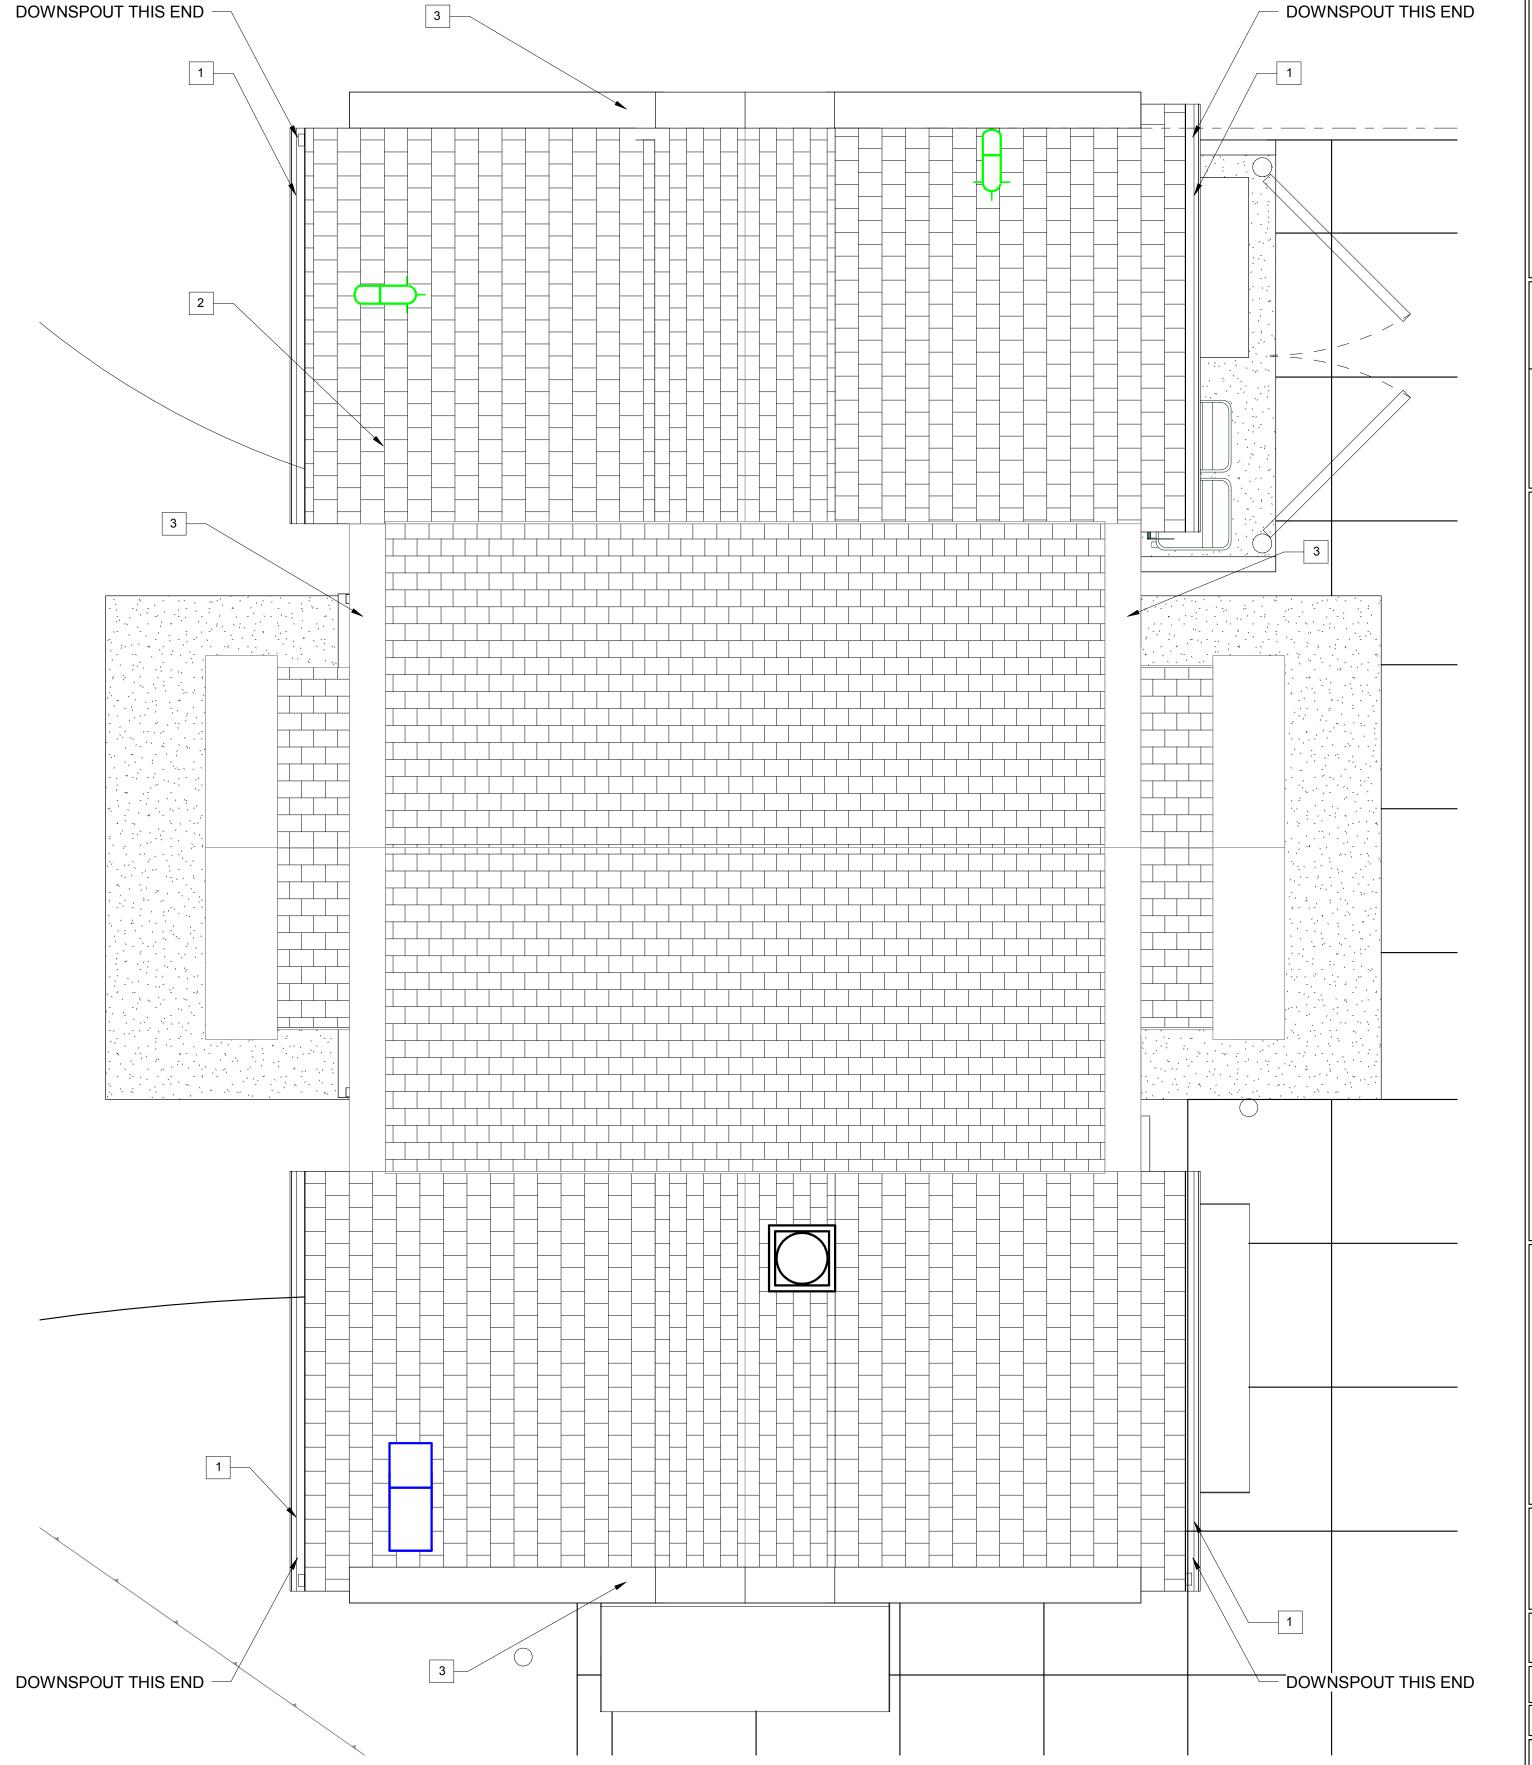

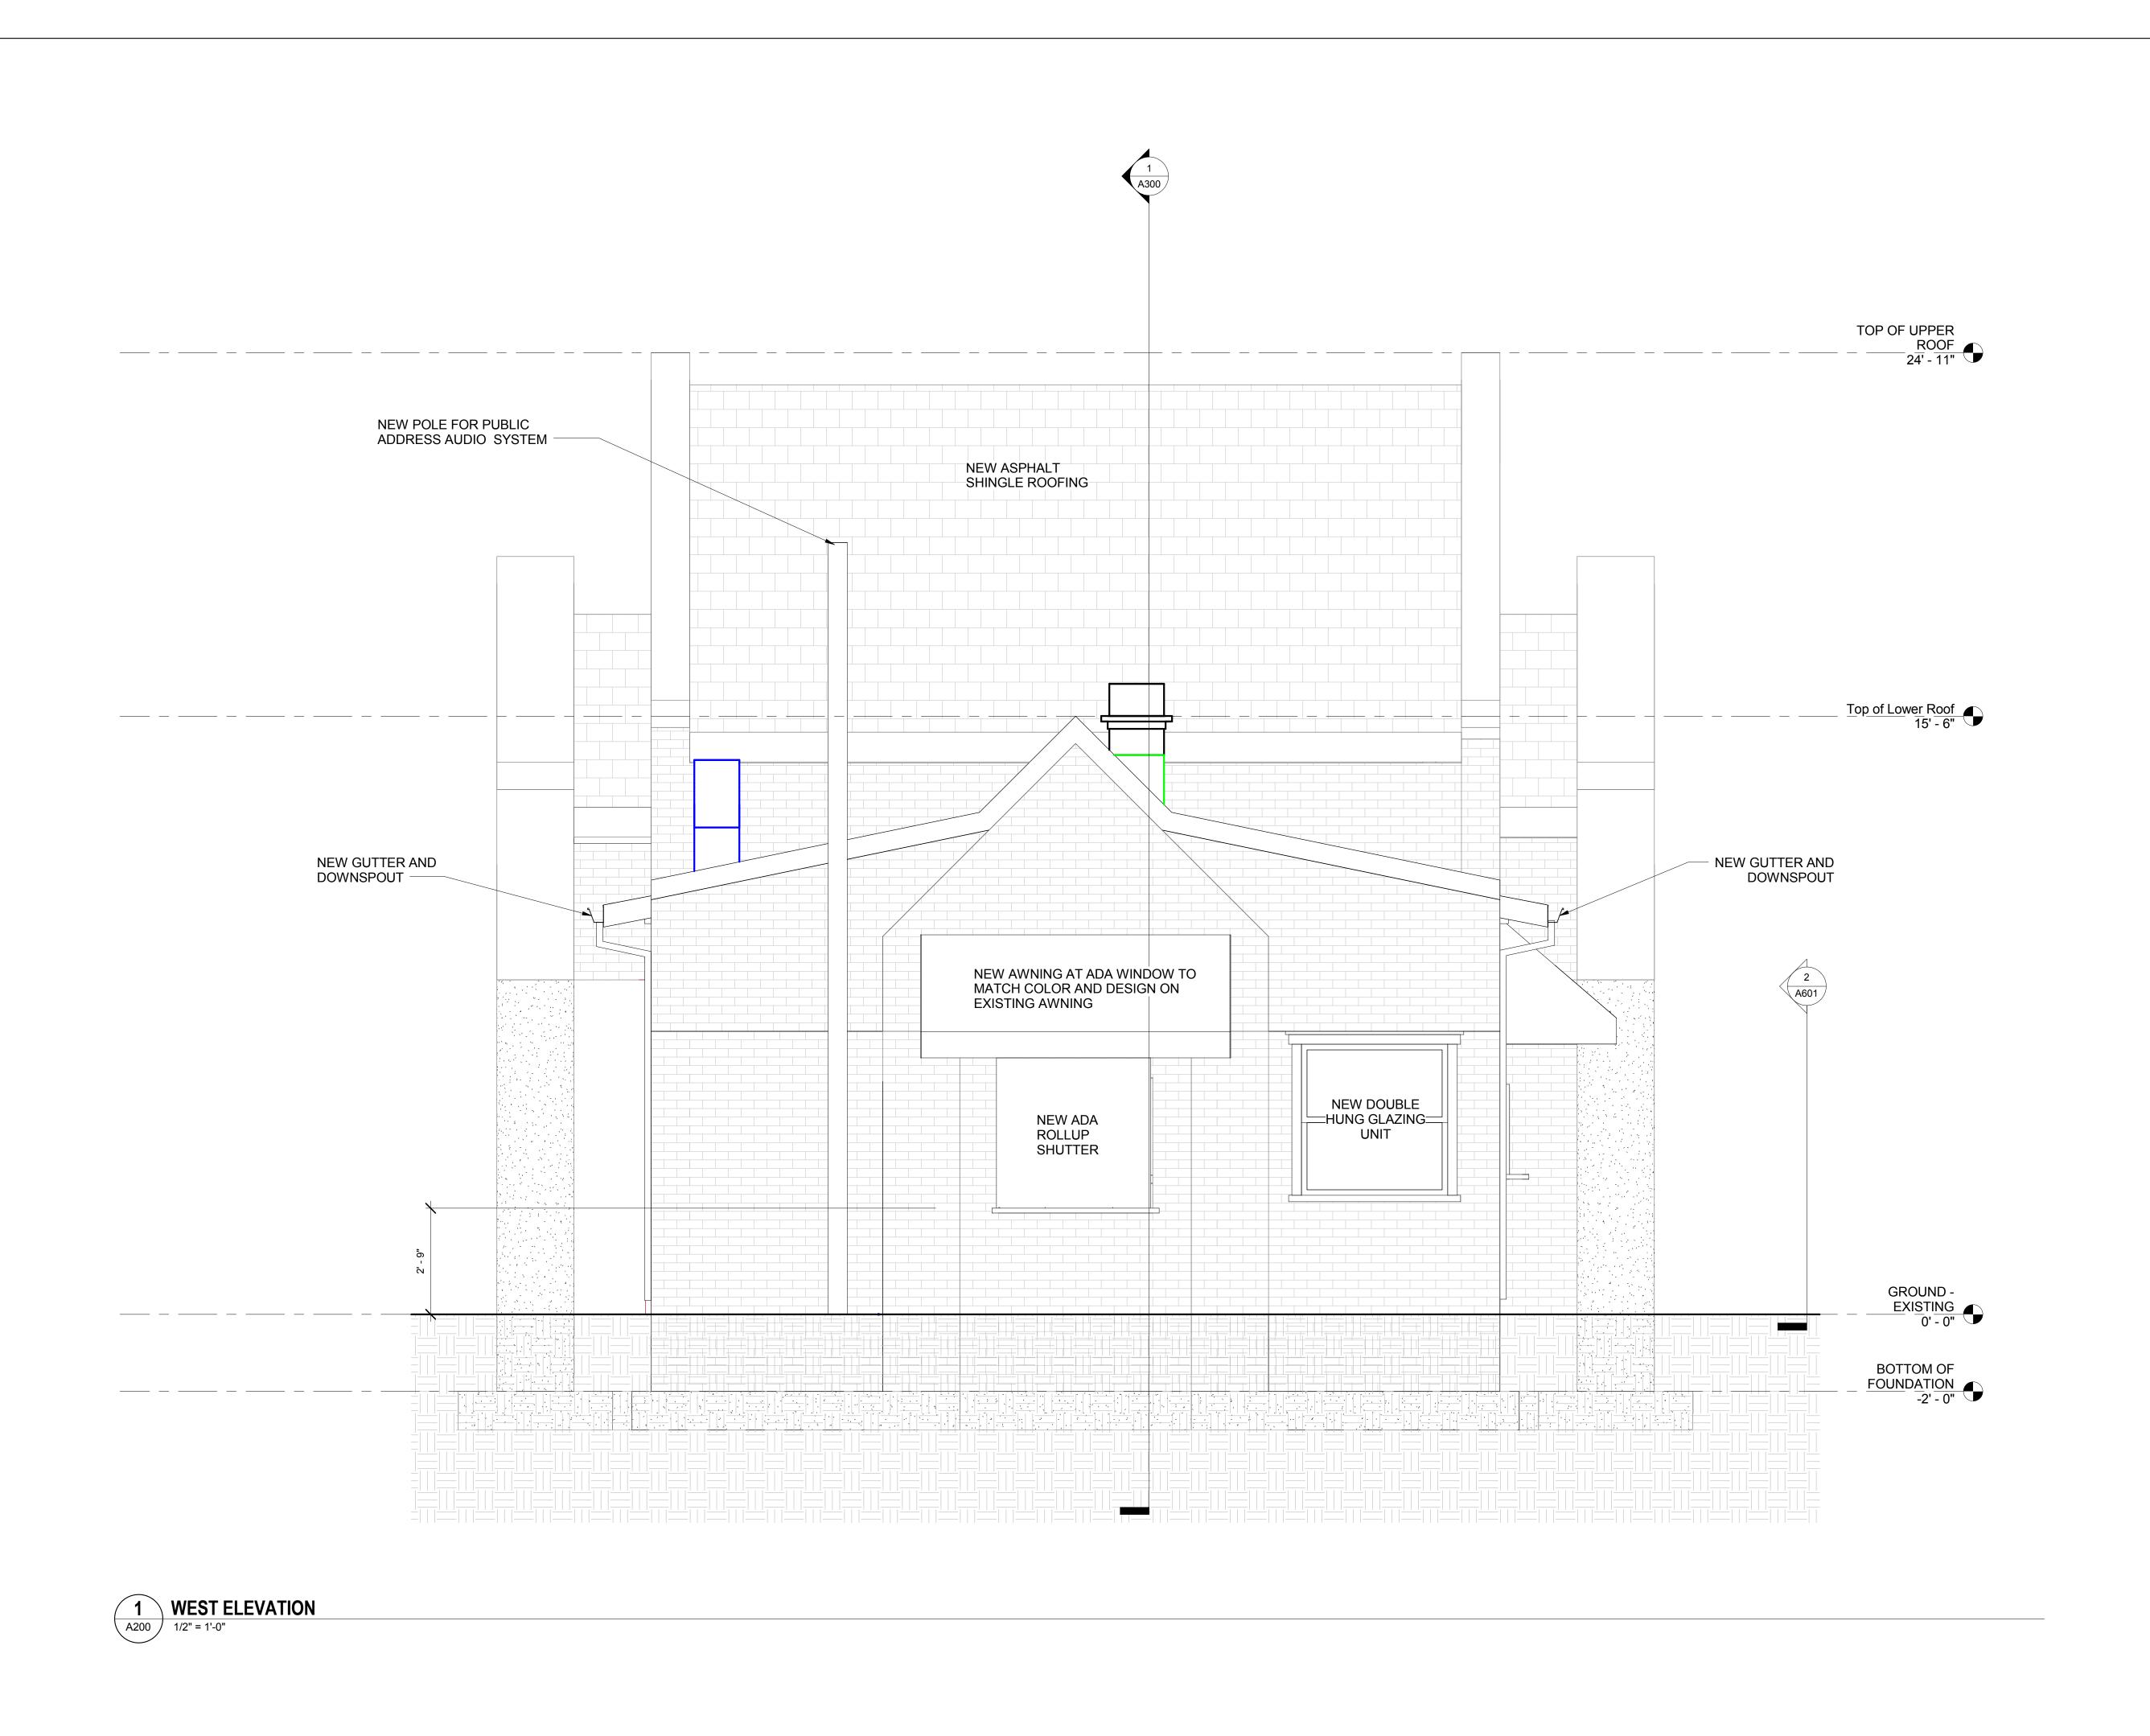



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No.	Description	Date
1	REVISION # 1	06/30/2016
2	REVISION # 2	07/12/2016

Re

Drawir

WEST ELEVATION


Phase

☐ CONCEPT ☐ 35% ☐ 60% ☐ 80% **☐** 100%

A/E Project Number 12-0009.012	Drawing Scale: AS N		
Date 06.30.2016	CADD Filename Revit Model		
HITECT	Drawn By ACA		



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No.	Description	Date		
1	REVISION # 1	06/30/2016		
2	REVISION # 2	07/12/2016		

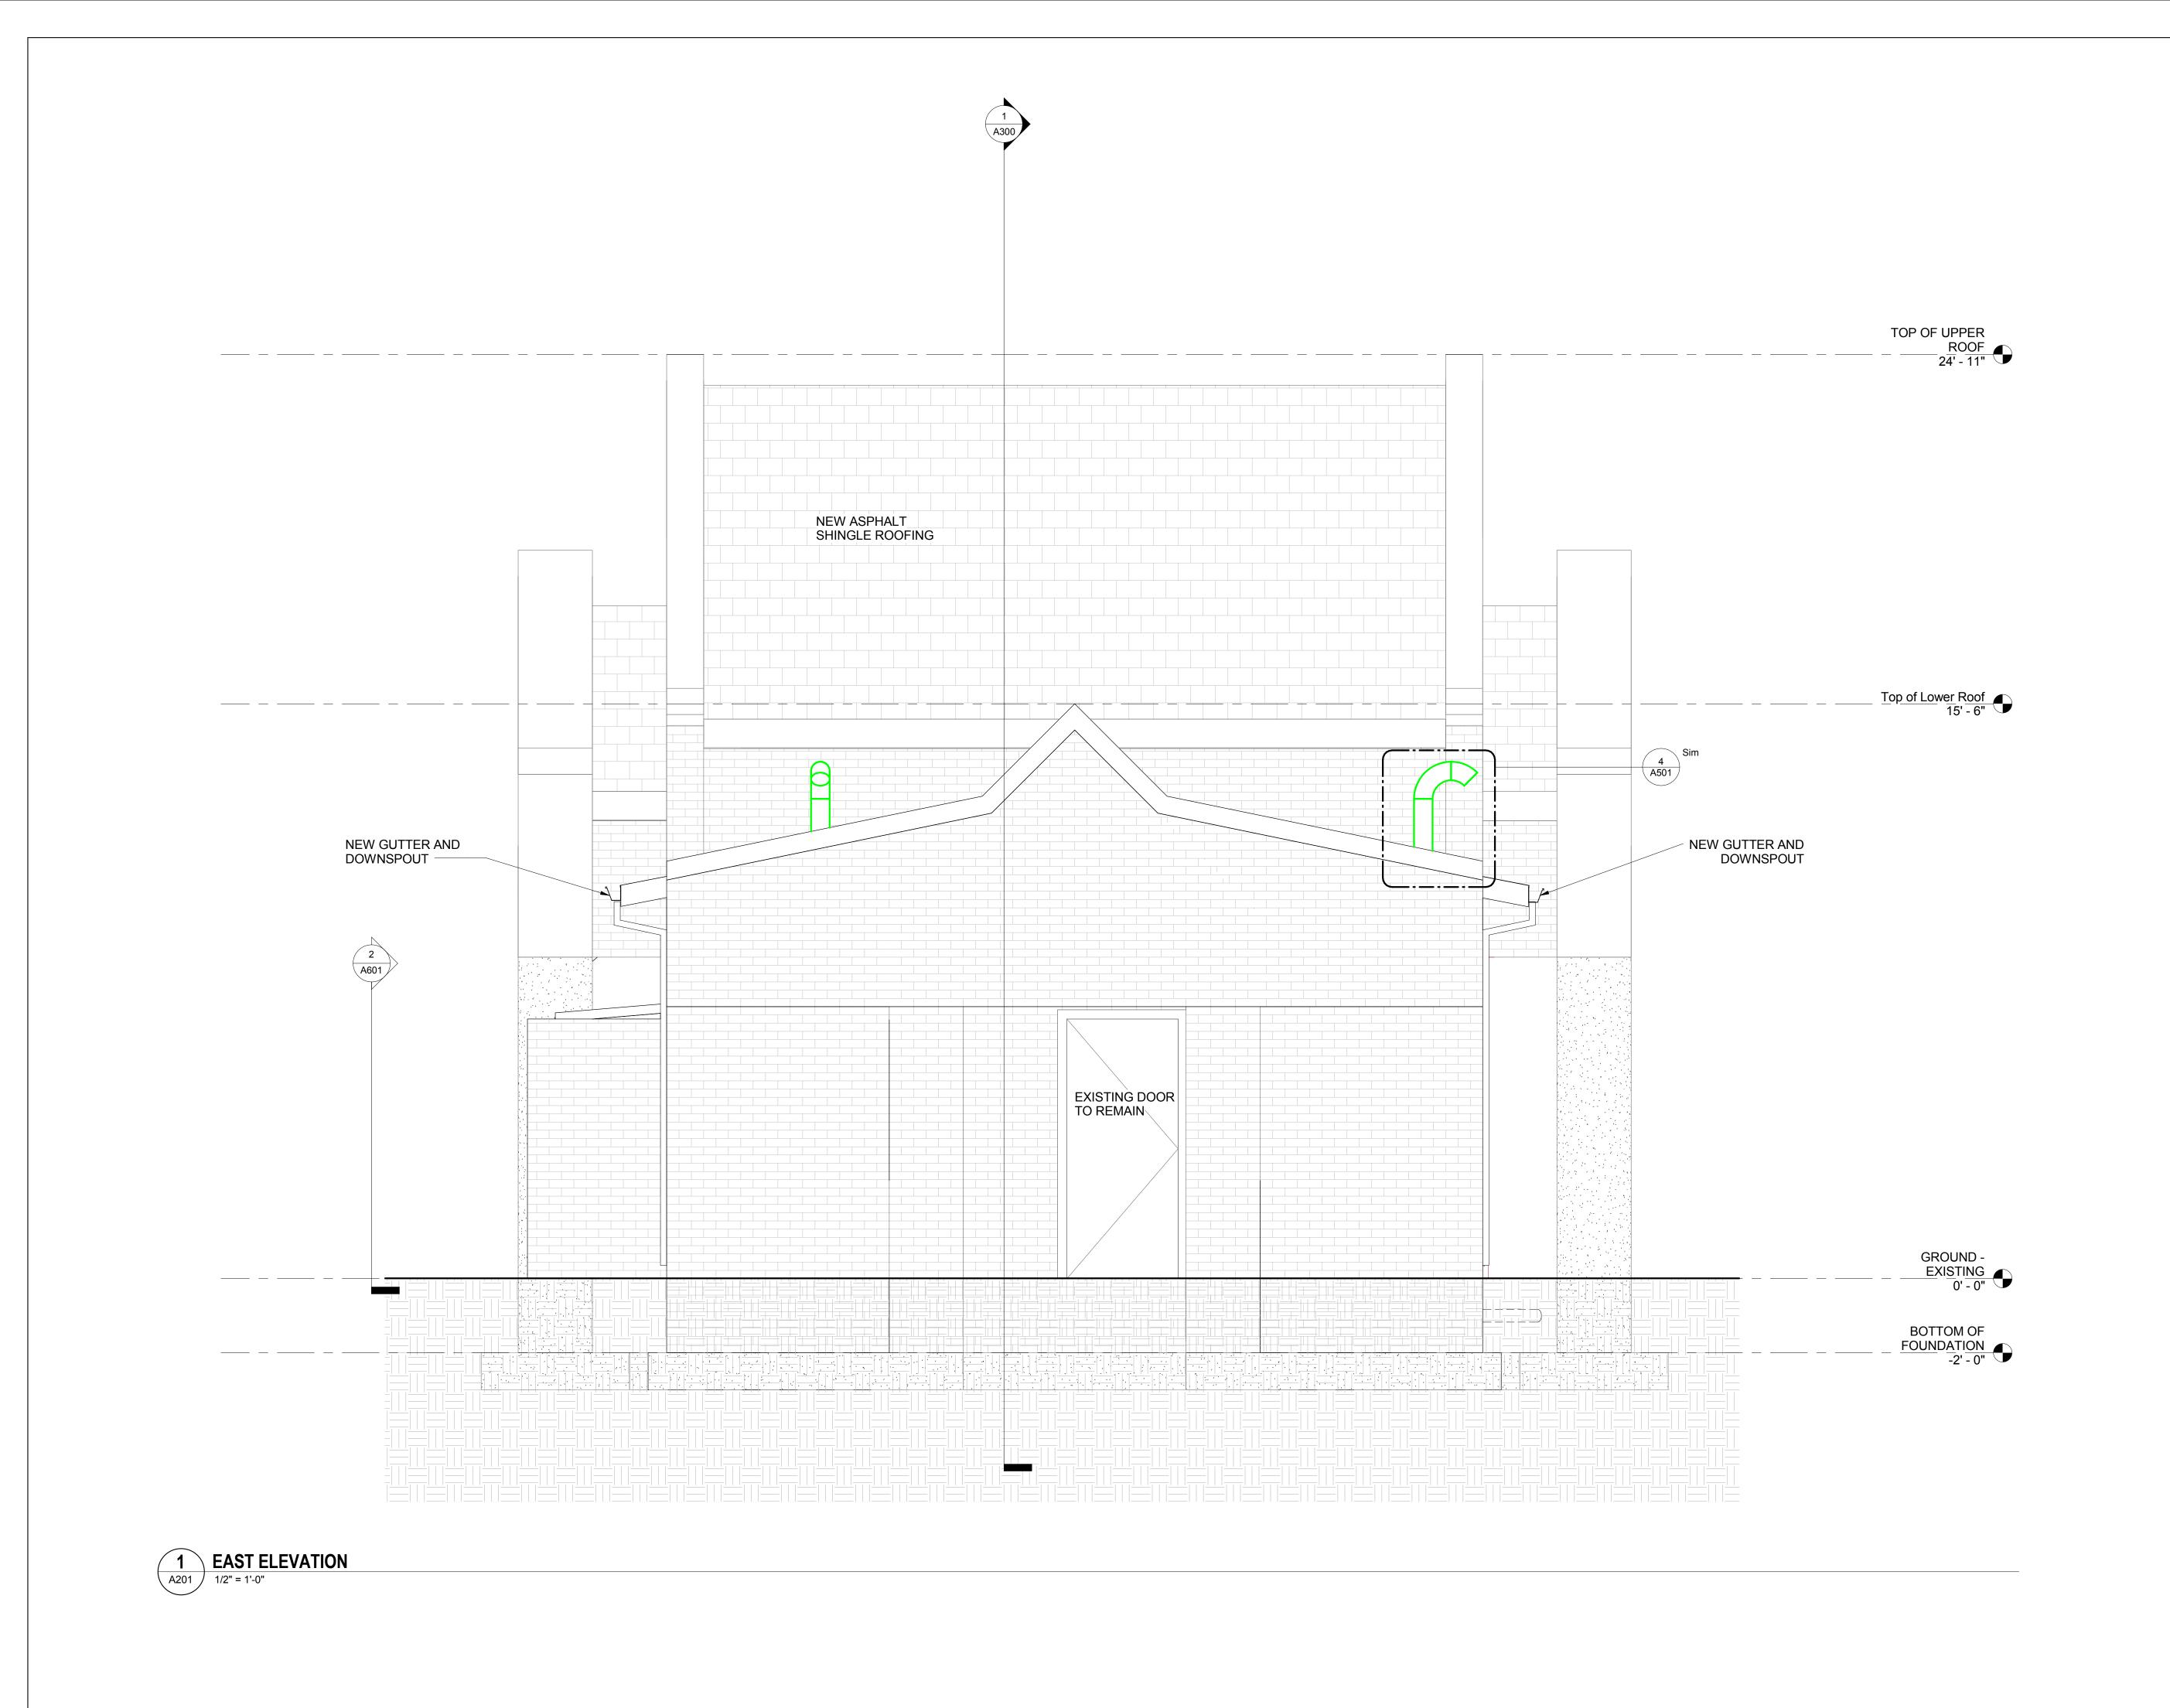Re

Drawing T

EAST ELEVATION

Phase


☐ CONCEPT ☐ 35% ☐ 60% ☐ 80% **☐** 100%

A/E Project Number
12-0009.012

Date
06.30.2016


Drawing Scale: AS NOTED

CADD Filename CADD Plot Scale
Revit Model 1:1

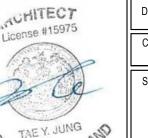

Drawn By ASM

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2	REVISION # 2	07/12/2016		

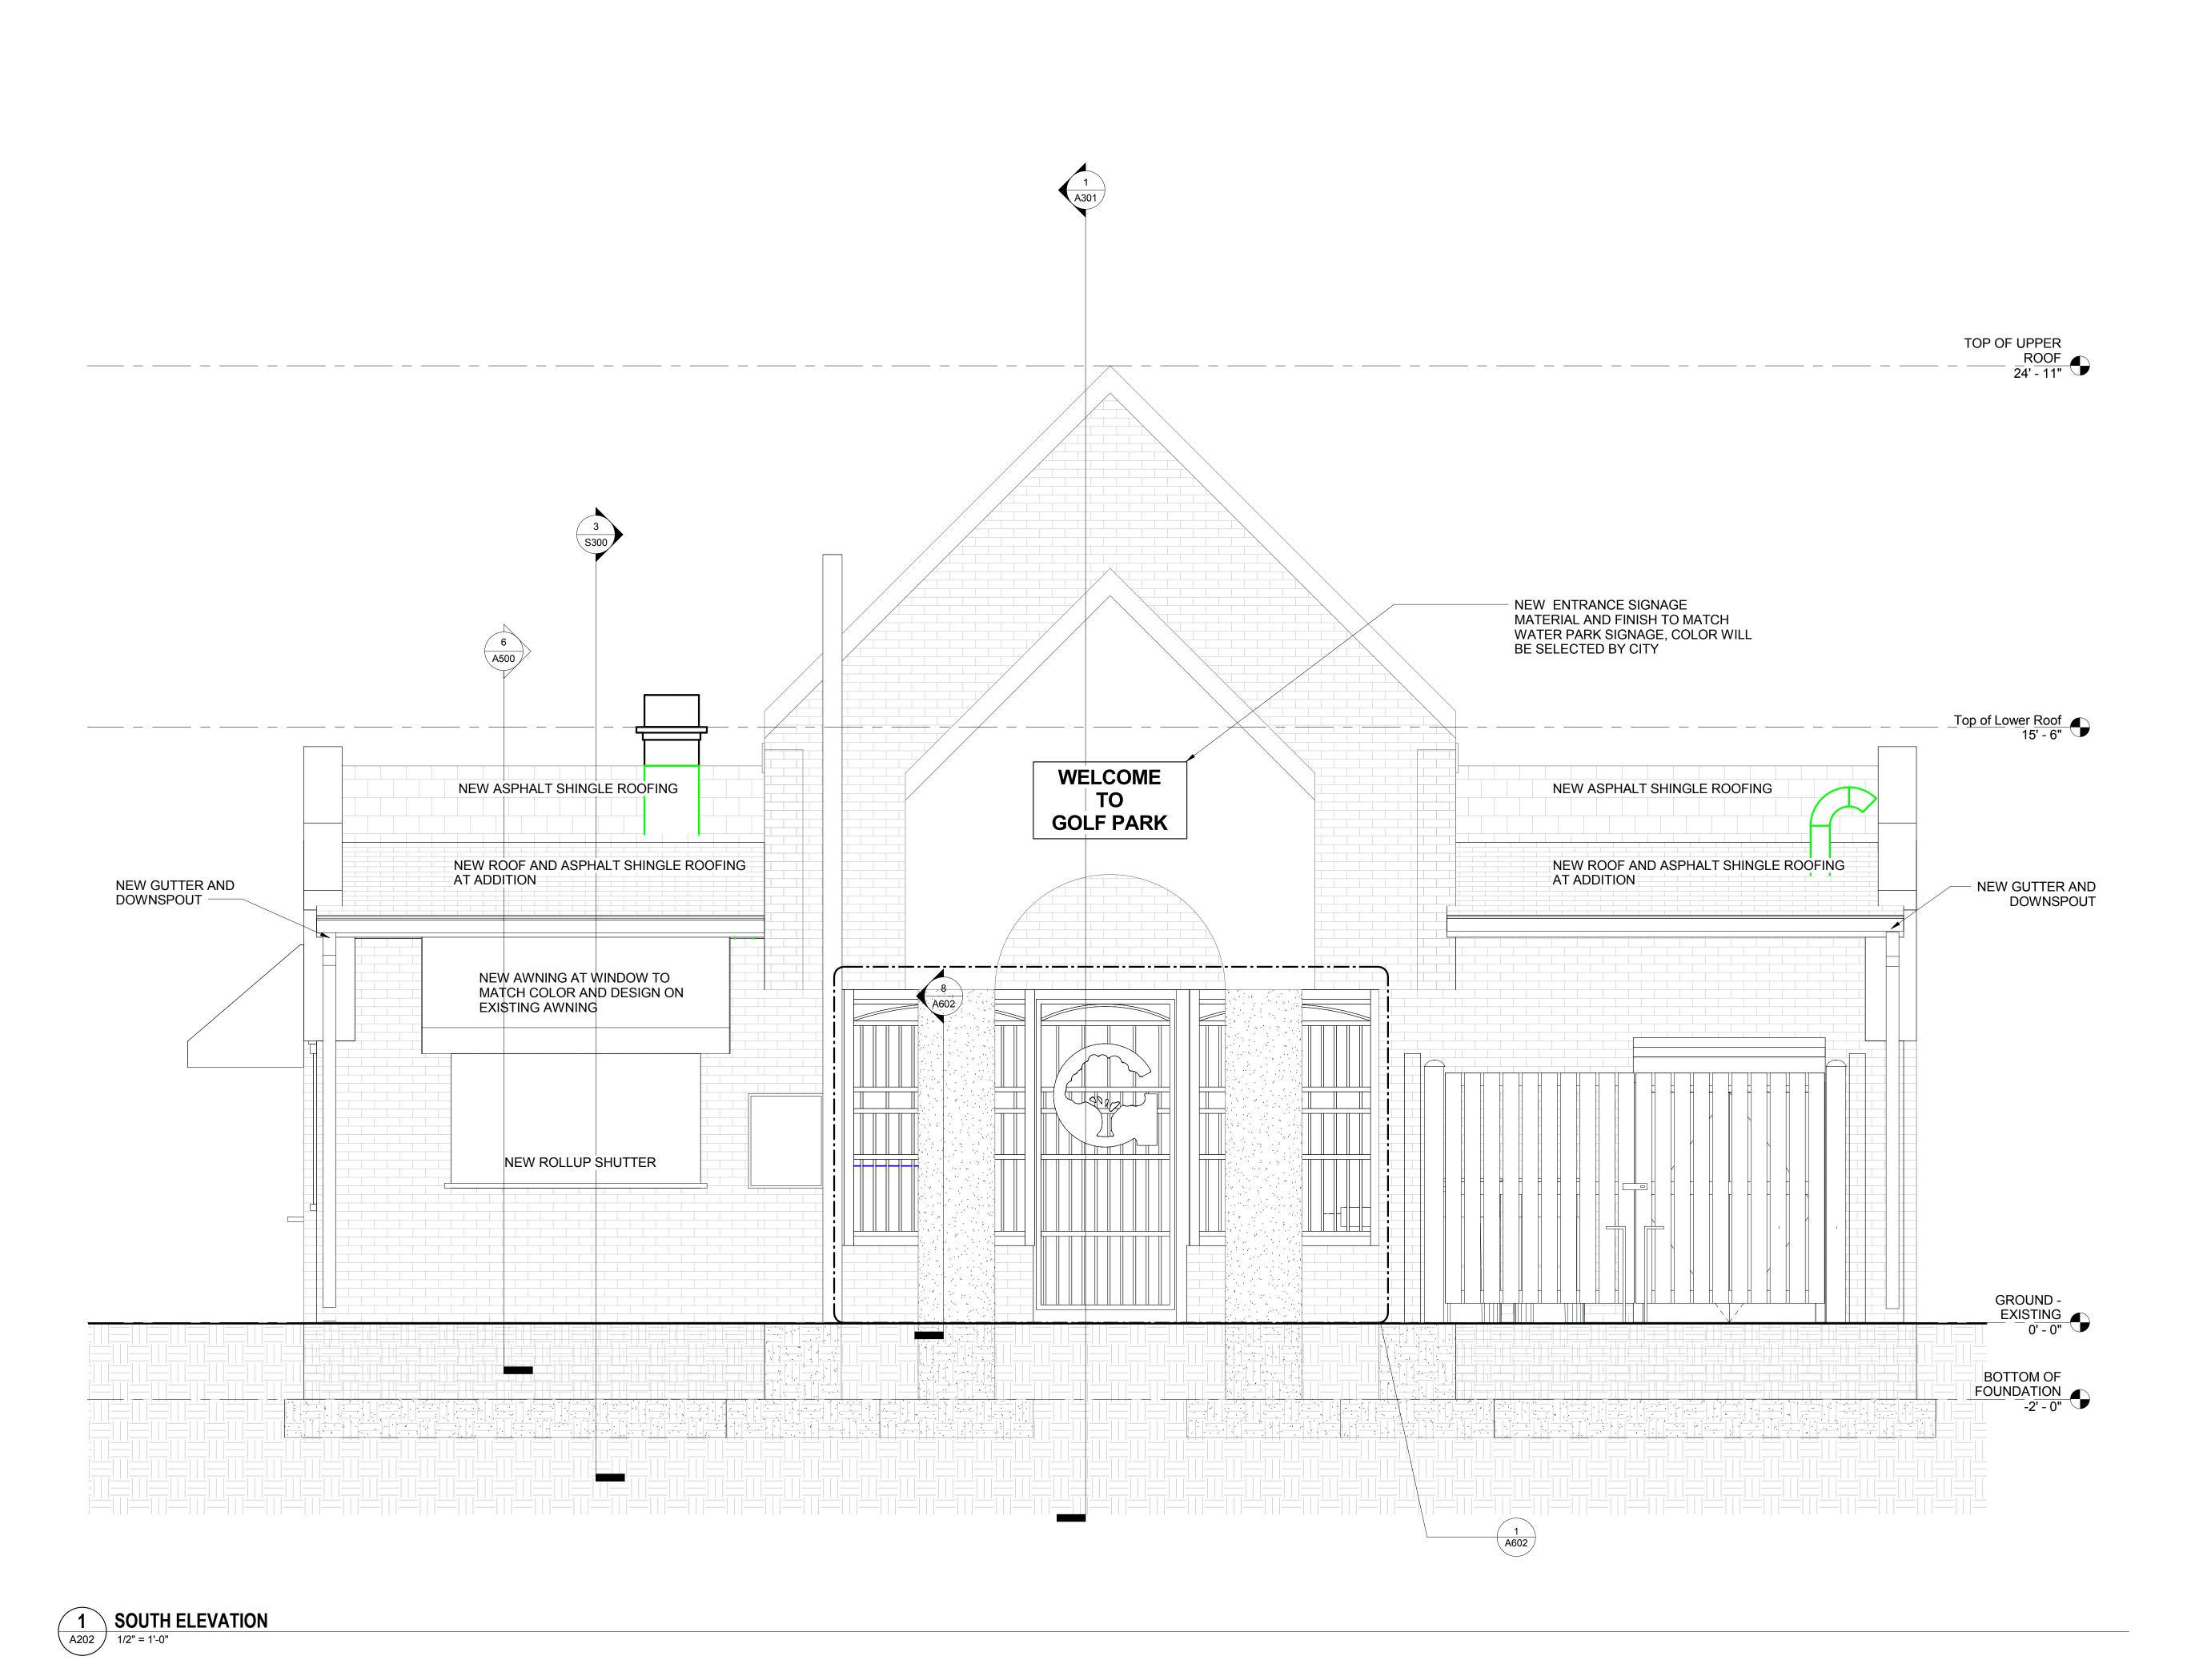Drawing Title


SOUTH ELEVATION

386



Drawn By ASM

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No.	Description	Date		
1	REVISION # 1	06/30/2016		
2	REVISION # 2	07/12/2016		

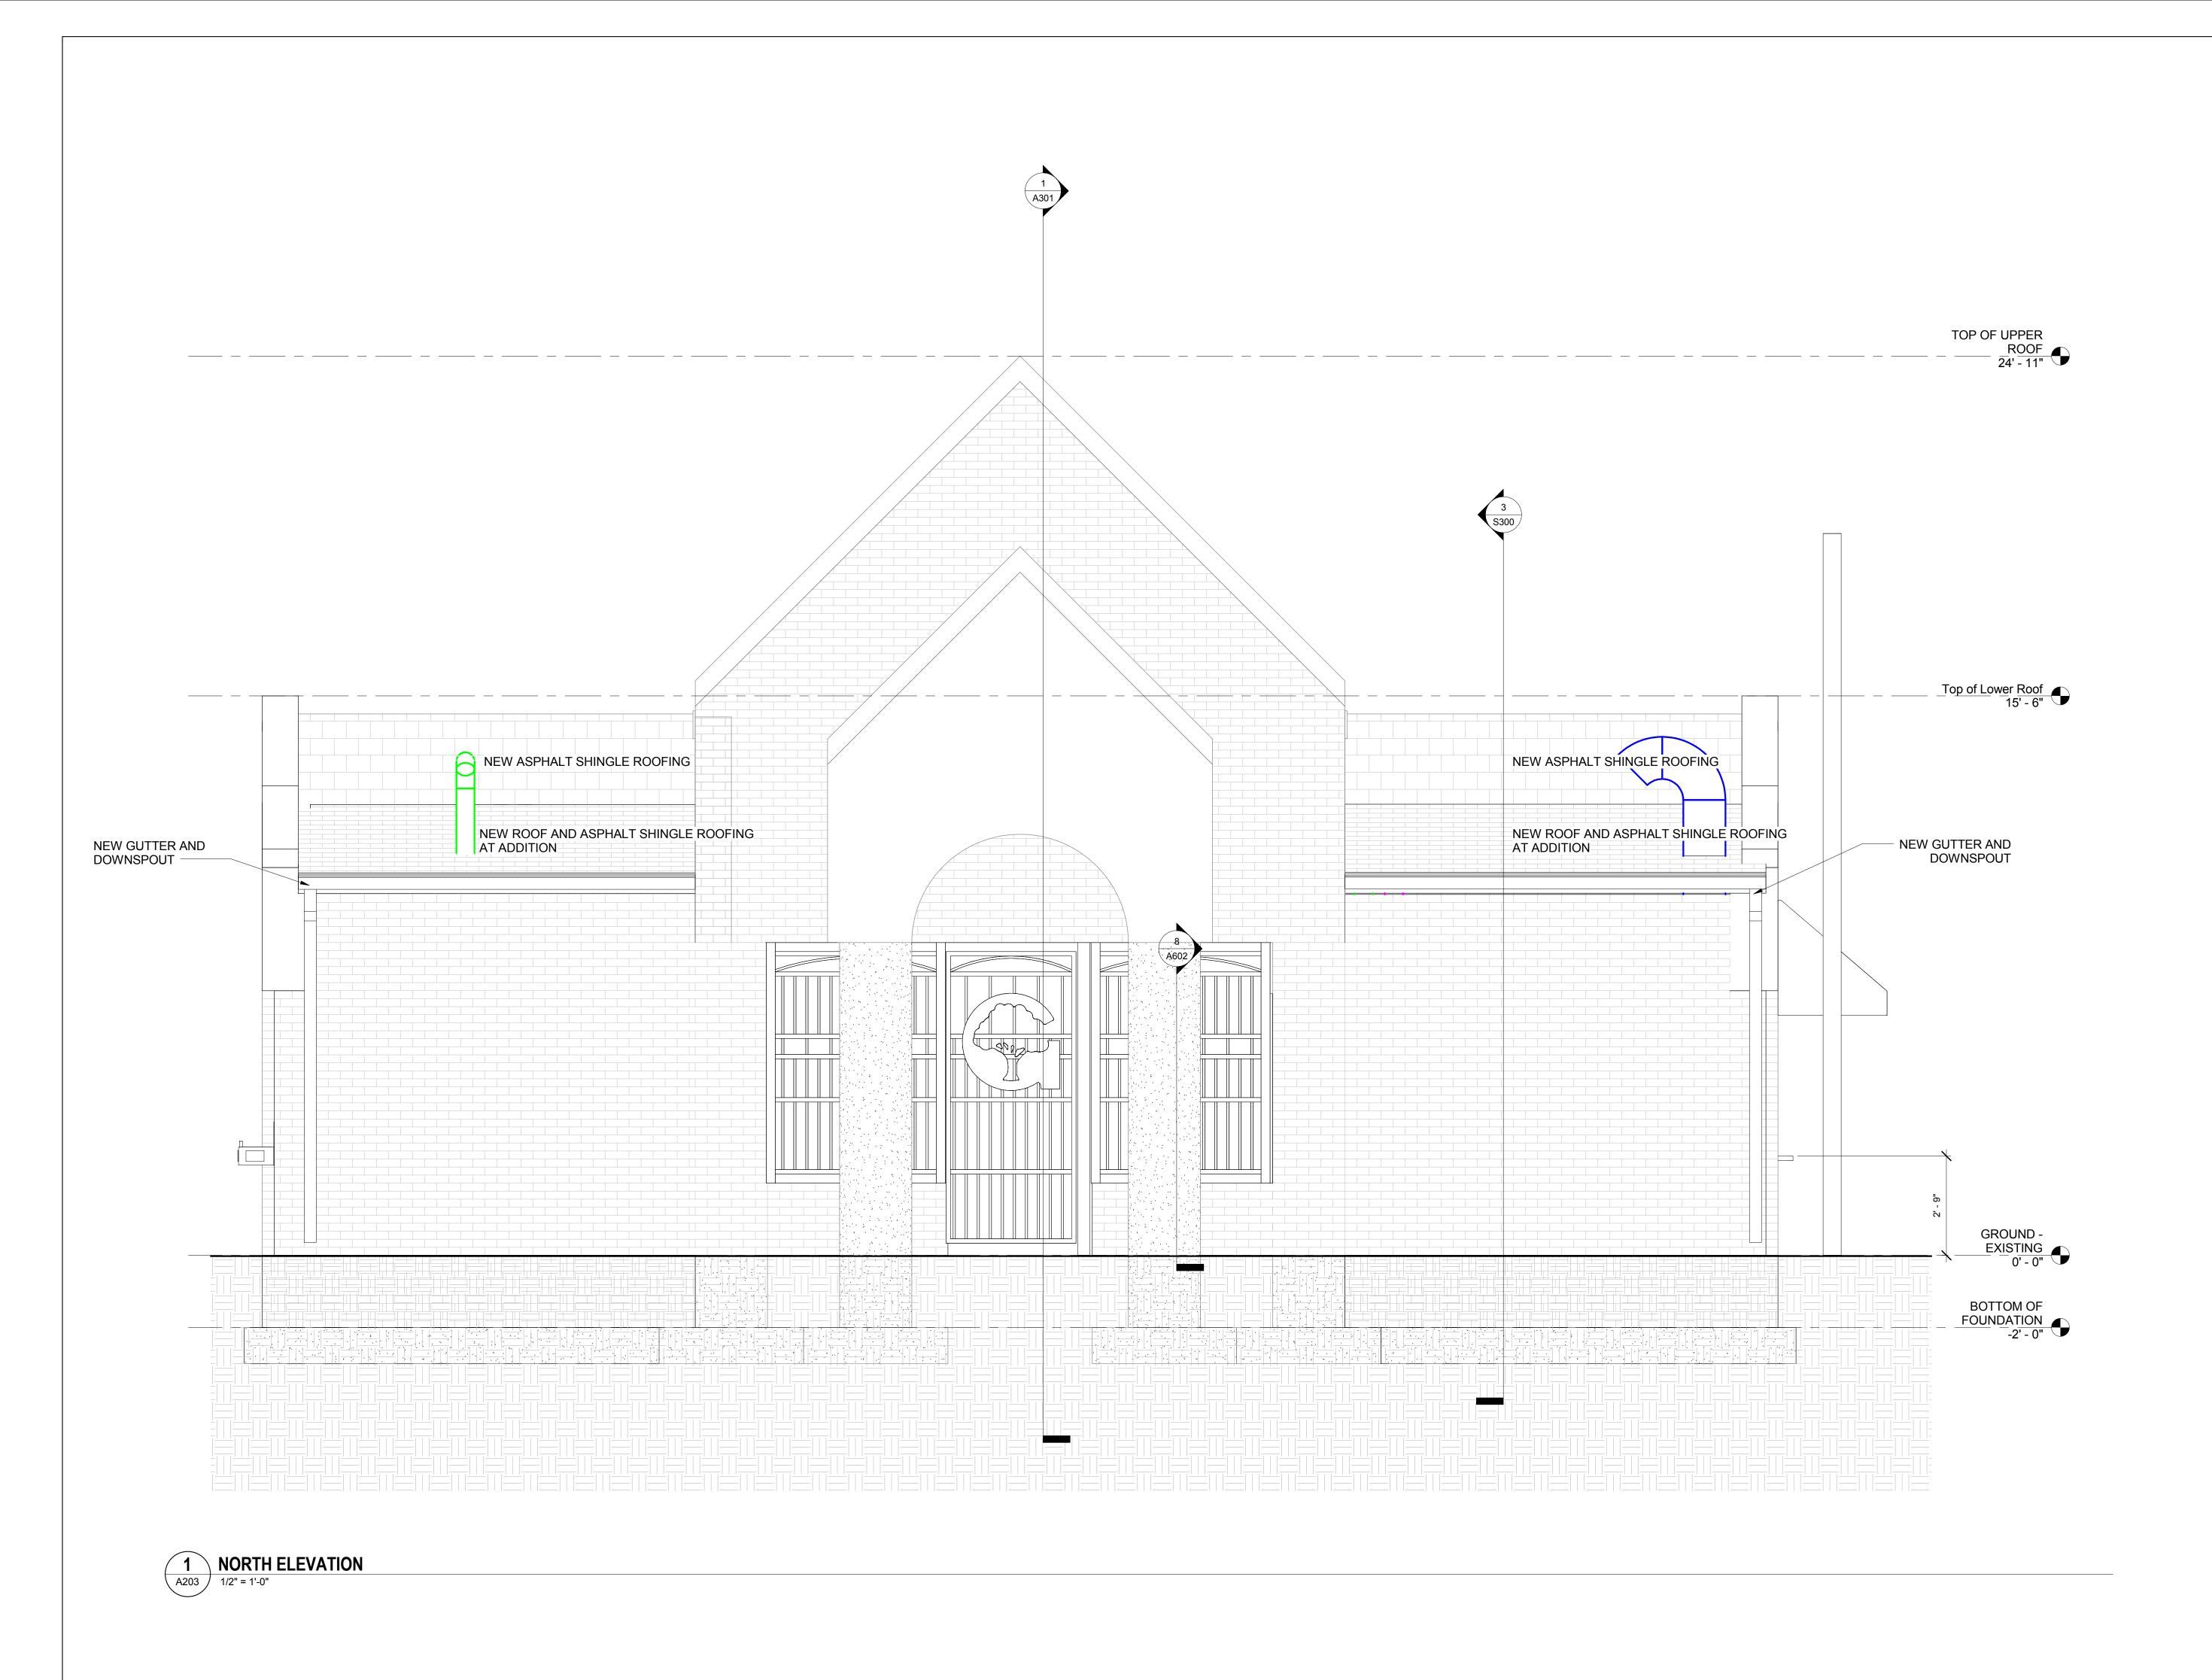Drawin

NORTH ELEVATION

Phase

☐ CONCEPT ☐ 35% ☐ 60% ☐ 80% **■** 100%


A/E Project Number 12-0009.012	Drawing Scale: AS NOTED
Date 06.30.2016	CADD Filename CADD P Revit Model 1:1
License #15975	Drawn By ASM
License #155.5	



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Sheet Number

A203



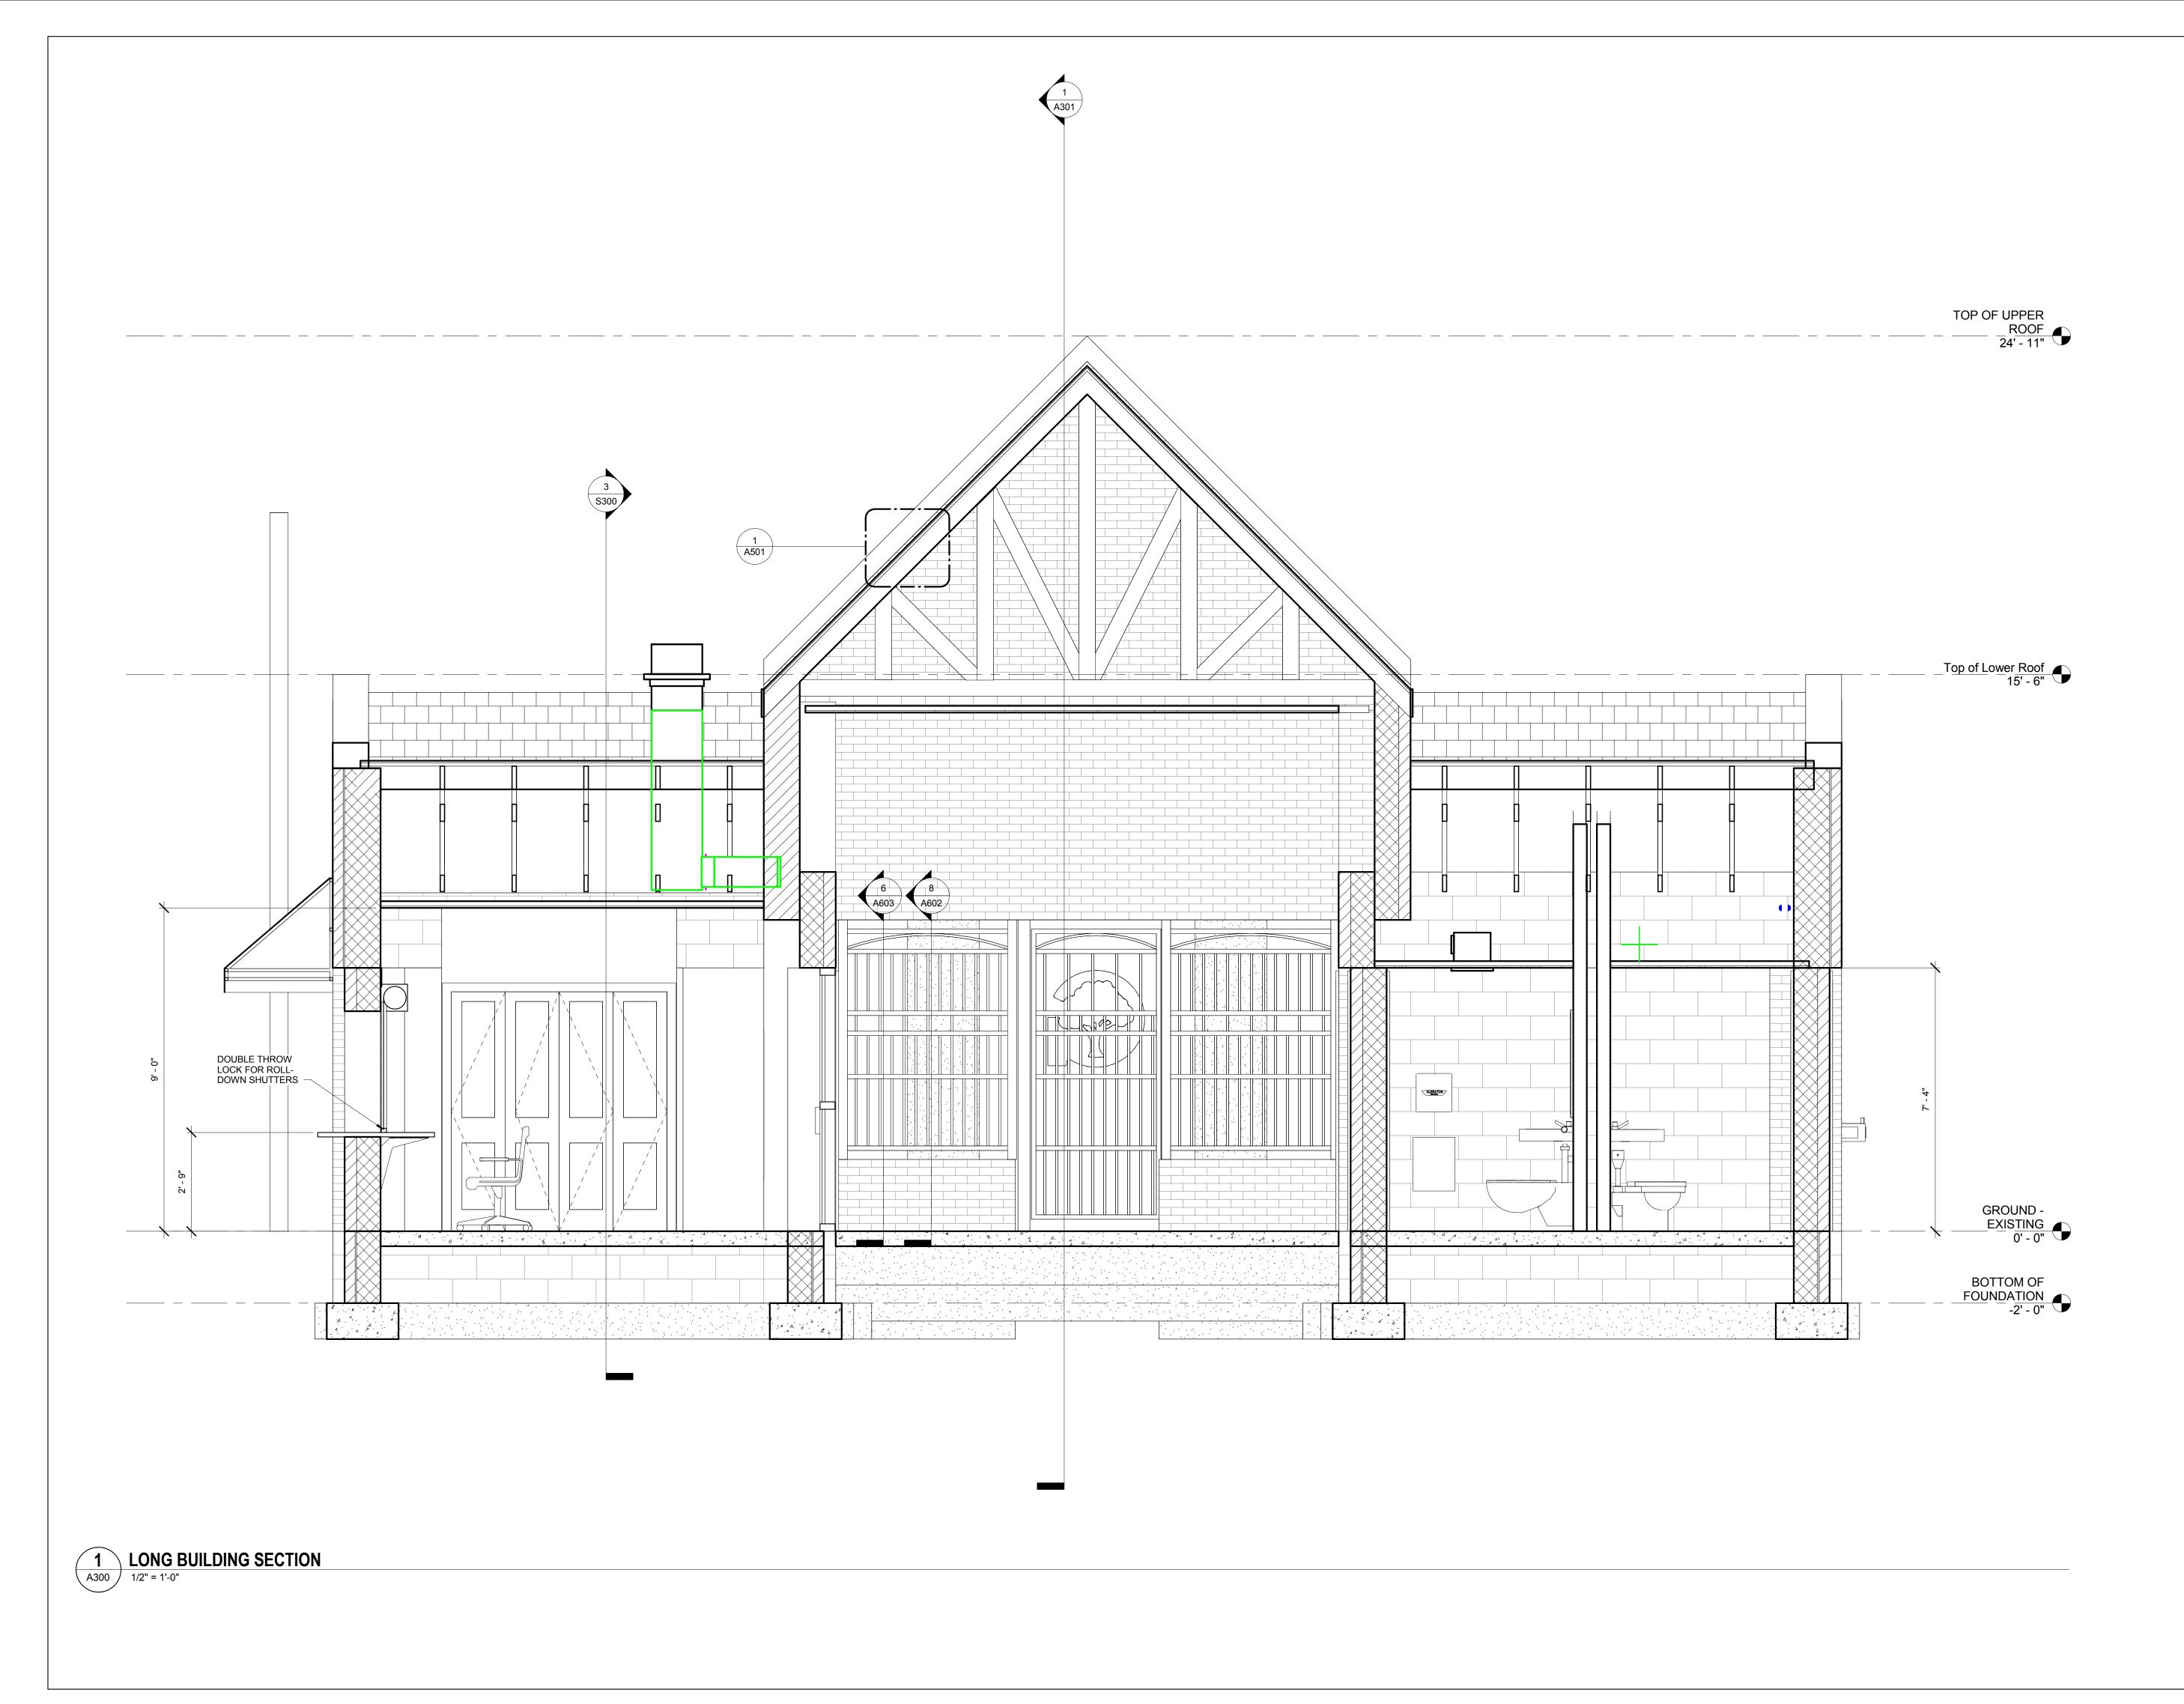

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No.	Description	Date
1	REVISION # 1	06/30/2016
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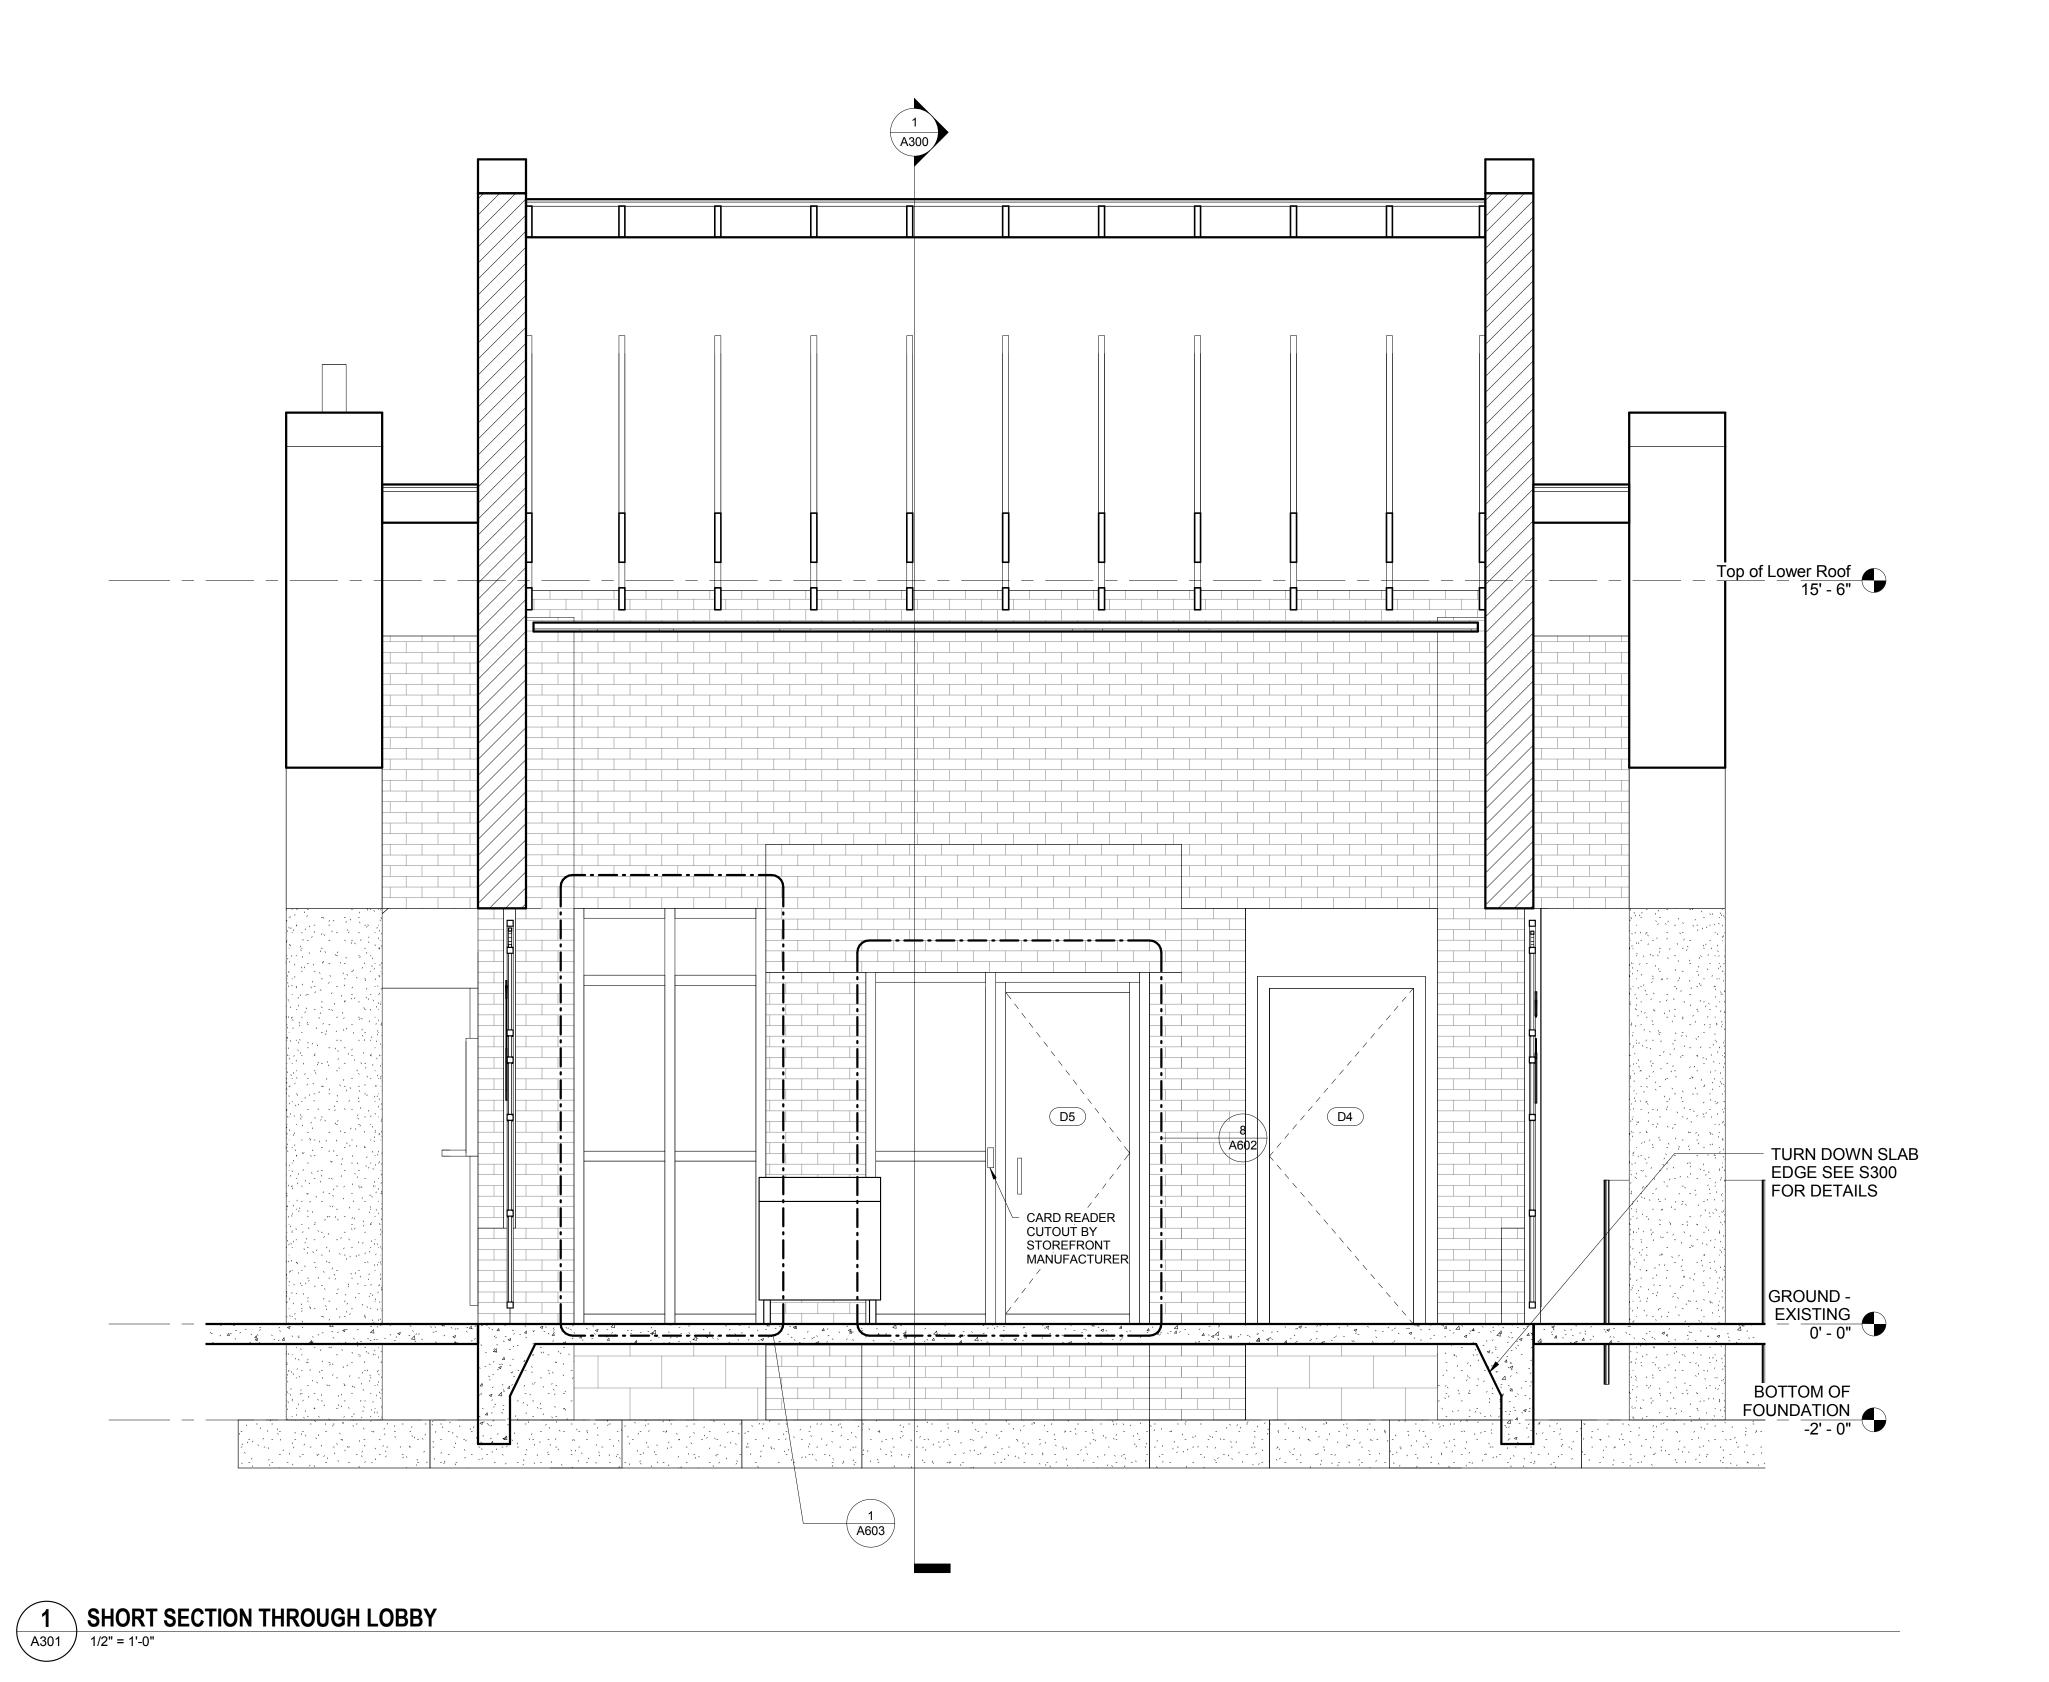
LONG BUILDING SECTION

☐ CONCEPT ☐ 35% ☐ 60% ☐ 80% **☐** 100%

A/E Project Number 12-0009.012	Drawing Scale: AS NOTED
Date 06.30.2016	CADD Filename CADD P Revit Model 1:1
CHITECT	Drawn By ASM



Filename CADD Plot Scale
Revit Model 1:1 ASM Checked By AV





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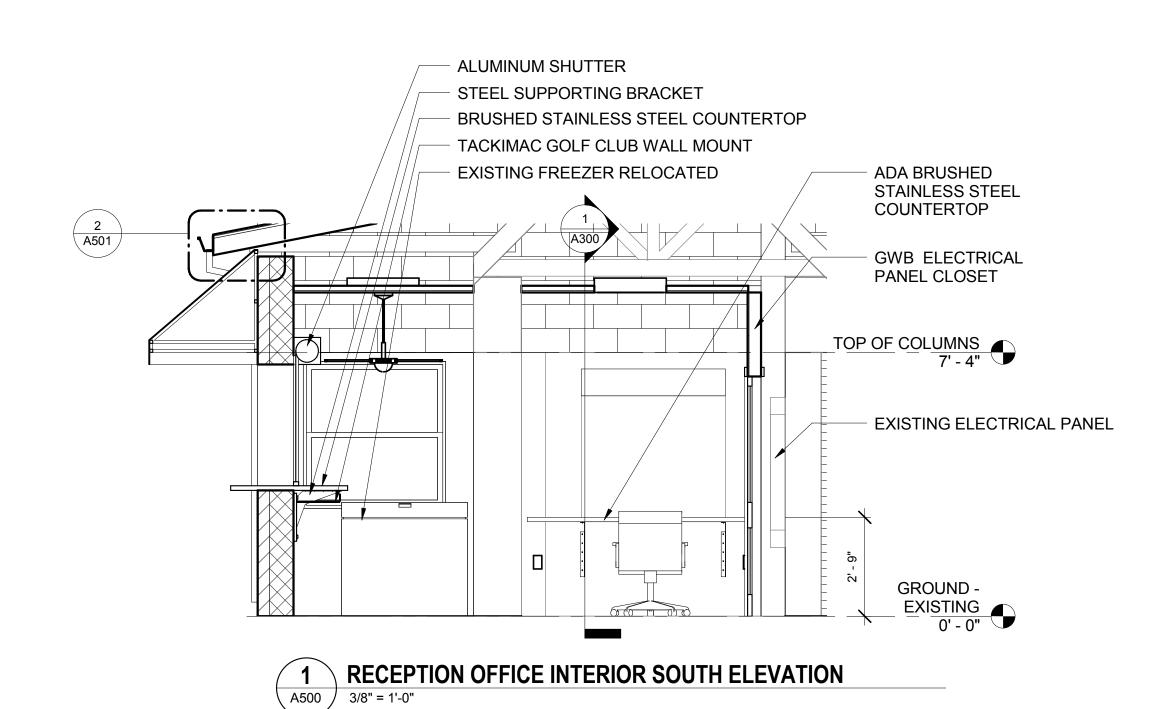
No.	Description	Date
1	REVISION # 1	06/30/2016
2	REVISION # 2	07/12/2016


SHORT SECTION THROUGH LOBBY


CONCEPT 35% 60% 80% 100%


A/E Project Number Drawing Scale: AS NOTED CADD Filename CADD Plot Scale Revit Model 1:1





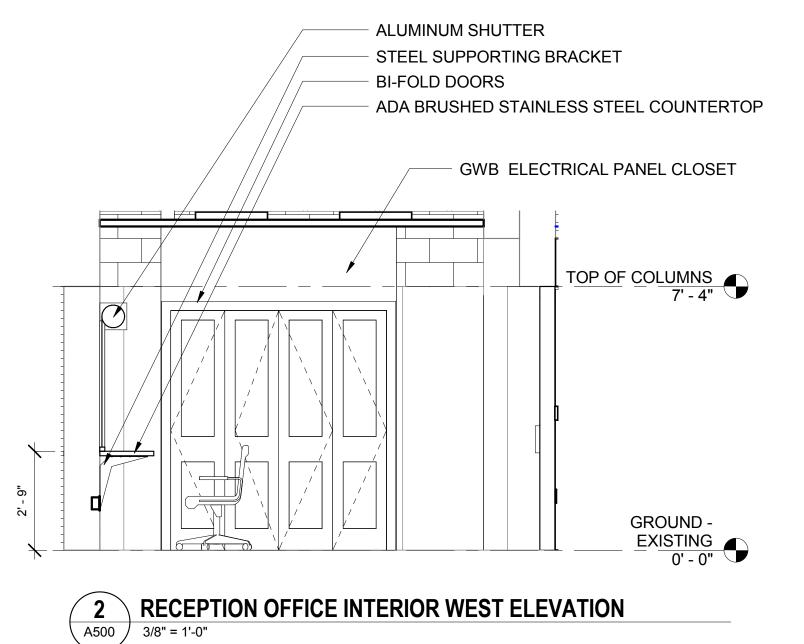

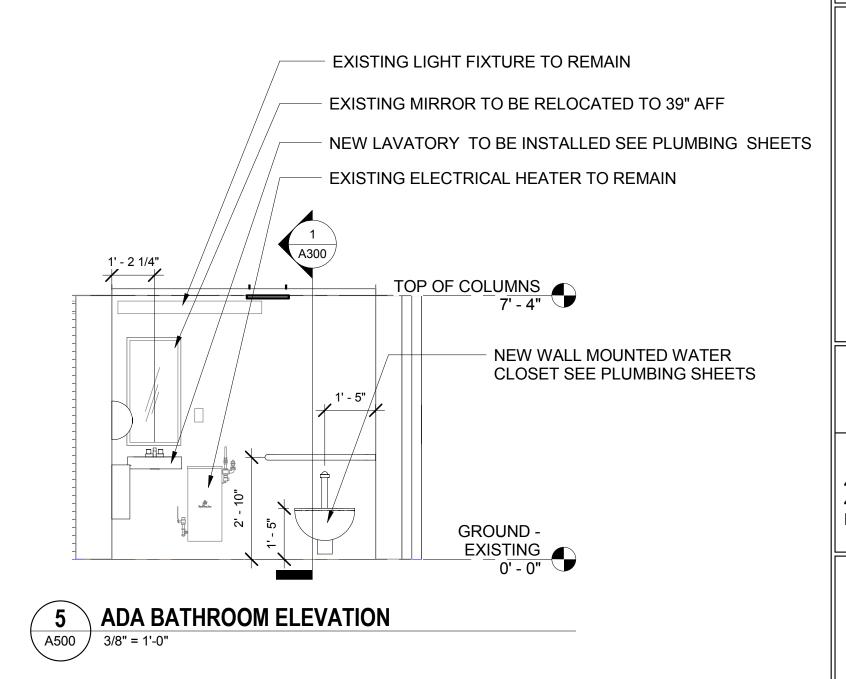

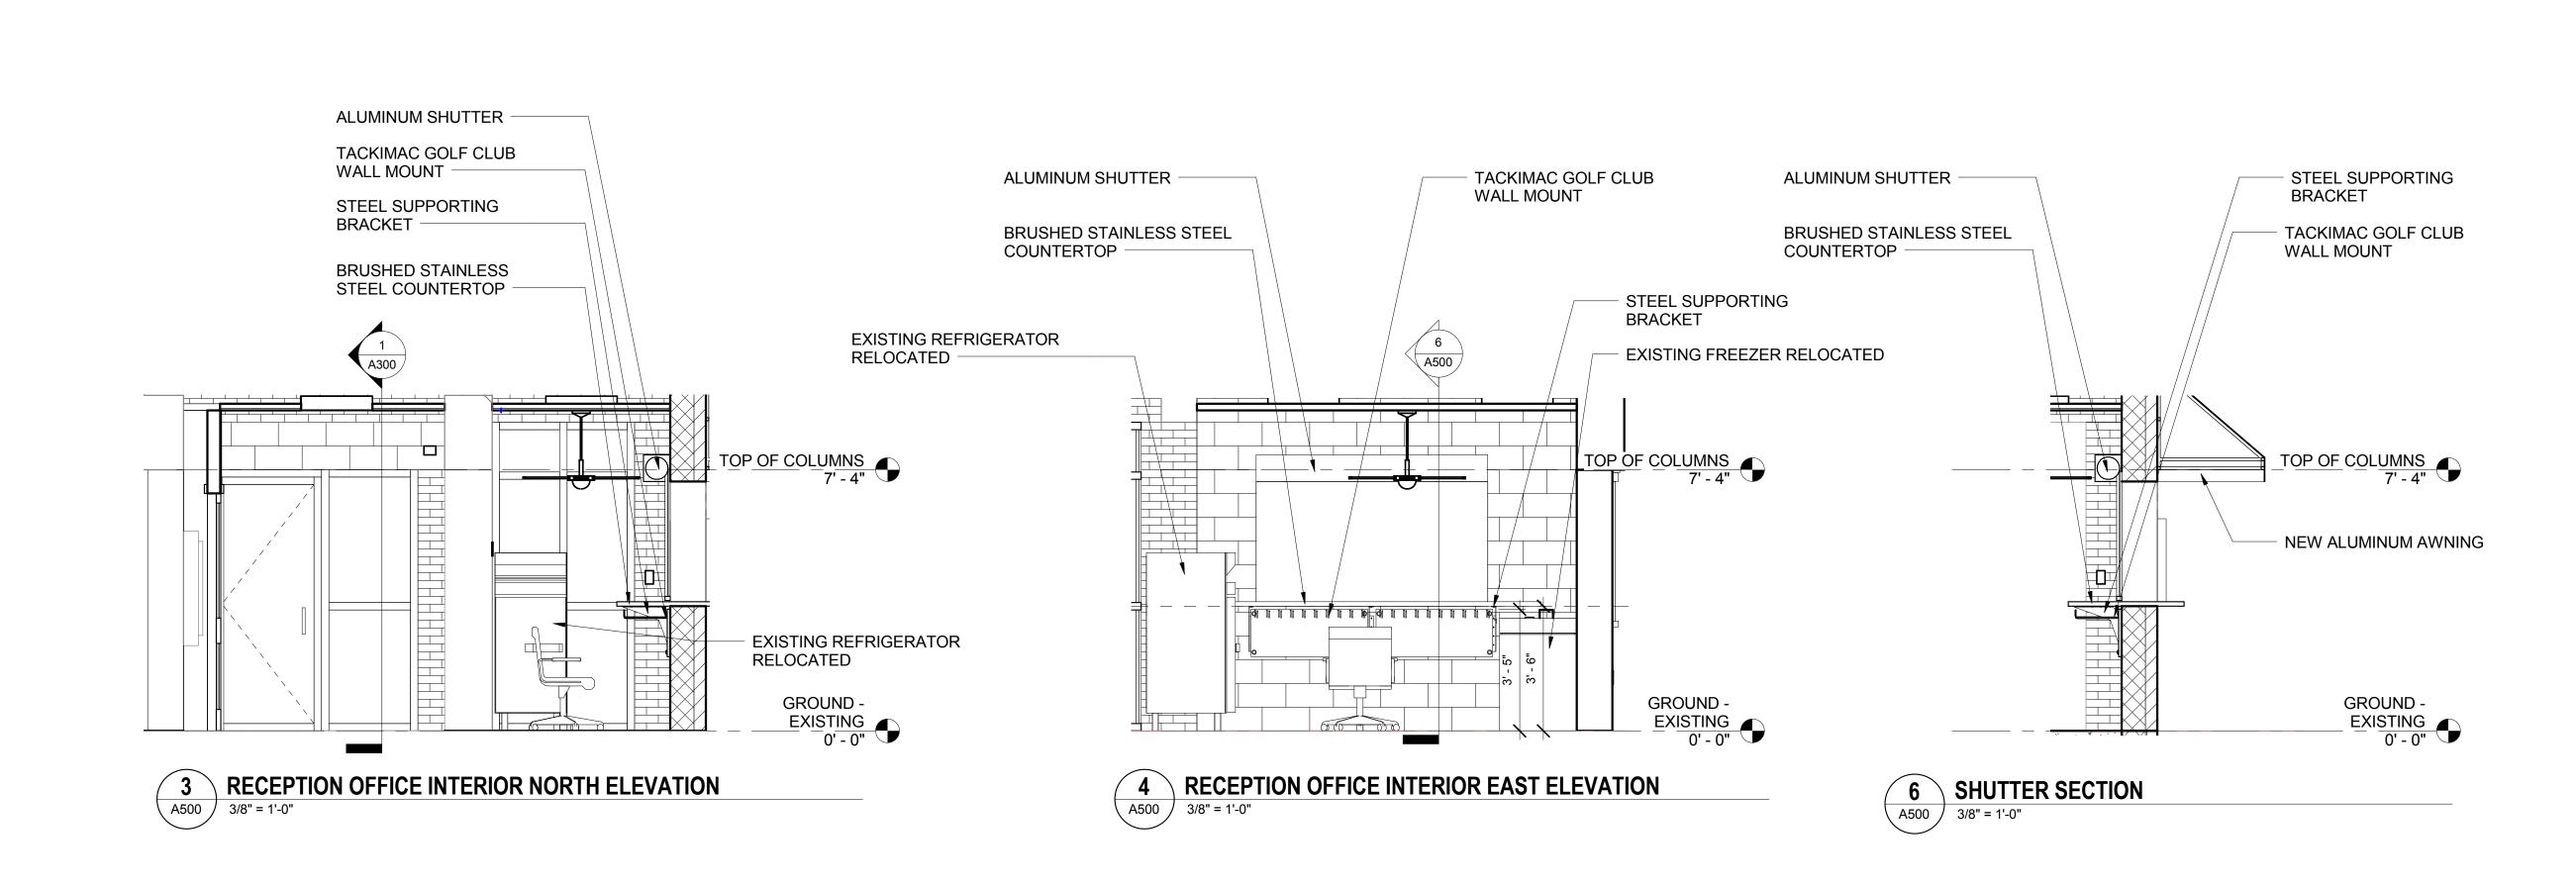

3/8" = 1'-0"



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1	REVISION # 1	06/30/2016		
2	REVISION # 2	07/12/2016		

INTERIOR ELEVATIONS

12-0009.012

Drawing Title


CONCEPT 35% 60% 80% 100% A/E Project Number


06.30.2016 License #15975 TAE Y. JUNG AND

CADD Filename CADD Plot Scale Revit Model 1:1 Drawn By ASM &PG Checked By AV

Drawing Scale: AS NOTED

Sheet Number **A500**

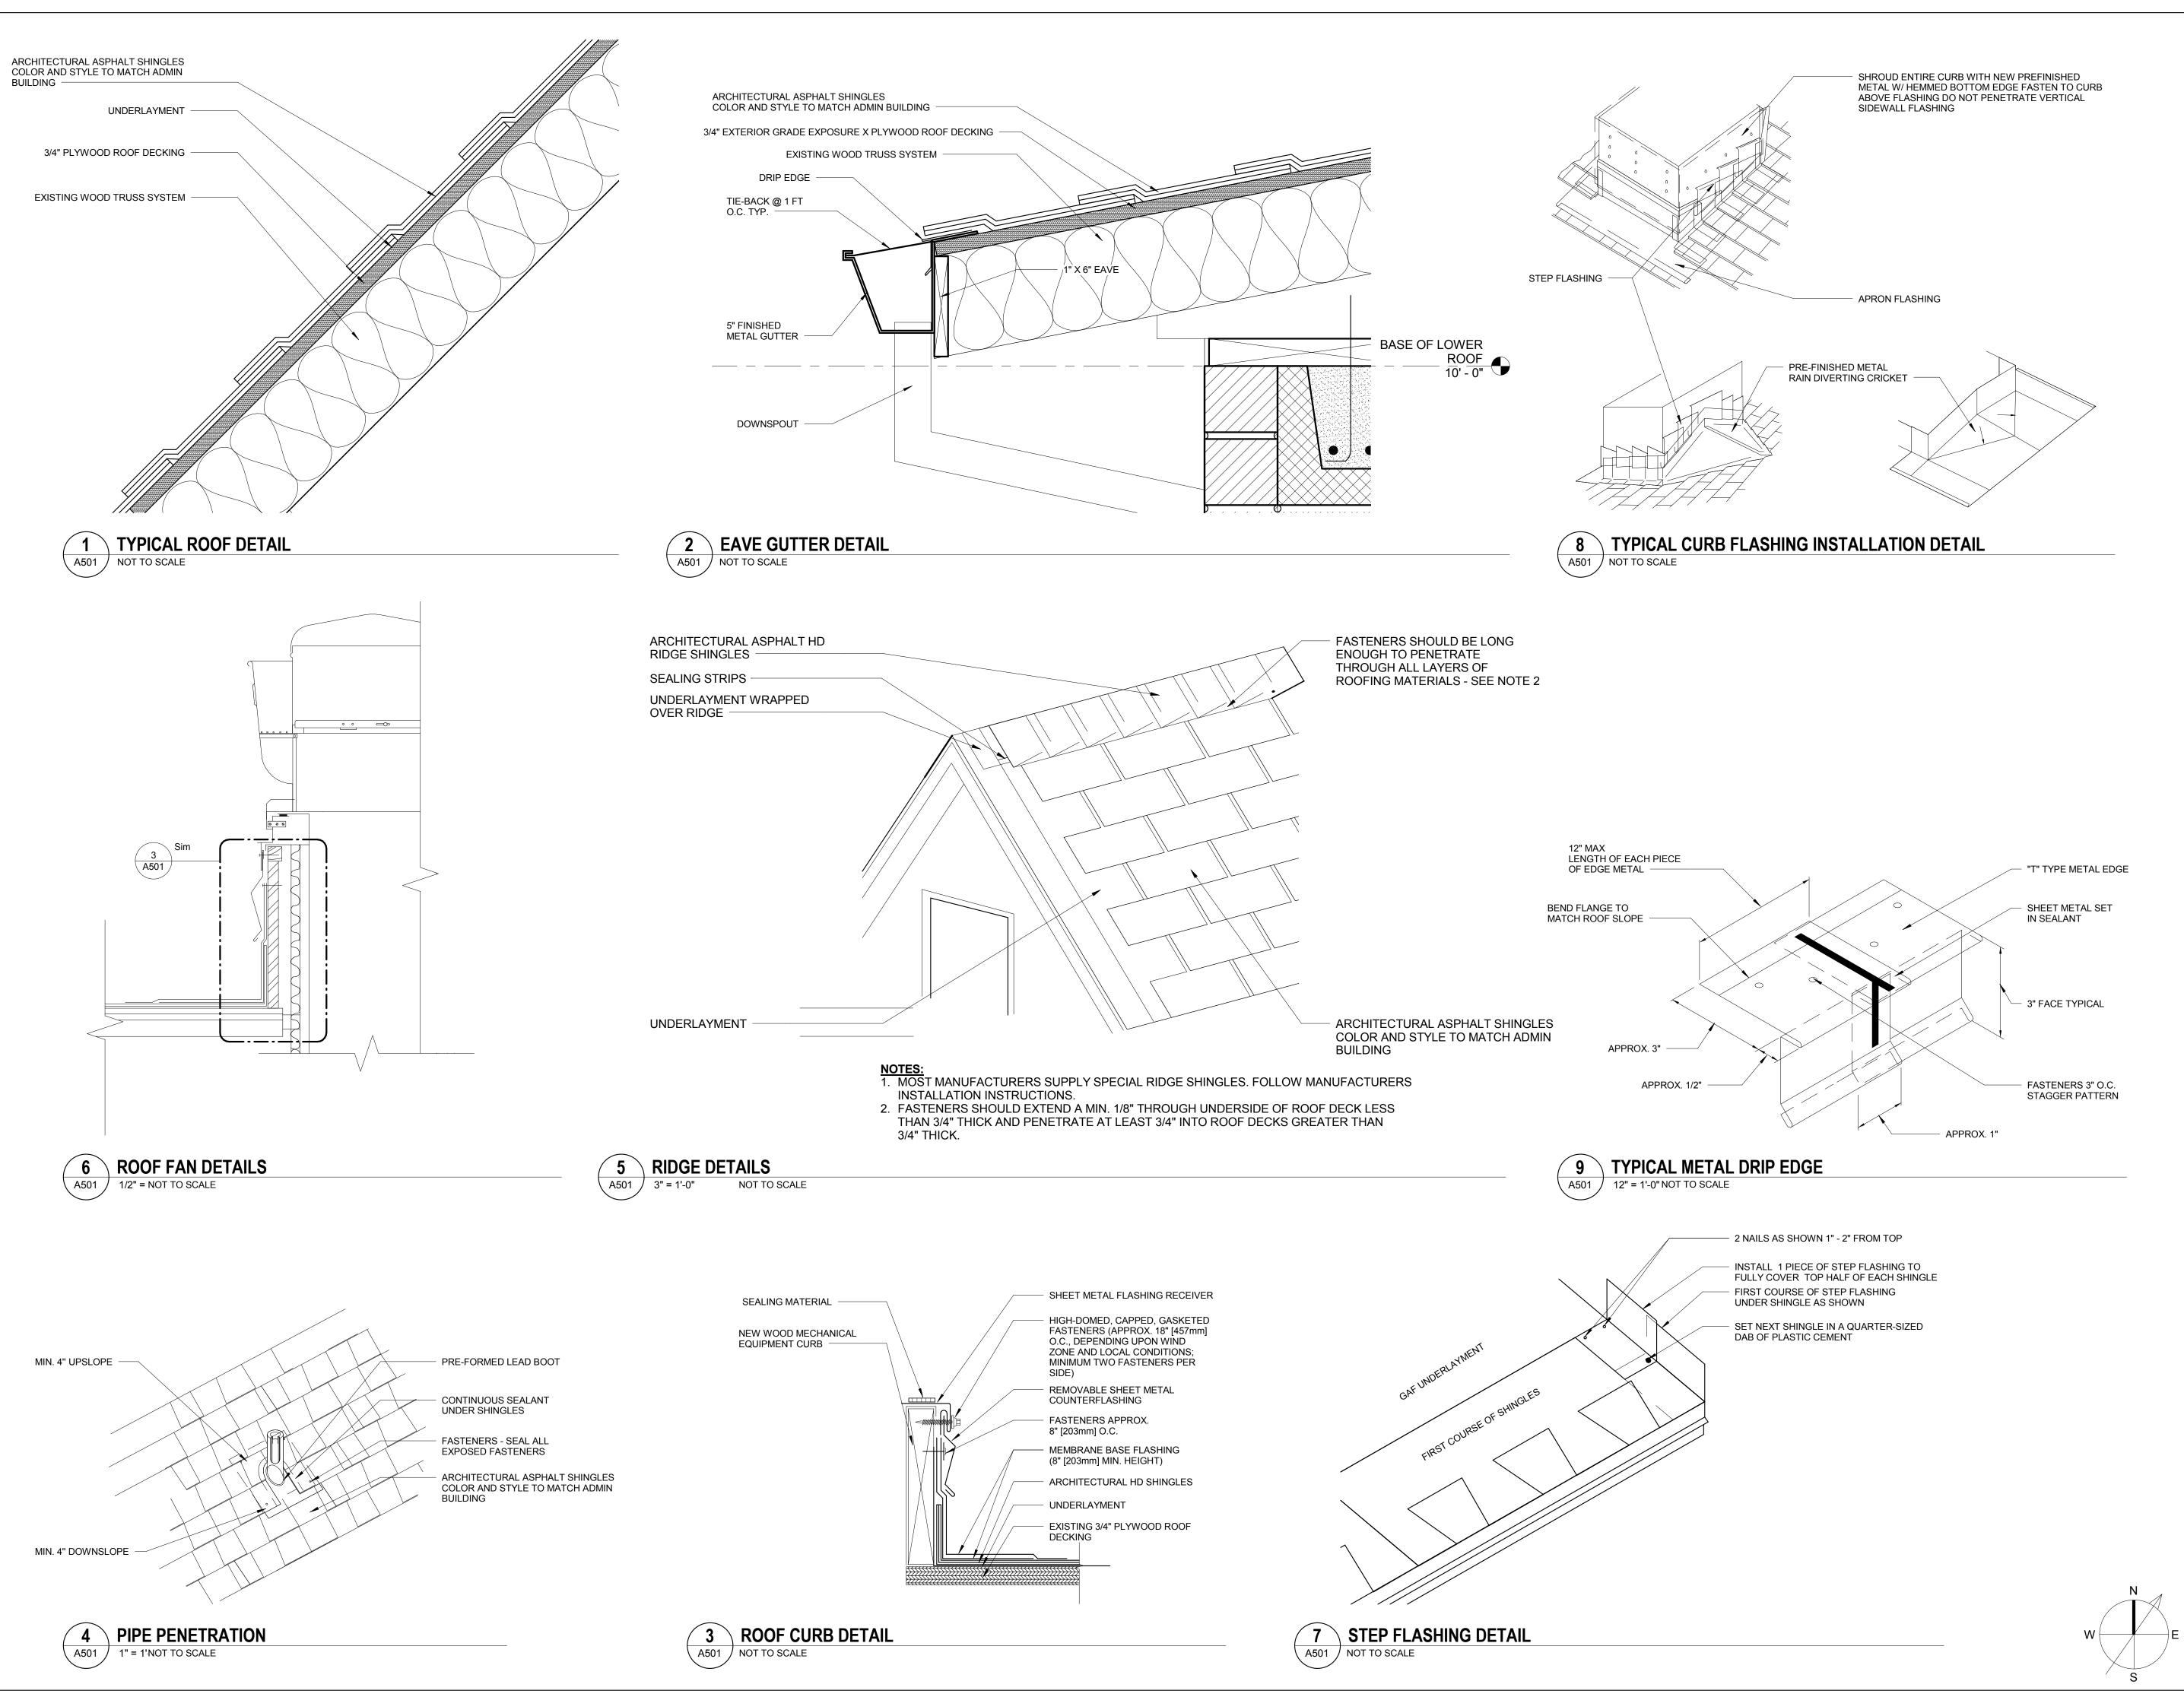

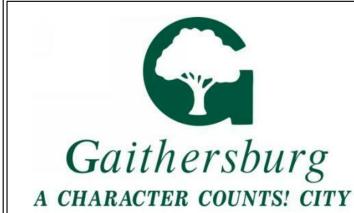

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Drawing Title

ROOF DETAILS


ase ☐ CONCEPT ☐ 35% ☐ 60% ☐ 80% **■** 100%




Checked By AV


Sheet Number

A501

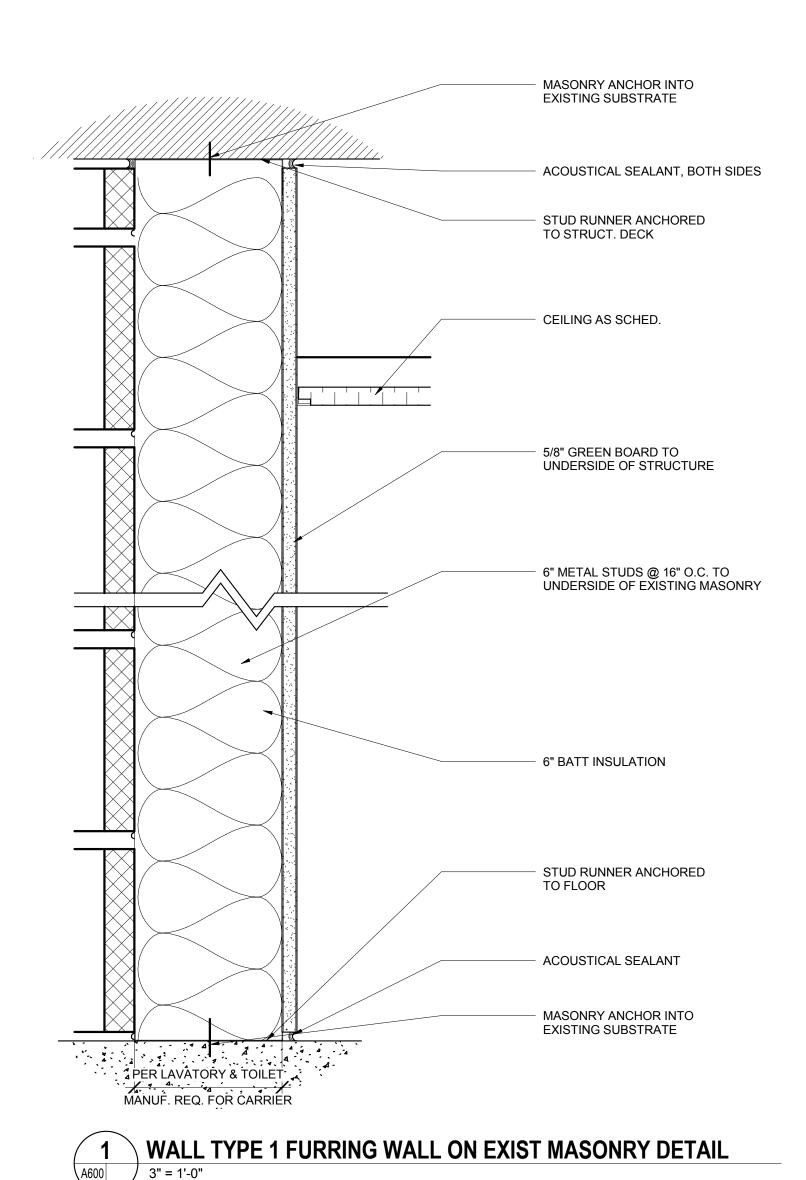


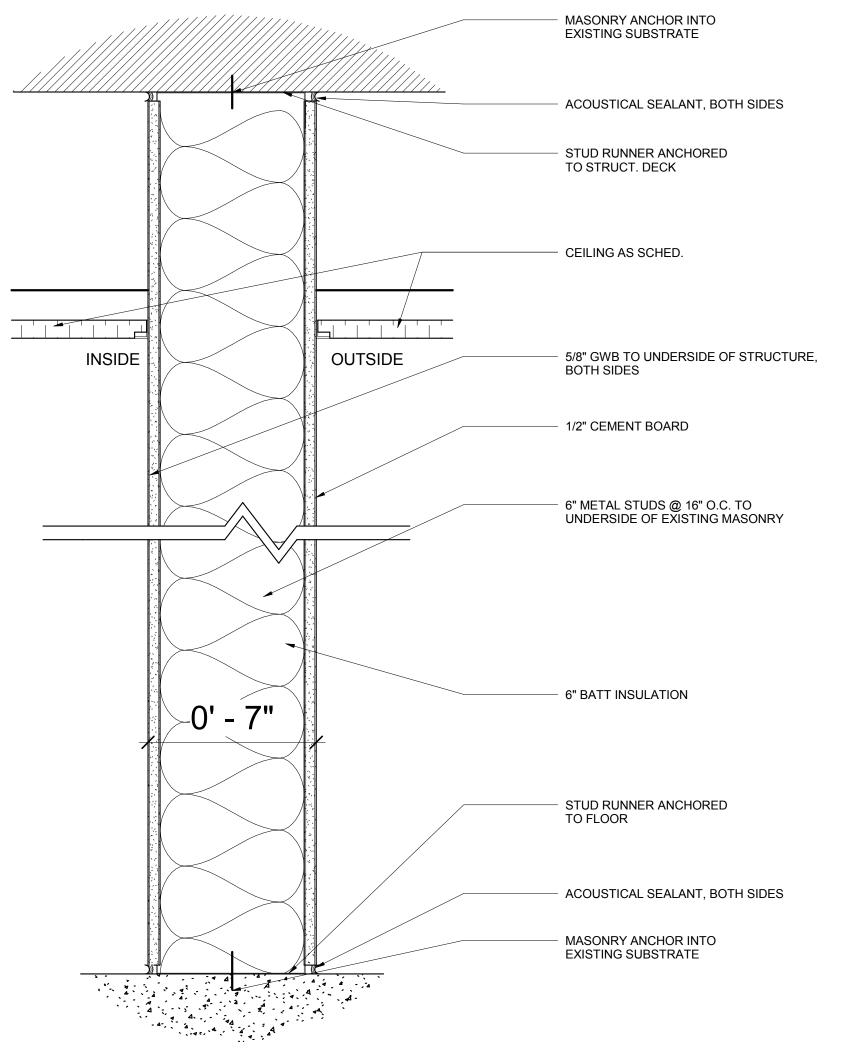

2 WALL 3" = 1'-0"

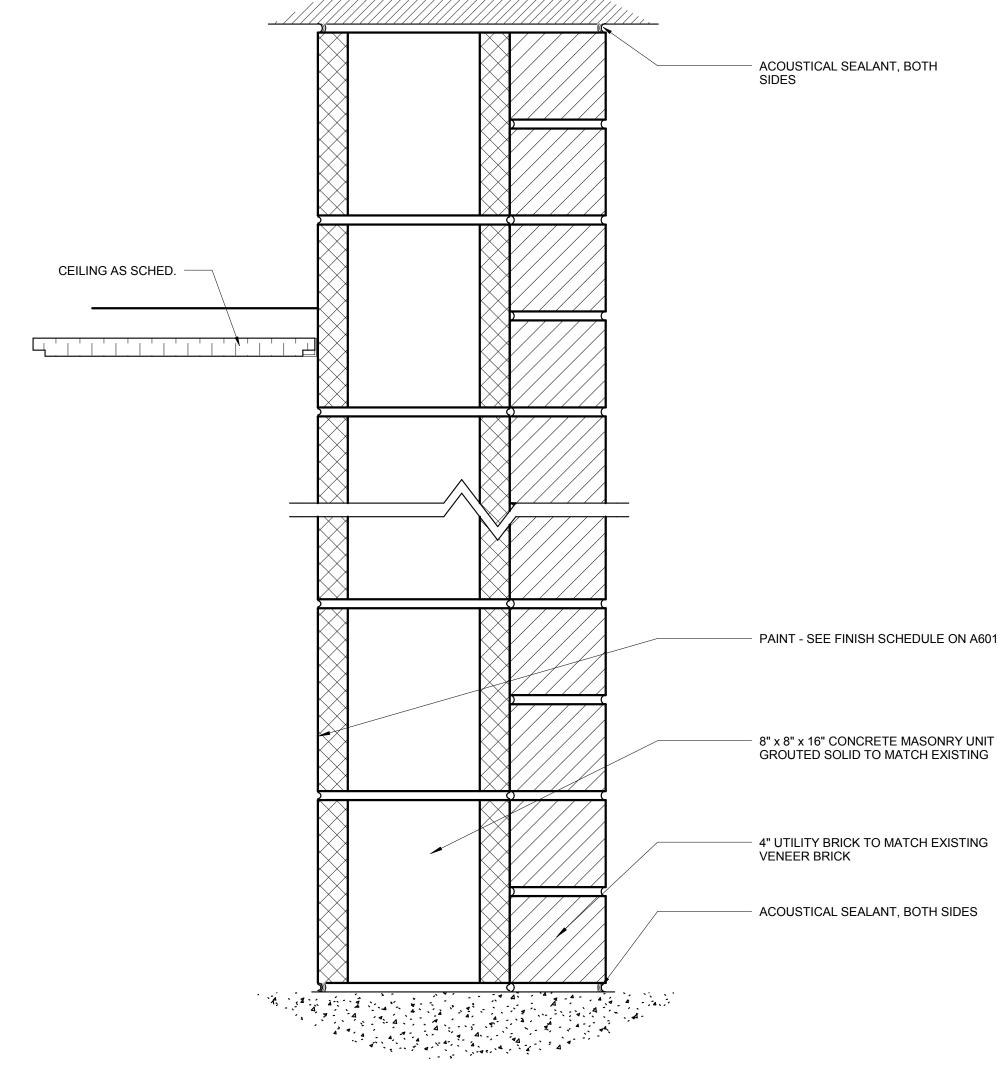

WALL TYPE 2 GWB WALL DETAIL WALL TYPE 3 NEW 12" MASONRY WALLW/BRICK VENEER 3 A600

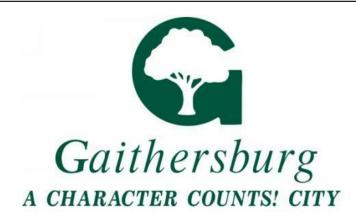

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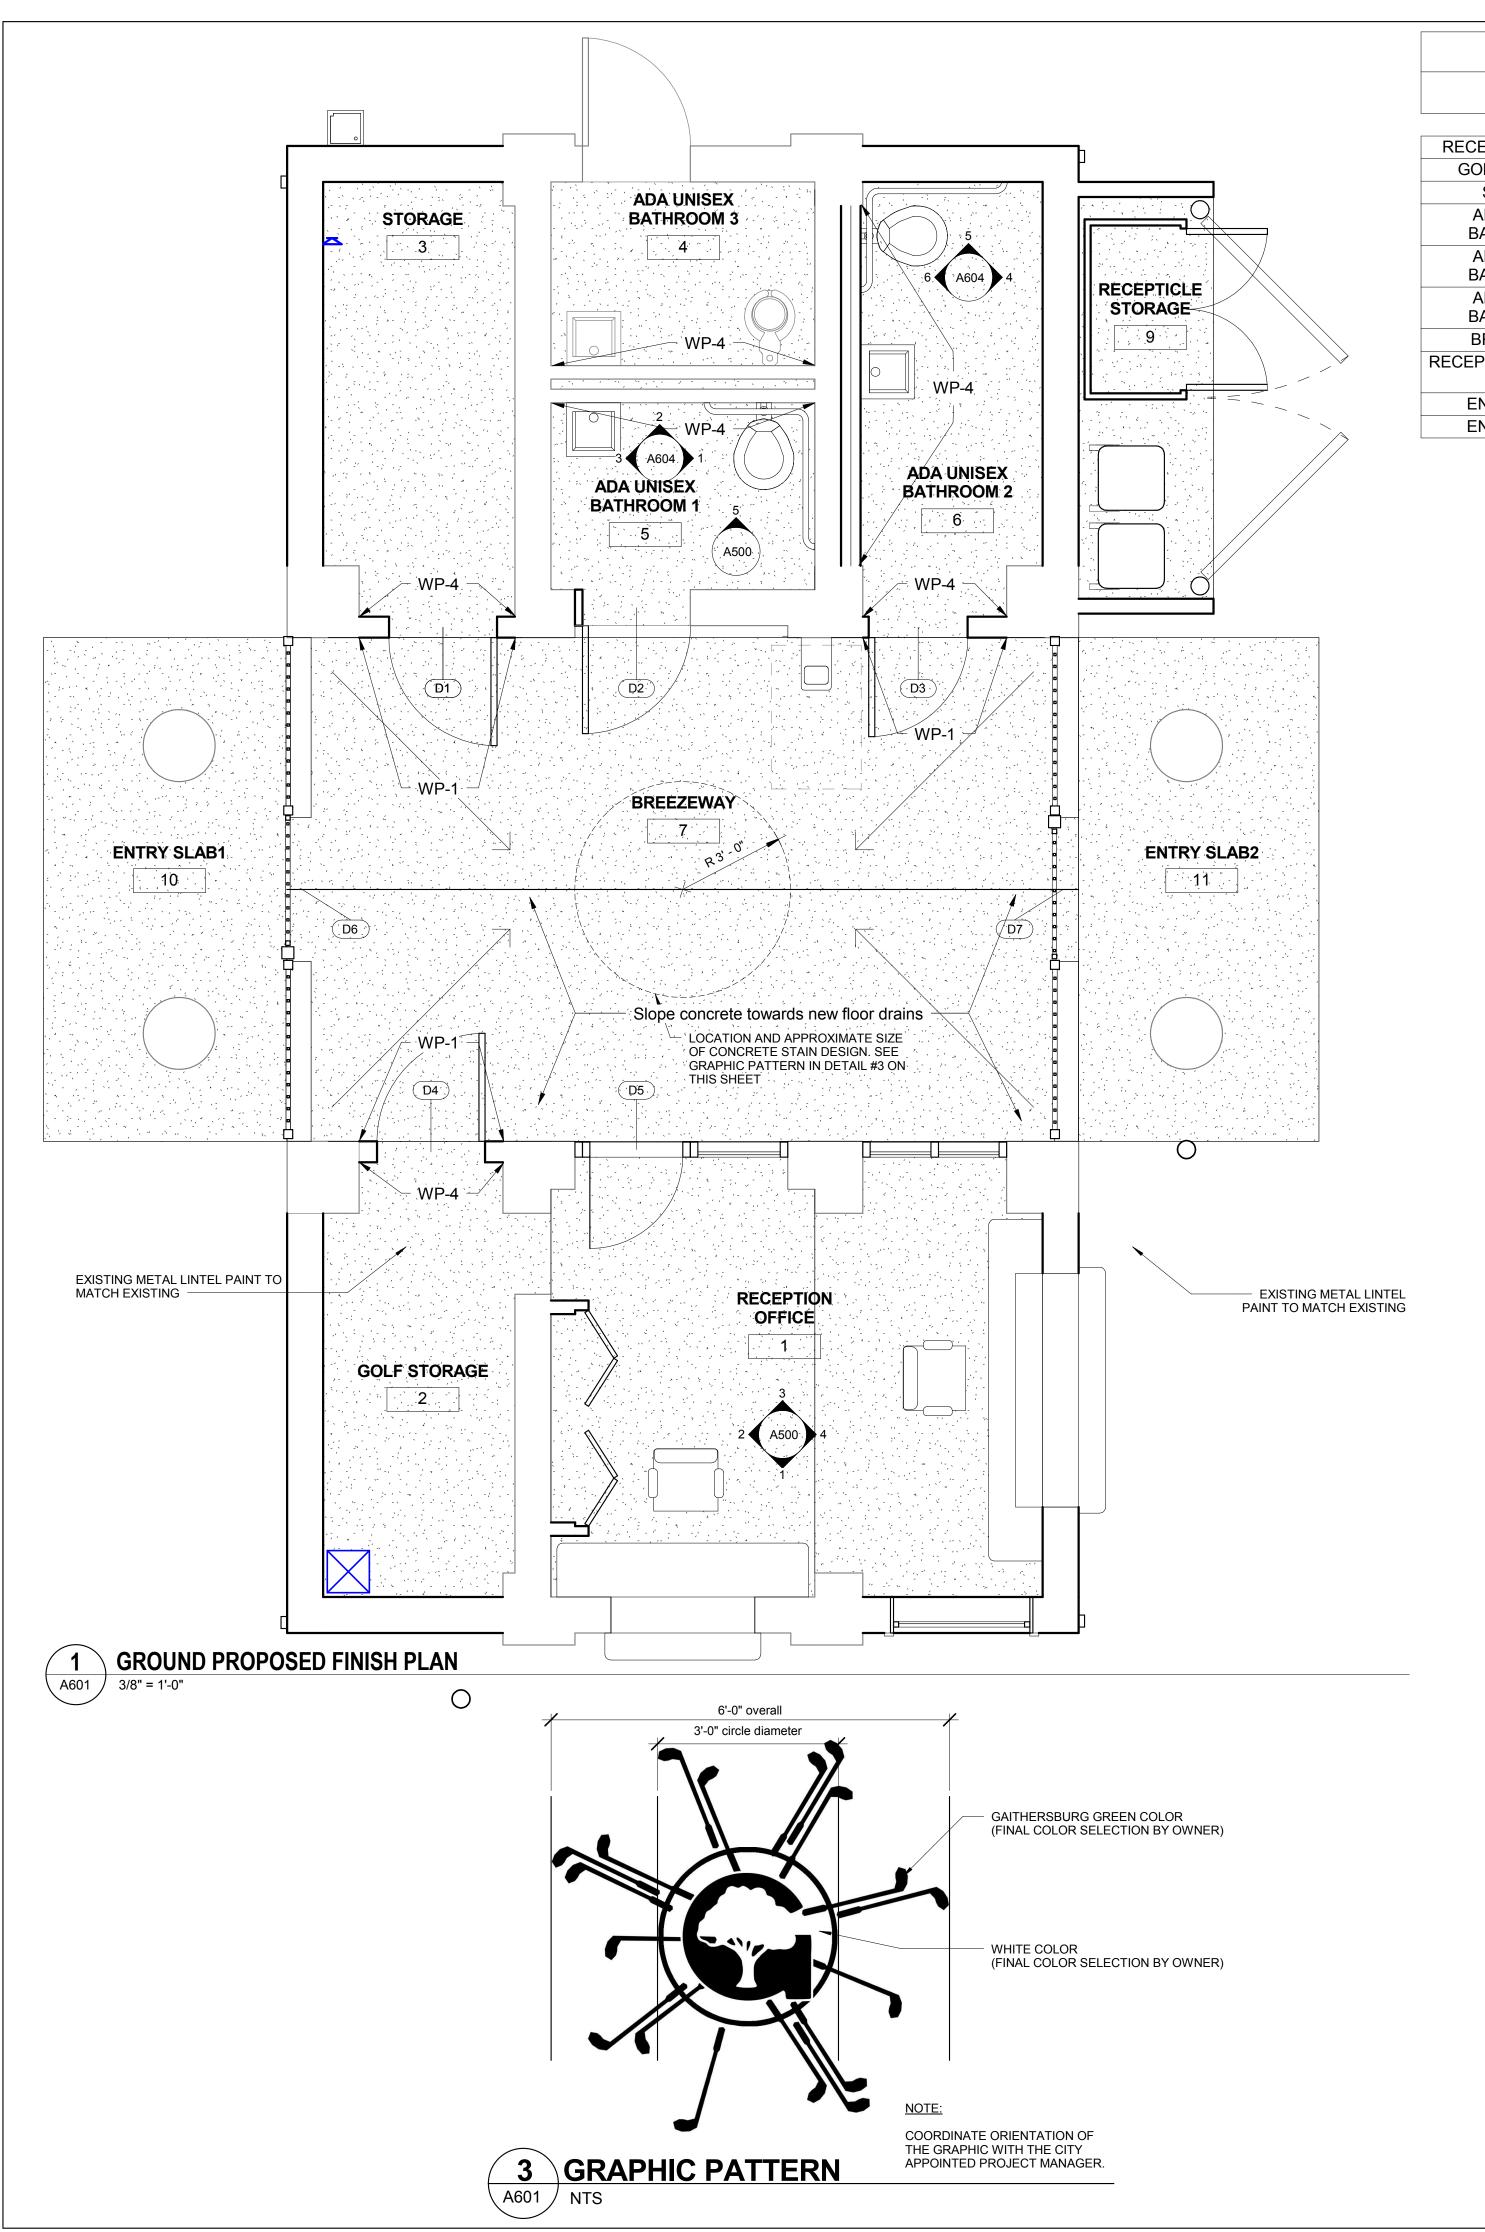
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1	REVISION # 1	06/30/2016		
2	REVISION # 2	07/12/2016		

Drawing Title WALL SCHEDULE CONCEPT 35% 60% 80% 100% A/E Project Number Drawing Scale: AS NOTED 12-0009.012 CADD Filename CADD Plot Scale Revit Model 1:1 06.30.2016 License #15975 ASM & PG Checked By AV Sheet Number **A600** TAE Y. JUNG AND



				ROOM I	FINISH S	CHEDULE		
Name	Number	Area	Floor Finish	Ceiling Type	Ceiling Finish	Wall Finish	Base Finish	Comments
RECEPTION OFFICE	1	163 SF	CF-1	Modular Lay-in Grid	ACT-1	WP-2, WP-3	RB-1	COUNTERTOP FINISH: BRUSHED STAINLESS STEEL
GOLF STORAGE	2	65 SF	CF-1	Gypsum Board-skim coat	CP-1	WP-1, WP-4	RB-1	
STORAGE	3	63 SF	CF-1	Gypsum Board-skim coat	CP-1	WP-1, WP-4	RB-1	Provide 18"18" access panel
ADA UNISEX BATHROOM 3	4	37 SF	CF-1	Existing	CP-1	WP-1, WP-4	NONE	Patch and repair ceiling as required after plumbing connections
ADA UNISEX BATHROOM 1	5	38 SF	CF-1	Existing	CP-1	WP-1, WP-4	NONE	Patch and repair ceiling as required after plumbing connections
ADA UNISEX BATHROOM 2	6	60 SF	CF-1	Gypsum Board-skim coat	CP-1	WP-1, WP-4	NONE	
BREEZEWAY	7	299 SF	CF-2	Existing	CP-1	NONE	NONE	
RECEPTICLE STORAGE	9	12 SF	NONE		NONE	NONE	NONE	Provide manufactured storage container fire rated - coordinate size with city
ENTRY SLAB1	10	89 SF	NONE	Existing	NONE	NONE	NONE	
ENTRY SLAB2	11	87 SF	NONE	Existing	NONE	NONE	NONE	

NISH LEGEND	
DESCRIPTION	COLOR
EXTERIOR GRADE ACRYLIC PAINT, SEMI-GLOSS	COLOR TBD DURING CONSTRUCTION
EXTERIOR GRADE ACRYLIC PAINT, SEMI-GLOSS	COLOR TBD DURING CONSTRUCTION
EXTERIOR GRADE ACRYLIC PAINT, SEMI-GLOSS	COLOR TBD DURING CONSTRUCTION
CONCRETE STAIN TO APPLY COLOR AND WET BASED SEALER	COLOR TBD DURING CONSTRUCTION
JOHNSONITE 1/4" RUBBER WALL BASE	WHITE
DIFFUSER SPECIALIST PLASTIC LOUVERS 45: 1/2X1/2X1/2	COLOR TBD DURING CONSTRUCTION
CONCRETE STAIN TO APPLY COLOR AND WET BASED SEALER	COLOR TBD DURING CONSTRUCTION
LATEX, SW PROMAR 200, ZERO VOC, SEMI-GLOSS FINISH, @ ALL MTL. SURFACES	COLOR TBD DURING CONSTRUCTION
LATEX, SW PROMAR 200, ZERO VOC, FLAT FINISH	COLOR TBD DURING CONSTRUCTION
LATEX, SW PROMAR 200, ZERO VOC, EGGSHELL FINISH	COLOR TBD DURING CONSTRUCTION
	DESCRIPTION EXTERIOR GRADE ACRYLIC PAINT, SEMI-GLOSS EXTERIOR GRADE ACRYLIC PAINT, SEMI-GLOSS EXTERIOR GRADE ACRYLIC PAINT, SEMI-GLOSS CONCRETE STAIN TO APPLY COLOR AND WET BASED SEALER JOHNSONITE 1/4" RUBBER WALL BASE DIFFUSER SPECIALIST PLASTIC LOUVERS 45: 1/2X1/2X1/2 CONCRETE STAIN TO APPLY COLOR AND WET BASED SEALER LATEX, SW PROMAR 200, ZERO VOC, SEMI-GLOSS FINISH, @ ALL MTL. SURFACES LATEX, SW PROMAR 200, ZERO VOC, FLAT FINISH


REFER TO PAINT SPECIFICATIONS ALL PAINT SYSTEMS TO BE COMPATIBLE WITH MATERIALS AND APPLICATIONS PER MPI STANDARDS FINAL COLOR SELECTIONS ARE SUBJECT TO OWNER APPROVAL ALL FLOOR FINISH SHALL MEET OR EXCEED COEFFICIENT OF FRICTION (COF) 0.60 ON THE ASTM C-1028 TEST, WET AND DRY

4' - 11 1/4"

DETAIL OF TRASH ENCLOSURE GATE

3/4" = 1'-0"

COLOR SCHEME OPTIONS: DESCRIPTION COLOR CODE COLOR NAME MANUFACTURER PRODUCT COLOR SCHEME # 1 EXTERIOR GRADE ACRYLIC PAINT ENVY GREEN SHERWIN WILLIAMS SW 6925 EXTERIOR GRADE ACRYLIC PAINT PICNIC LIGHT GREEN SHERWIN WILLIAMS SW 6725 EXTERIOR GRADE ACRYLIC PAINT GREEN SHERWIN WILLIAMS PICKLE LIGHT GREEN SHERWIN WILLIAMS EXTERIOR GRADE ACRYLIC PAINT JARDIN SW 6723 COLOR SCHEME #3 EXTERIOR GRADE ACRYLIC PAINT WITTY GREEN GREEN SHERWIN WILLIAMS LAUDABLE LIME LIGHT GREEN SHERWIN WILLIAMS EXTERIOR GRADE ACRYLIC PAINT SW 6930 COLOR SCHEME # 4 CONCRETE SEALER OPTIONS **RED BROWN** CHEMSTAIN CONCRETE STAIN PRIMARY COLOR CS-2 PADRE BROWN SCOFIELD SYSTEMS CONCRETE STAIN DESIGN COLOR CS-14 DARK WALNUT DARK RED SCOFIELD SYSTEMS CHEMSTAIN COLOR SCHEME # 5 CONCRETE SEALER OPTIONS FADED TERRACOTTA **RED BROWN** SCOFIELD SYSYEMS CHEMSTAIN CONCRETE STAIN PRIMARY COLOR CS-16 CONCRETE STAIN DESIGN COLOR CS-14 COLOR SCHEME # 6 CONCRETE SEALER OPTIONS CONCRETE STAIN PRIMARY COLOR MALAY TAN STONE TONE STAIN MEDIUM BUCKSKIN KEMIKO STONE TONE STAIN CONCRETE STAIN DESIGN COLOR **ENGLISH RED** RUSTY, WARM BROWN KEMIKO

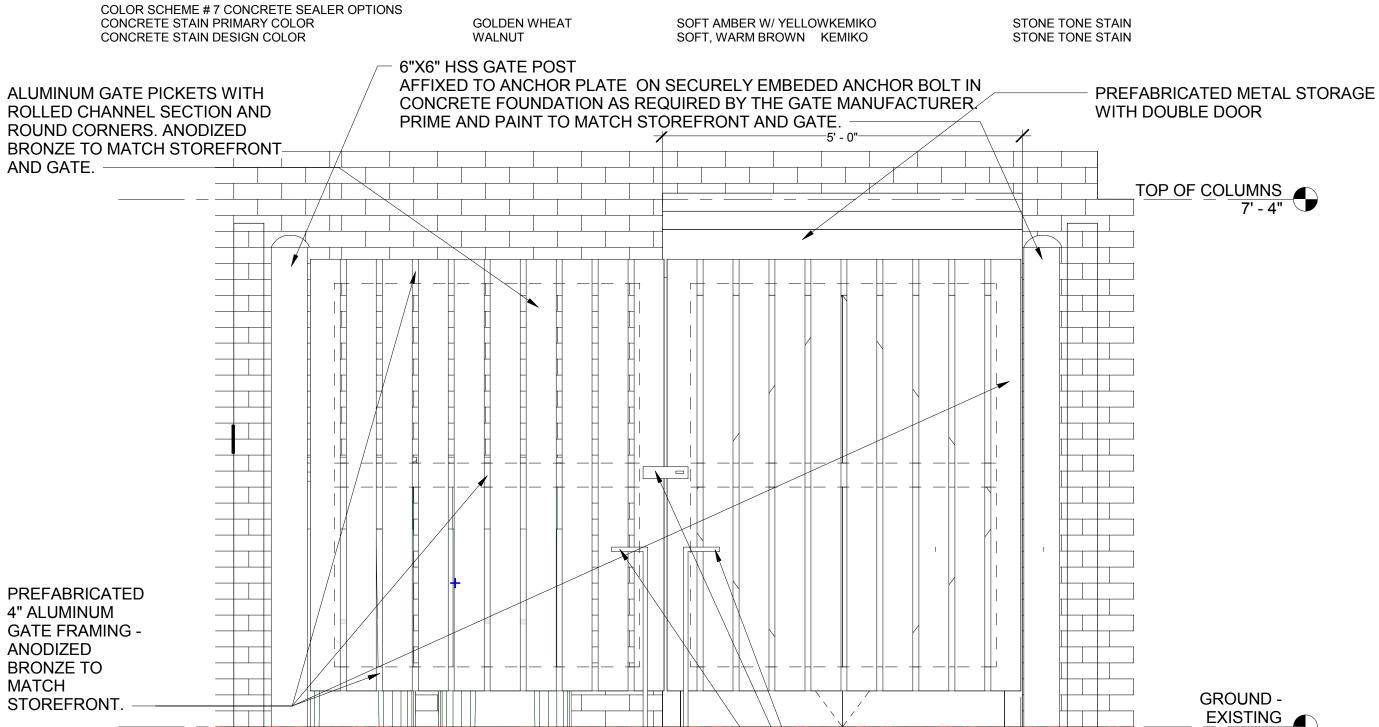

11' - 2"

12' - 0"

4' - 11 1/4"

- GALVANIZED STEEL GATE CLOSING HARDWARE



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No.	Description	Date
1	REVISION # 1	06/30/2016
2	REVISION # 2	07/12/2016

Drawing Title

FINISH SCHEDULE


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A/E Project Number 12-0009.012	Drawing Scale: AS NOTED			
Date 06.30.2016	CADD Filename CADD Filename 1:1			
License #15975	Drawn By ASM			
License #1557	Checked By AV			
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TAEY, JUNG AND	A601			

ASM AV **A601**

CADD Plot Scale

1:1

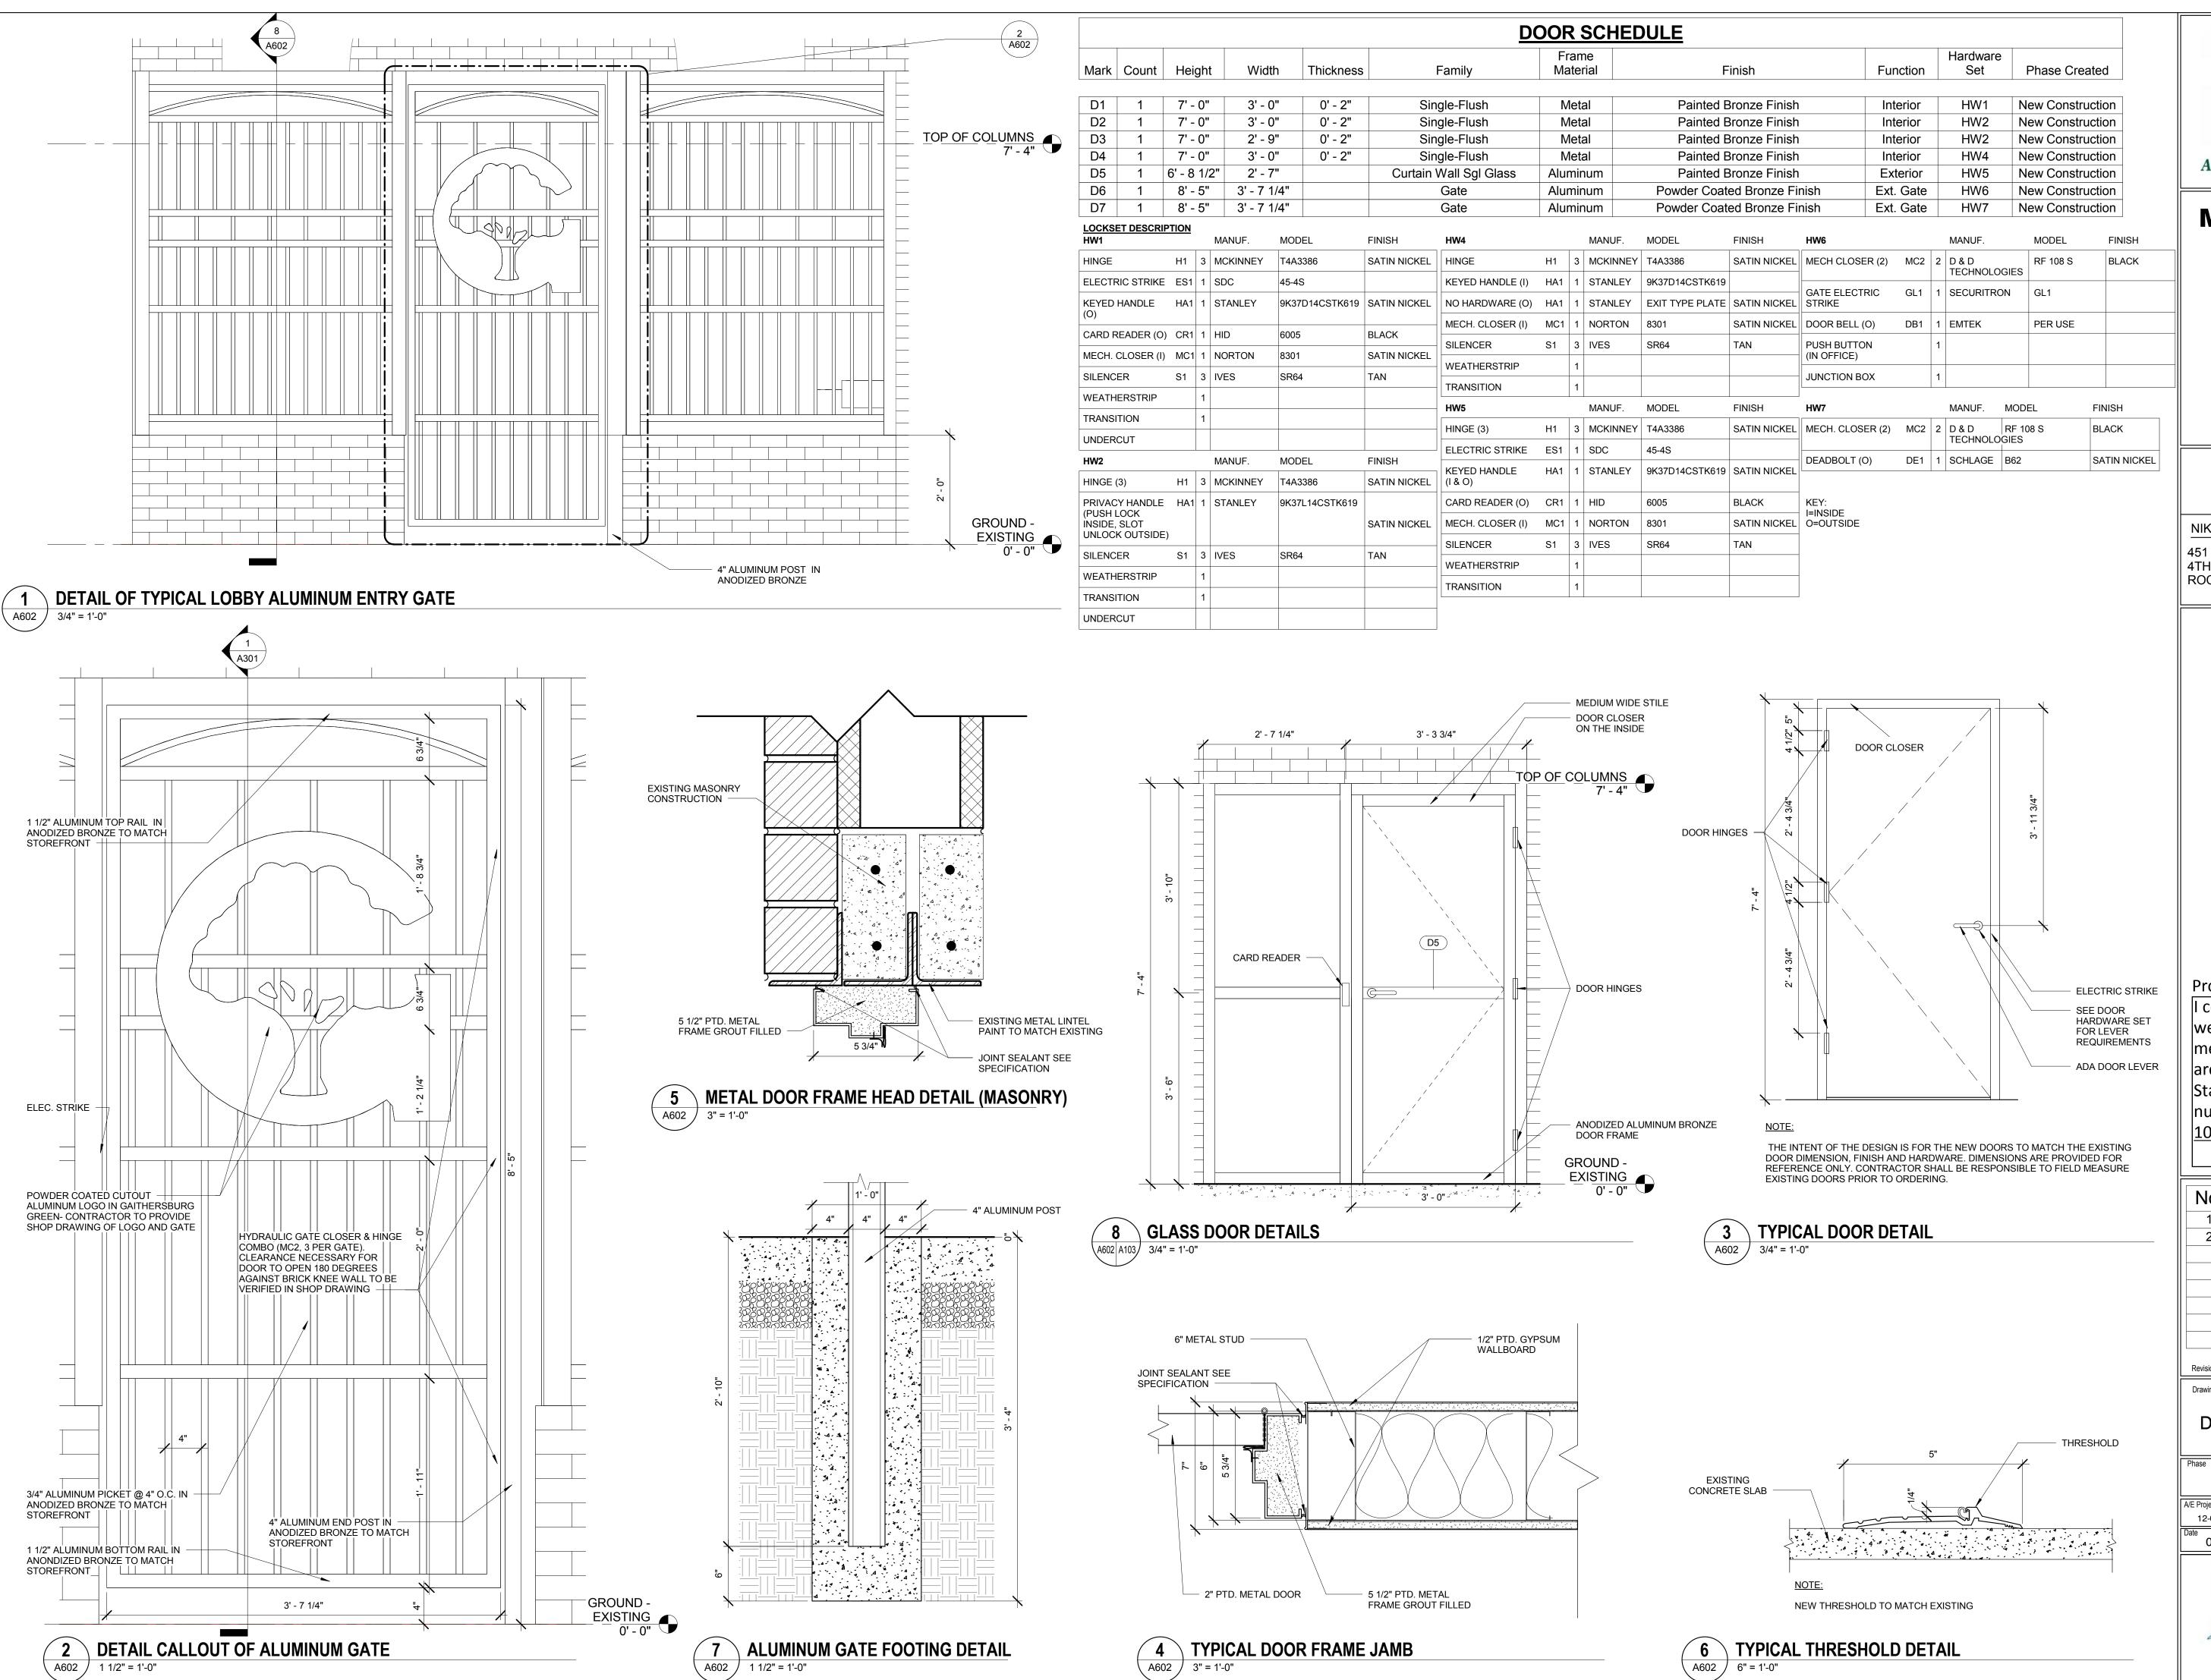

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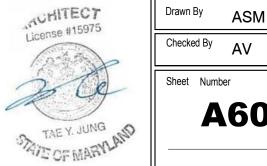
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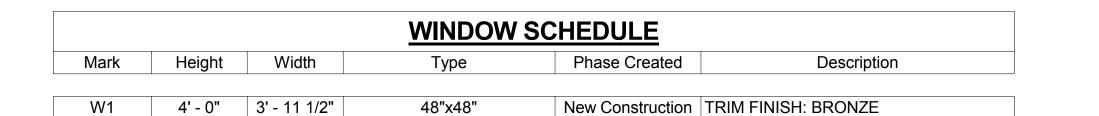
No.	Description	Date
1	REVISION # 1	06/30/2016
2	REVISION # 2	07/12/2016


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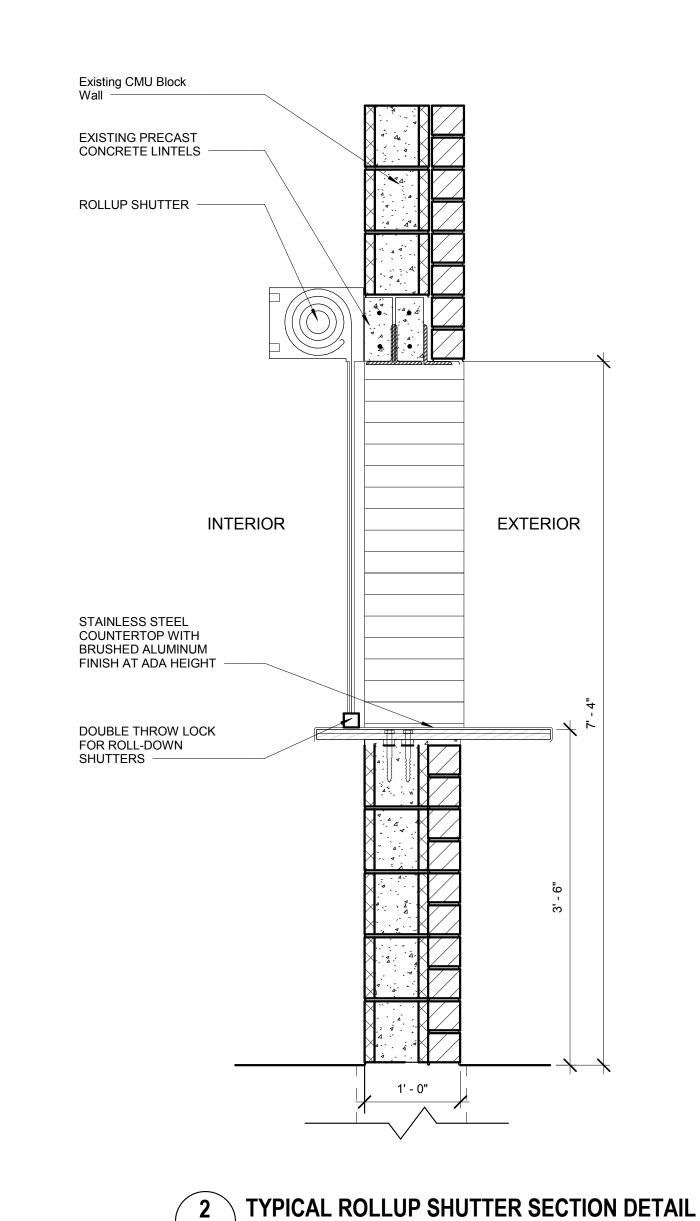
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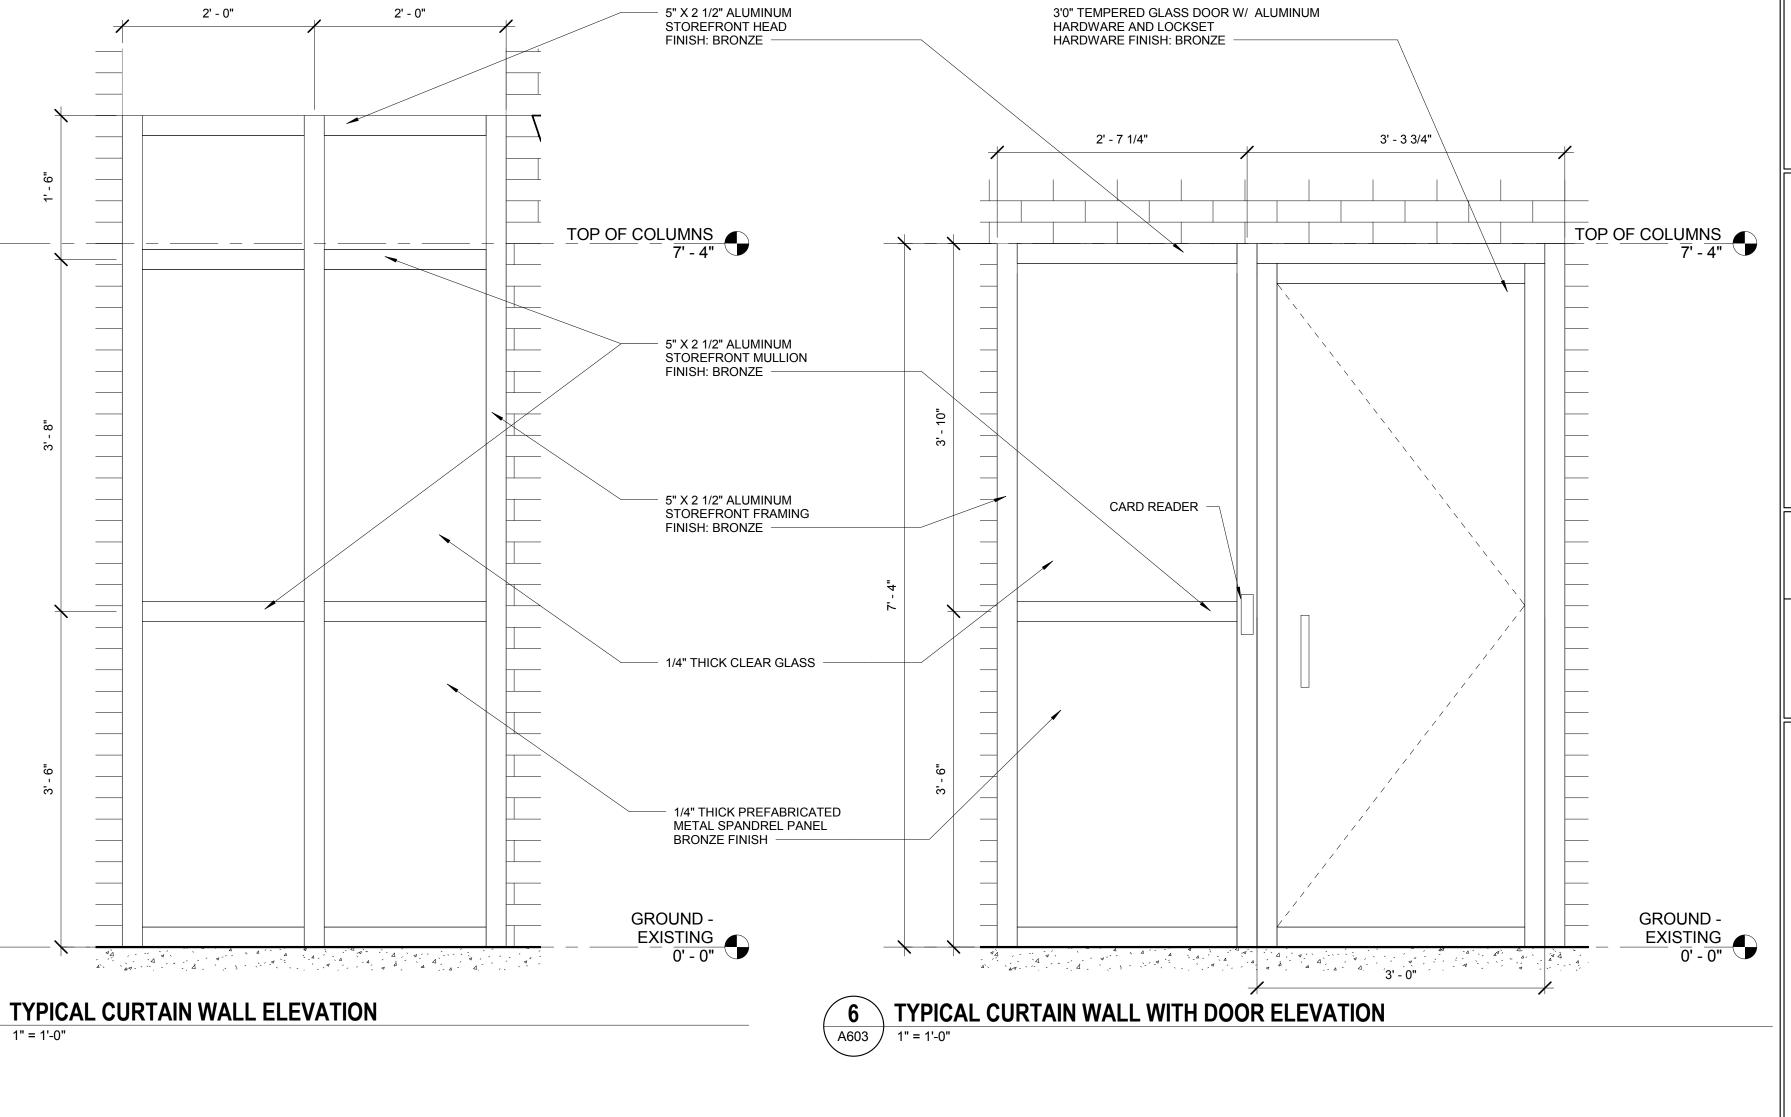










A603

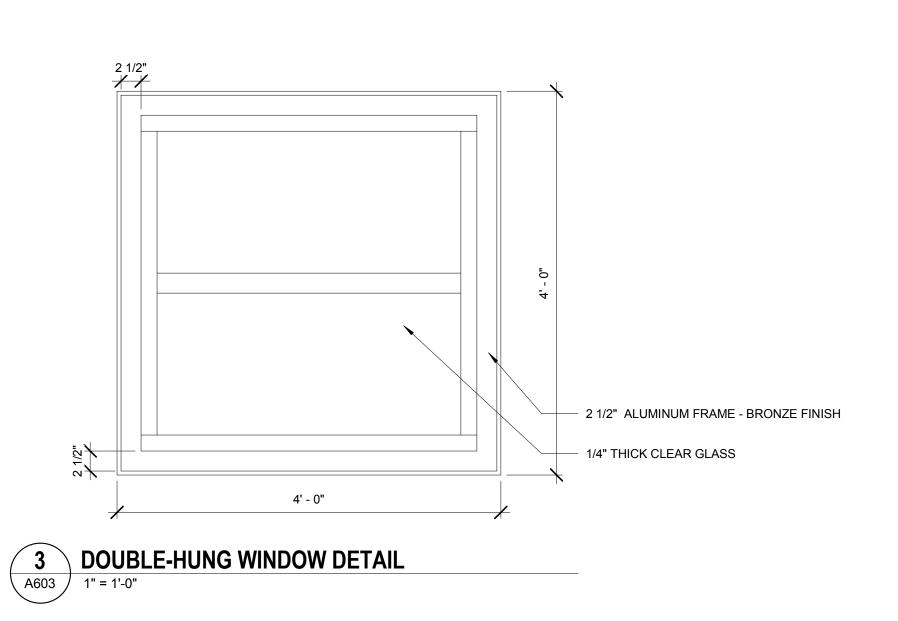

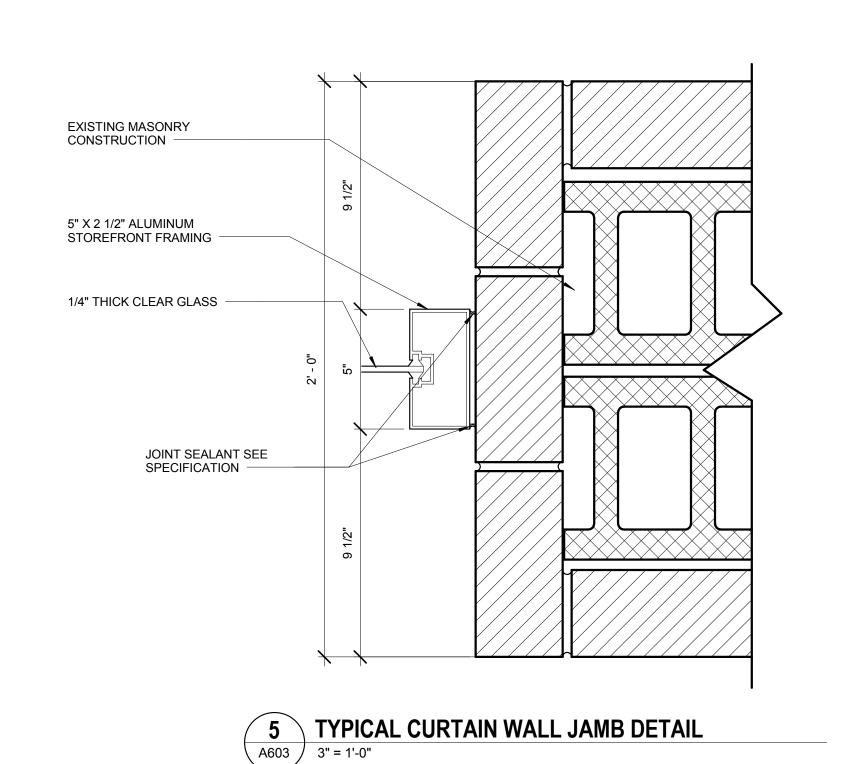

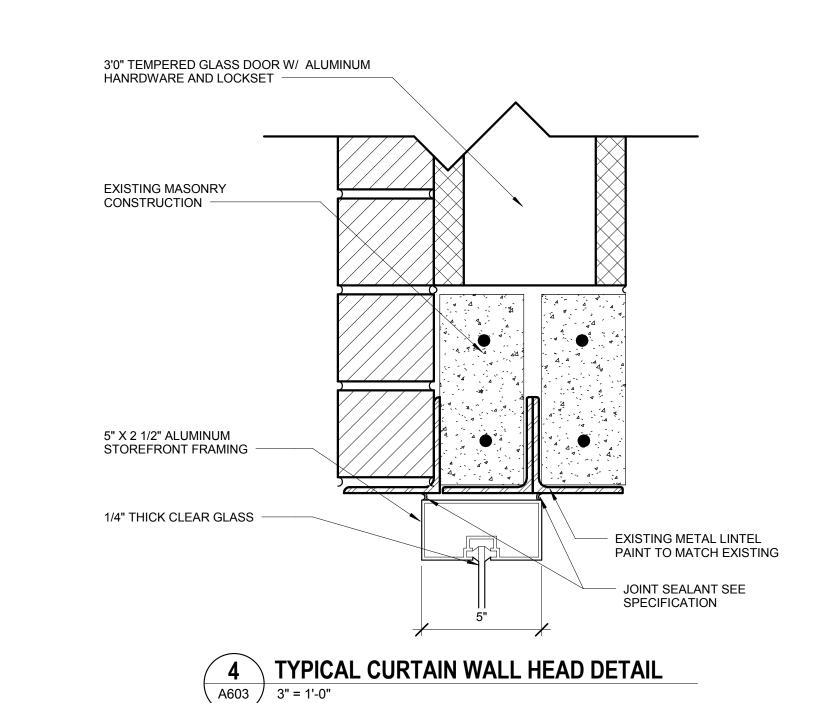



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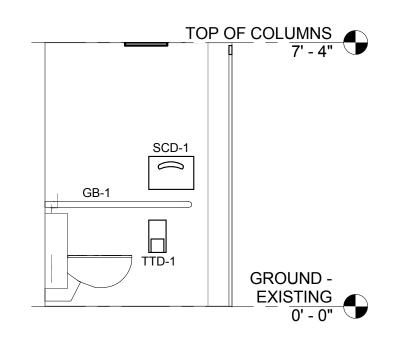
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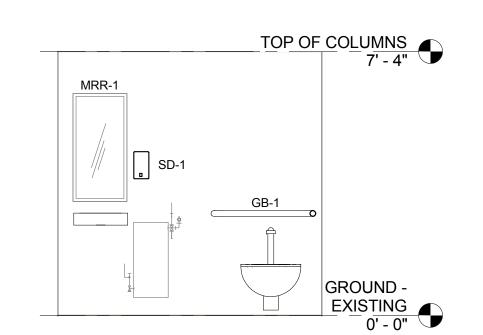
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No.	Descrip	tion		Date				
1	REVISION # 1		06/3	06/30/2016				
2	REVISION # 2		07/1	2/2016				
Revisions								
Drawing Title	1							
Drawing Title	WINDOW S	CHEDU AILS	JLE	&				
Phase	WINDOW S		JLE	&				
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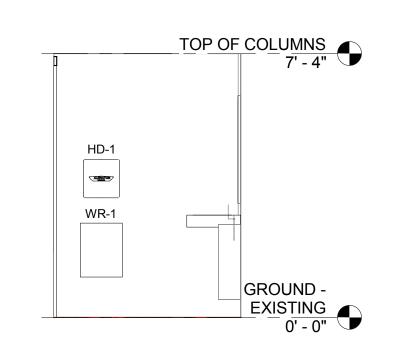
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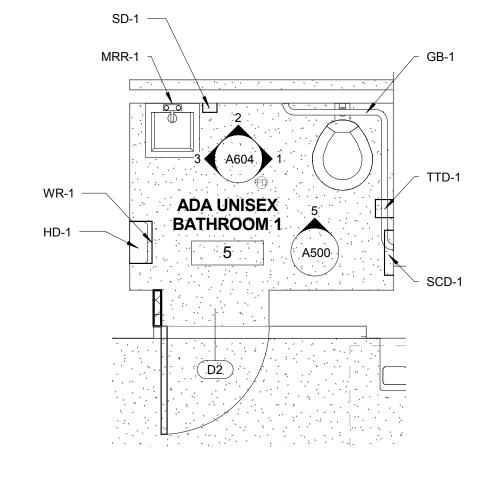




2 BATHROOM 1 NORTH ELEVATION
A604 3/8" = 1'-0"




3 BATHROOM 1 WEST ELEVATION
A604 3/8" = 1'-0"




	BATHROOM 1 PLAN - PROPOSED
A604 A200	3/8" = 1'-0"

	FINISH LEGEND								
KEY	DESCRIPTION	MANUFACTURER	COMMENTS						
GB-1	GRAB BAR		MOUNT PER ADA REQUIREMENTS						
MRR-1	MIRROR		SEE SPEC. FOR TYPE						
SCD-1	SEAT COVER DISPENSER	BRADLEY	SEE PRODUCT DATA						
SD-1	SOAP DISPENSER	BRADLEY	SEE PRODUCT DATA						
WR-1	WASTE RECEPTACLE - SURFACE MOUNTED	BRADLEY	SEE PRODUCT DATA						
TTD-1	TOILET TISSUE DISPENSER	BRADLEY	SEE PRODUCT DATA						
HD-1	ELECTRIC HAND DRYER	EXCEL	SEE PRODUCT DATA						


NOTES:
1. ALL BATHROOM FIXTURES TO BE MOUNTED IN ACCORDANCE WITH ADA REQUIREMENTS.

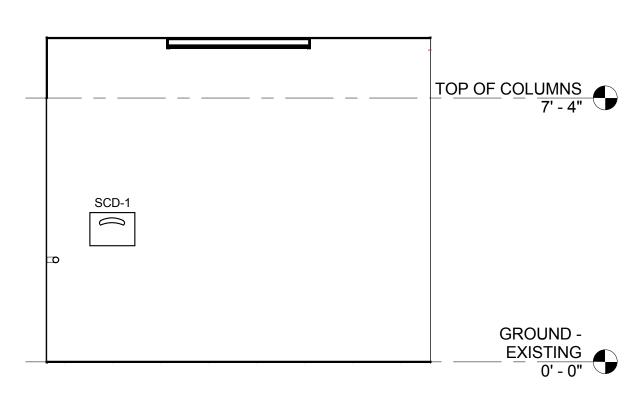


A604 BATHROOM 2 EAST ELEVATION
3/8" = 1'-0"

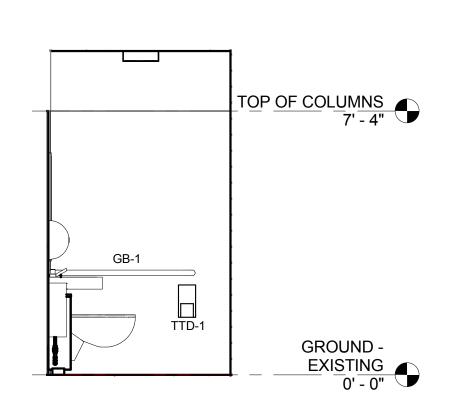

5 BATHROOM 2 NORTH ELEVATION
3/8" = 1'-0"

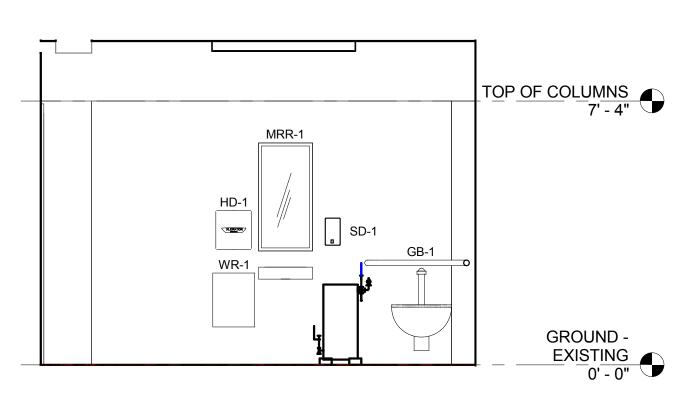



6 BATHROOM 2 WEST ELEVATION
3/8" = 1'-0"

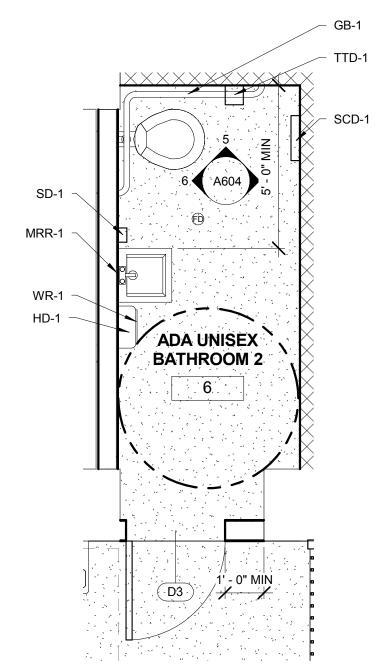

8 Copy of BATHROOM 2 PLAN - PROPOSED

3/8" = 1'-0"

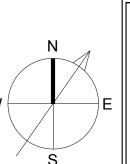

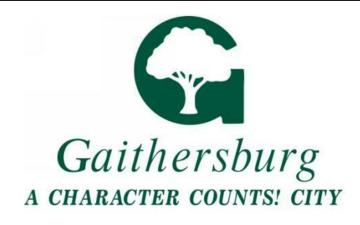

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2	REVISION # 2	07/12/2016

Revision

Drawing Tit

BATHROOM FIXTURE SCHEDULE



Drawn By Author

Checked By Checker

Sheet Number

Sheet Number
A604

1. PROVIDE ALL MATERIALS AND EQUIPMENT AND PERFORM ALL LABOR REQUIRED TO INSTALL COMPLETE AND OPERATE MECHANICAL SYSTEMS AS INDICATED ON THE DRAWINGS. AS SPECIFIED AND AS REQUIRED BY CODE.

2. DRAWINGS ARE SCHEMATIC IN NATURE AND DO NOT NECESSARILY SHOW ALL EXISTING COMPONENTS. COORDINATE INSTALLATION OF NEW EQUIPMENT AND ACCESSORIES WITH EXISTING CONDITIONS. MINOR MODIFICATIONS TO EXISTING COMPONENTS, AT NO ADDITIONAL COST TO THE GOVERNMENT, MAY BE REQUIRED AS TO PROVIDE A COMPLETE AND CODE COMPLIANT SYSTEM.

3. THE GENERAL CONTRACTOR SHALL COORDINATE LOCATIONS OF ALL EXISTING TO REMAIN AND NEW EQUIPMENT, DUCTWORK, HVAC PIPING, PLUMBING PIPING. SPRINKLER PIPING, ELECTRICAL CONDUITS, CABLE TRAYS ETC WITH RESPECTIVE TRADES PRIOR TO DEVELOPING COORDINATION DRAWINGS AND SUBMITTING THEM FOR GOVERNMENT REVIEW AND APPROVAL. UNDER NO CIRCUMSTANCES SHALL THE CONTRACTOR BEGIN FABRICATION AND/OR INSTALLATION OF ANY EQUIPMENT/ DUCTWORK/ PIPING/ ELECTRICAL/ SPRINKLER/ CABLE TRAYS PRIOR TO RECEIVING APPROVED COORDINATION DRAWINGS FROM GOVERNMENT.

4. INSTALL ALL MECHANICAL EQUIPMENT AND APPURTENANCES IN ACCORDANCE WITH MANUFACTURERS' RECOMMENDATIONS, CONTRACT DOCUMENTS AND APPLICABLE CODES AND REGULATIONS.

5. COORDINATE CONSTRUCTION OF ALL MECHANICAL WORK WITH ARCHITECTURAL, STRUCTURAL, CIVIL, ELECTRICAL WORK, ETC., SHOWN ON OTHER DRAWINGS.

6. LOCATIONS OF ALL ITEMS SHOWN ON THE DRAWINGS OR CALLED FOR IN THE SPECIFICATIONS THAT ARE NOT DEFINITELY FIXED BY DIMENSIONS ARE APPROXIMATE ONLY. THE EXACT LOCATIONS NECESSARY TO SECURE THE BEST CONDITIONS AND RESULT MUST BE DETERMINED BY THE PROJECT SITE CONDITIONS AND SHALL HAVE THE APPROVAL OF THE ENGINEER BEFORE BEING INSTALLED. DO NOT SCALE DRAWINGS.

7. LOCATIONS AND SIZES OF ALL FLOOR, AND WALL OPENINGS SHALL BE COORDINATED WITH ALL OTHER TRADES INVOLVED.

8. ALL OPENINGS IN FIRE WALLS DUE TO DUCTWORK, PIPING, CONDUIT, ETC SHALL BE FIRE STOPPED/BLOCKED WITH AN APPROVED PRODUCT.

9. PROVIDE LAMINATED SHEET IN BINDERS FOR EACH EQUIPMENT SYSTEM CONTROL DIAGRAM AND SEQUENCE OF OPERATION FOR USE BY FACILITY MAINTENANCE STAFF.

10. MOUNT ALL OVERHEAD UTILITIES AND OTHER FIXTURES WEIGHING 31 POUNDS OR MORE (EXCLUDING DISTRIBUTED SYSTEMS SUCH AS PIPING NETWORKS THAT COLLECTIVELY EXCEED THAT WEIGHT) TO MINIMIZE THE LIKELIHOOD THAT THEY WILL FALL AND INJURE BUILDING OCCUPANTS. DESIGN ALL EQUIPMENT MOUNTINGS TO RESIST FORCES OF 0.5 TIMES THE EQUIPMENT WEIGHT IN ANY HORIZONTAL DIRECTION AND 1.5 TIMES THE EQUIPMENT WEIGHT IN THE DOWNWARD DIRECTION. THIS STANDARD DOES NOT PRECLUDE THE NEED TO DESIGN EQUIPMENT MOUNTINGS FOR FORCES REQUIRED BY OTHER CRITERIA SUCH AS SEISMIC STANDARDS.

11. LOCATE ALL MECHANICAL EQUIPMENT FOR UNOBSTRUCTED ACCESS TO UNIT ACCESS PANELS AND CONTROLS.

12. ANY WORK TO EQUIPMENT, IT'S ACCESSORIES OR SUPPORTING COMPONENTS UNDER WARRANTY SHALL BE PROVIDED ONLY BY A CONTRACTOR OR VENDOR THAT WILL MAINTAIN THE VALIDITY OF THE WARRANTY.

13. SIZES AND LOCATIONS OF ALL EXISTING EQUIPMENT, DUCTWORK, PIPING, CONTROLS, SUPPORTS, ELECTRICAL AND APPURTENANCES ARE APPROXIMATE CONTRACTOR SHALL FIELD VERIFY EXISTING CONDITIONS PRIOR TO BID AND START OF WORK. CONTRACTOR SHALL COORDINATE ALL RELATED EFFORTS WITH

14. REPAIR/REAPPLY EXISTING INSULATION THAT BECOMES DAMAGED OR REMOVED DURING CONSTRUCTION.

15. ALL DUCTWORK, HVAC UNITS, DIFFUSERS, GRILLES, PIPING, VALVES, ETC., OUTSIDE OF THE LIMIT OF WORK AREA REPRESENT EXISTING TO REMAIN ITEMS THAT ARE NOT PART OF THIS CONTRACT. ITEMS ARE INDICATED FOR REFERENCE ONLY UNLESS NOTED OTHERWISE.

16. CONTRACTOR SHALL COORDINATE PHASING OF UTILITIES TO MINIMIZE IMPACT ON SERVICES / FACILITIES TO REMAIN IN OPERATION DURING CONSTRUCTION.

MECHANICAL SYMBOLS AND ABBREVIATIONS

AIR REGISTER/GRILLE

VOLUME DAMPER

ROUND DUCT SIZE

THERMOSTAT

RECTANGULAR DUCTWORK

RECTANGULAR DUCTWORK

EXHAUST AIR (* DUCT SIZE)

RECTANGULAR DUCT SIZE.

HORIZONTALLY MOUNTED EXHAUST/RETURN

EXHAUST/RETURN/RELIEF AIR ELBOW UP

EXHAUST/RETURN/RELIEF AIR ELBOW DOWN

FIRST NUMBER INDICATES SIZE FOR SIDE SHOWN

DOOR UNDERCUT AIR FLOW DIRECTION

ABBR.

SYMBOL

24"Ø

24X12

(T)

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MECHANICAL SPECIFICATIONS

1.1 ALL WORK SHALL CONFORM TO ALL LOCAL AND STATE CODES, RULES AND REGULATIONS.

1.2 CONTRACTOR SHALL OBTAIN AND PAY FOR ALL PERMITS, FEES AND TAXESCONTRACTOR SHALL OBTAIN AND PAY FOR ALL PERMITS, FEES AND TAXES.

1.3 MAKE NO CHANGES WITHOUT THE WRITTEN PERMISSION FROM THE ARCHITECT.

1.4 ALL MATERIAL AND EQUIPMENT INDICATED ON THE PLANS AND DESCRIBED IN THE SPECIFICATIONS SHALL BE PROVIDED BY THE CONTRACTOR NEW AND THE BEST PRODUCTS OF REPUTABLE MANUFACTURERS AND SHALL BE IN NEW CONDITION AT ACCEPTANCE OF WORK.

1.5 THIS CONTRACTOR SHALL GUARANTEE ALL MATERIALS, LABOR AND EQUIPMENT FOR A PERIOD OF ONE YEAR FROM DATE OF ACCEPTANCE. CONTRACTOR SHALL PAY FOR ANY REPAIRS OR REPLACEMENTS CAUSED BY DEFECTIVE WORKMANSHIP OR FAULTY MATERIALS AS CONSTRUED HEREIN WITHIN THE PERIOD COVERED BY THE GUARANTEE.

1.6 SCAFFOLDING, RIGGING AND HOISTING: UNLESS OTHERWISE SPECIFIED, CONTRACTOR SHALL FURNISH ALL SCAFFOLDING, RIGGING, HOISTING, AND SERVICES NECESSARY FOR ERECTION AND DELIVERY INTO THE PREMISES OF ANY EQUIPMENT AND APPARATUS FURNISHED, AND REMOVAL OF SAME FROM PREMISES WHEN NO LONGER REQUIRED.

1.7 CONTRACTOR SHALL MAKE AN ON-SITE INSPECTION TO DETERMINE FULLY THE EXISTING CONDITIONS AND THE EXTENT OF DEMOLITION.

1.8 CONTRACTOR SHALL VERIFY SIZES AND LOCATIONS OF EXISTING DUCTWORK AND PIPING BEFORE PURCHASING NEW MATERIALS AND EQUIPMENT OR FABRICATING NEW DUCTWORK.

1.9 LOCATION OF EQUIPMENT AND OTHER MECHANICAL WORK IS INDICATED DIAGRAMMATICALLY BY THE DRAWINGS. DETERMINE EXACT LOCATIONS ON THE JOB SITE, SUBJECT TO STRUCTURAL CONDITIONS AND WORK OF OTHER CONTRACTORS.

1.10 CONTRACTOR ASSUMES RESPONSIBILITY FOR PROPER ARRANGEMENT OF PIPES, DUCTS, ETC., TO CONNECT APPROVED EQUIPMENT IN A PROPER AND APPROVED MANNER. FOLLOW EQUIPMENT MANUFACTURER'S DETAILED INSTRUCTIONS AND THE CONTRACT DOCUMENTS. NOTIFY THE ARCHITECT BEFORE PROCEEDING. NO EQUIPMENT INSTALLATION OR CONNECTIONS SHALL BE MADE IN A MANNER THAT VOIDS THE MANUFACTURER'S WARRANTY.

1.11 SEE ARCHITECTURAL DRAWINGS FOR SUPPORT DETAILS OF ALL ROOF MOUNTED EQUIPMENT AND FOR THE LOCATION OF ROOF PENETRATIONS.

1.12 UNLESS OTHERWISE NOTED, ALL SPECIFIED EQUIPMENT IS LESS THAN 200 POUNDS. SEE ARCHITECTAL DRAWINGS FOR SUPPORT DETAILS OF ALL EQUIPMENT GREATER THAN 200 LBS.

1.13 INSTALL EACH ITEM OF EQUIPMENT IN STRICT ACCORDANCE WITH MANUFACTURER'S RECOMMENDATIONS.

1.15 INSTALL ALL WORK IN A NEAT AND WORKMANLIKE MANNER, USING ONLY WORKMEN THOROUGHLY QUALIFIED IN THE TRADE OF DUTIES THEY ARE TO PERFORM. ROUGH WORK WILL BE

1.16 CUTTING AND PATCHING SHALL BE DONE BY THE APPROPRIATE TRADE UNLESS OTHERWISE REQUIRED BY TRADE CUSTOM OR SPECIFIED UNDER ANOTHER SECTION OF THE SPECIFICATIONS. CONTRACTOR SHALL FURNISH SKETCHES SHOWING THE LOCATIONS AND SIZES OF ALL OPENINGS, CHASES, ETC. REQUIRED. CONTRACTOR IS LIABLE FOR CUTTING OR PATCHING MADE NECESSARY BY HIS FAILURE TO MAKE PROPER ARRANGEMENTS IN THIS RESPECT.

1.17 DO NOT CUT STRUCTURAL MEMBERS WITHOUT THE APPROVAL OF THE ARCHITECT AND ALL SUCH CUTTING SHALL BE DONE IN A MANNER AS DIRECTED BY THEM.

1.18 MAINTAIN WORK AREA CLEAN AT ALL TIMES DURING CONSTRUCTION. AFTER COMPLETING INSTALLATIONS OF DUCTWORK, CONTRACTOR SHALL CLEAN ENTIRE SYSTEM OF RUBBISH, PLASTER, DIRT AND ANY OTHER DEBRIS.

1.19 TEST ALL SYSTEMS. SYSTEMS SHALL OPERATE SATISFACTORILY AS DESIGNED AND INTENDED. REPORT ANY DEFICIENCIES TO [ARCHITECT][ENGINEER].

1.20 ANY AND ALL MATERIALS AND INSTALLATION METHODS USED IN THE MODIFICATION OF THE EXISTING ROOF SYSTEM SHALL BE IN CONFORMANCE WITH THE REQUIREMENTS OF THE ROOF WARRANTY.

2. **DEMOLITION**

2.1 ALL EXISTING EQUIPMENT, OTHER THAN DUCTWORK, WIRING AND AIR DEVICES, REMOVED BY THE CONTRACTOR SHALL BECOME THE PROPERTY OF THE OWNER AND SHALL BE REMOVED, STORED, OR DISPOSED OF BY THE CONTRACTOR AT THE DIRECTION OF THE OWNER.

2.2 ALL OPENINGS IN WALLS, CEILINGS AND FLOORS RESULTING FROM DUCT DEMOLITION SHALL BE CLOSED AND FINISHED TO MATCH THE SURROUNDING AREA BY THE GENERAL CONTRACTOR. THE MECHANICAL CONTRACTOR SHALL BE RESPONSIBLE FOR COORDINATING LOCATIONS.

2.3 BLANK-OFF ALL UNUSED DUCT OPENINGS WITH SAME GAUGE METAL AS EXISTING DUCT AND SEAL AIR TIGHT. INSULATED DUCTS SHALL BE INSULATED WITH SAME INSULATION MATERIAL AND THICKNESS AS EXISTING AND SEALED VAPOR TIGHT.

3. SHOP DRAWINGS

3.A CONTRACTOR SHALL SUBMIT SHOP DRAWINGS FOR THE FOLLOWING MATERIALS AND EQUIPMENT:

- 3.A.1 ALL HEATING AND COOLING EQUIPMENT
- 3.A.2 VIBRATION ISOLATORS
- 3.A.3 FANS 3.A.4 AIR DEVICES
- 3.A.5 TEMPERATURE CONTROLS
- 3.A.6 TESTING AND BALANCING REPORTS 3.A.7 OPERATION AND MAINTENANCE MANUALS

3.B MECHANICAL CONTRACTOR SHALL BE RESPONSIBLE FOR COORDINATION OF MECHANICAL EQUIPMENT REQUIREMENTS WITH THE GENERAL CONTRACTOR. ITEMS TO BE COORDINATED SHALL INCLUDE BUT NOT BE LIMITED TO: UTILITY REQUIREMENTS (ELECTRIC, GAS, ETC), SIZE AND WEIGHT MODIFICATIONS REQUIRED DUE TO CONTRACTOR ORIGINATED DEVIATIONS FROM THE "BASIS OF DESIGN" OR "PROTOTYPE" DATA SHALL BE INCORPORATED AT NO ADDITIONAL COST TO THE OWNER.

MECHANICAL ABBREVIATIONS ABBR. REMARKS BHP BREAK HORSE POWER CFM CUBIC FEET PER MINUTE EF EXHAUST FAN EFF **EFFICIENCY** HP HORSE POWER IN INCH MAX MAXIMUM MIN MINIMUM RPM REVOLUTIONS PER MINUTE **TSP** TOTAL STATIC PRESSURE WATT

4. **EQUIPMENT**

4.A GENERAL:

4.A.1 REFER TO EQUIPMENT SCHEDULES FOR ADDITIONAL REQUIREMENTS 4.A.2 ALL EQUIPMENT SHALL BE IDENTIFIED BY STENCILING THE TITLE OF THE EQUIPMENT AS DETERMINED BY THE OWNER'S REPRESENTATIVE. IF THE OWNER'S REPRESENTATIVE DOES NOT EXPRESS A PREFERENCE THEN IDENTIFICATION SHALL BE TAKEN FROM THE PLANS AND SHALL BE LOCATED IN A POSITION THAT IS CLEARLY VISIBLE. THE LETTERS SHALL BE MADE WITH BLACK PAINT AND SHALL BE NOT LESS THAN 2" HIGH. THE TITLES SHALL BE SHORT AND CONCISE.

4.C AIR DEVICES:

4.C.1 STEEL CONSTRUCTION WITH ENAMEL FINISH (COLOR BY ARCHITECT). 4.C.2 ACCEPTABLE MANUFACTURERS: TITUS, KRUEGER, TUTTLE & BAILEY, METALAIRE, ANEMOSTAT OR CARNES.

4.E.1 EACH FAN SHALL BE AMCA CERTIFIED AND LABELED.

4.E.4 ACCEPTABLE MANUFACTURERS: COOK, GREENHECK OR PENN.

4.E.2 EACH FAN SHALL BE UL LISTED AND LABELED. 4.E.3 ALL WIRING AND CONDUIT PROVIDED AS PART OF THE UNIT SHALL BE IN ACCORDANCE

5. VIBRATION ISOLATORS

5.A PROVIDE COMBINATION SPRING AND DOUBLE DEFLECTION NEOPRENE ISOLATION HANGERS FOR ALL SUSPENDED FANS AND EQUIPMENT 100 LBS. OR GREATER.

5.B PROVIDE DOUBLE DEFLECTION NEOPRENE ISOLATION HANGERS FOR SUSPENDED FANS AND EQUIPMENT LESS THAN 100 LBS.

5.C QUANTITY AND LOCATION OF ISOLATORS SHALL BE AS RECOMMENDED BY THE EQUIPMENT MANUFACTURER.

5.D AFTER INSTALLATION AND START-UP. CONTRACTOR SHALL THOROUGHLY CHECK EACH ITEM OF EQUIPMENT FOR VIBRATION TRANSMISSION TO THE STRUCTURE OR EXCESSIVE NOISE, AND IF EITHER OCCURS, THE CONTRACTOR SHALL BE RESPONSIBLE FOR CORRECTING THE FAULTY SITUATION IMMEDIATELY.

6. **DUCTWORK**

6.A GENERAL: CONSTRUCT ALL DUCTWORK AND ACCESSORIES IN ACCORDANCE WITH THE LATEST EDITION OF SMACNA STANDARDS FOR 2" PRESSURE CLASS AND SEAL CLASS B.

6.B METAL DUCTWORK: UNLESS OTHERWISE NOTED, FABRICATE ALL DUCTWORK, HOUSING, DAMPERS, AND ALL OTHER DUCT RELATED ACCESSORIES FROM ALUMINUM CONSTRUCTION

6.B.1 GALVANIZED STEEL SHEETS: LOCK-FORMING QUALITY; COMPLYING WITH ASTM A 653/A 653M; DUCTS SHALL HAVE MILL-PHOSPHATIZED FINISH FOR SURFACES EXPOSED TO VIEW.

6.C INSTALL ALL DUCTWORK ABOVE CEILING AND HOLD TIGHT TO UNDERSIDE OF STRUCTURE ABOVE UNLESS OTHERWISE INDICATED.

6.D INSTALL OUTSIDE AIR INTAKES A MINIMUM OF 10'-0" FROM ANY EXHAUST OR PLUMBING VENT.

6.E CHANGES TO DUCT DUE TO FIELD CONDITIONS SHALL BE MADE ONLY IF THE DUCT SIZE FREE AREA IS MAINTAINED AND SHALL BE SUBMITTED TO ENGINEER FOR APPROVAL.

6.F LEAKAGE 6.F.1 ALL DUCT JOINTS SHALL BE SEALED WITH HARDCAST 601.

6.F.2 LEAKAGE TESTING FOR ALL DUCTWORK SHALL BE BY PHYSICAL SENSATION AND SHALL BE PERFORMED IN THE PRESENCE OF THE OWNER'S REPRESENTATIVE.

6.F.3PERFORM ALL TESTING AFTER THE SEALS HAVE CURED COMPLETELY AND BEFORE

COVERING WITH INSULATION OR CONCEALING IN MASONRY.

7. TEST AND BALANCING

7.A SCOPE:

7.A.1 AN INDEPENDENT CONTRACTOR WITH NEBB OR AABC CERTIFICATION SHALL PROVIDE ALL LABOR, MATERIALS, EQUIPMENT, SERVICES AND PERFORM ALL OPERATIONS REQUIRED FOR COMPLETE BALANCING OF THE MECHANICAL SYSTEMS AND RELATED WORK AS INDICATED ON THE DRAWINGS AND SPECIFIED HEREIN.

7.A.2 BALANCING SHALL NOT BE PERFORMED UNTIL ALL MECHANICAL EQUIPMENT IS PROPERLY INSTALLED AND IS 100% OPERATIONAL, ALL TEMPERATURE CONTROLS ARE INSTALLED AND CALIBRATED AND ALL SYSTEMS ARE CLEANED, PIPING AND STRAINERS FLUSHED, AND CLEAN

7.A.3 IT IS THE INTENT OF THIS SPECIFICATION TO ENSURE THAT THE ENTIRE PROJECT IS SUBSTANTIALLY COMPLETE SO THAT ALL COMPONENTS OF ALL MECHANICAL SYSTEMS CAN BE PUT INTO NORMAL OPERATION WITH ALL WINDOWS AND DOORS CLOSED AND BALANCED IN THAT CONDITION, IN NO CASE IS THE CONTRACTOR TO PERFORM HIS WORK IN PIECEMEAL

7.A.4 QUALITY ASSURANCE: SUBMIT TO OWNER THREE (3) COPIES OF BALANCING AND TESTING RECORDS SPECIFIED HEREIN SHOWING THE MECHANICAL SYSTEMS HAVE BEEN BALANCED AND ARE DELIVERING SPECIFIED QUANTITIES.

7.A.5 EACH PIECE OF EQUIPMENT SHALL BE IDENTIFIED AS TO LOCATION, SERVICE, MANUFACTURER AND MODEL NUMBER. THIS INFORMATION SHALL BE RECORDED AND INCLUDED IN THE FINAL BALANCE REPORT.

7.B AFTER ADJUSTMENTS ARE COMPLETED, THE MECHANICAL SYSTEMS SHALL BE TESTED, AND THE FOLLOWING INFORMATION RECORDED AND INCLUDED IN THE FINAL BALANCE REPORT:

7.B.1 AIR DEVICES: EACH AIR DEVICE SHALL BE IDENTIFIED AS TO LOCATION AND SERVICE SIZE, TYPE AND MANUFACTURER OF AIR DEVICE LISTED

REQUIRED CFM AND TEST RESULTANT CFM EACH DEVICE

TOTAL AIR FLOW EXTERNAL STATIC PRESSURE MOTOR FULL LOAD AMPS

7.C AFTER THE SYSTEMS HAVE BEEN BALANCED AND ALL ADJUSTMENTS COMPLETED, RUN A SIX HOUR TEST ON BOTH HEATING AND COOLING CYCLE TO DETERMINE IF SYSTEM IS RESPONDING TO TEMPERATURE CONTROLS. THERMOSTAT TEMPERATURE READING, AND AN INDEPENDENT TEMPERATURE MEASUREMENT AT THE THERMOSTAT SHALL BE RECORDED AT EACH

8. **TEMPERATURE CONTROL**

8.A CONTRACTOR SHALL BE RESPONSIBLE FOR INTERFACING THE NEW ATC WORK WITH THE EXISTING TEMPERATURE CONTROLS.

8.B POWER FOR MOTORIZED ACTUATORS AND CONTROLS SHALL BE THE RESPONSIBILITY OF THE CONTROLS CONTRACTOR. ALL WIRING ABOVE 24 VOLTS SHALL BE INSTALLED IN ACCORDANCE WITH THE ELECTRICAL SPECIFICATIONS AND THE NATIONAL ELECTRIC CODE.

8.C THERMOSTATS SHALL BE COMPATIBLE WITH EXISTING ATC SYSTEM.

8.D THERMOSTAT LOCATIONS SHOWN ARE APPROXIMATE AND SHALL BE COORDINATED WITH ARCHITECTURAL DRAWINGS. MOUNT THERMOSTATS 4'-0" ABOVE FINISHED FLOOR, UNLESS

8.E MOUNT ALL THERMOSTATS ON EXTERIOR WALLS ON AN INSULATED SUB-BASE.

8.F PROVIDE INITIAL SETUP AND PROGRAMMING OF ALL CONTROLS AND DEMONSTRATE TO

8.G CONTRACTOR SHALL TAKE EXTRA CARE WHEN REMOVING/RELOCATING THE EXISTING EQUIPMENT SO THAT EXISTING CONTROL COMPONENTS ARE NOT DAMAGED. RECONNECT ALL THERMOSTATS TO THE ASSOCIATED EQUIPMENT AS REQUIRED.



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1	REVISION # 1	06/30/2016			
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COVER SHEET - MECHANICAL

CONCEPT 35% 60% 80% 100%

A/E Project Number Drawing Scale: AS NOTED 12-0009.012 CADD Filename 06.30.2016




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Revit Model

CADD Plot Scale


M001



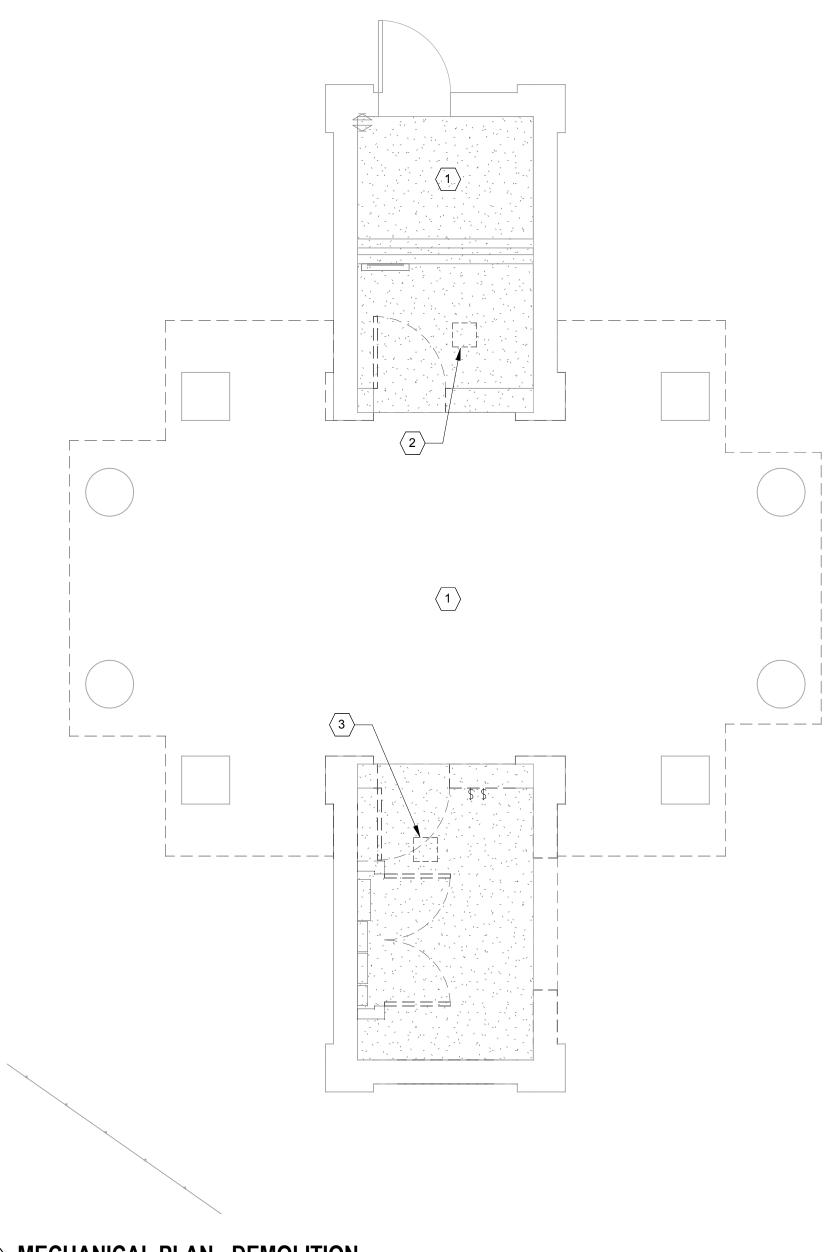

DEMOLITION KEY NOTES: (#)

- 1. NO MECHANICAL DEMOLITION WORK IN THIS AREA.
- 2. REMOVE EXHAUST FAN. EXISTING EXHAUST DUCTWORK, ELECTRICAL CONNECTIONS, AND CONTROLS SHALL BE REUSED WITH NEW INSTALLATION.
- 3. REMOVE FAN, ASSOCIATED DUCTWORK, ELECTRICAL CONNECTIONS, AND CONTROLS.

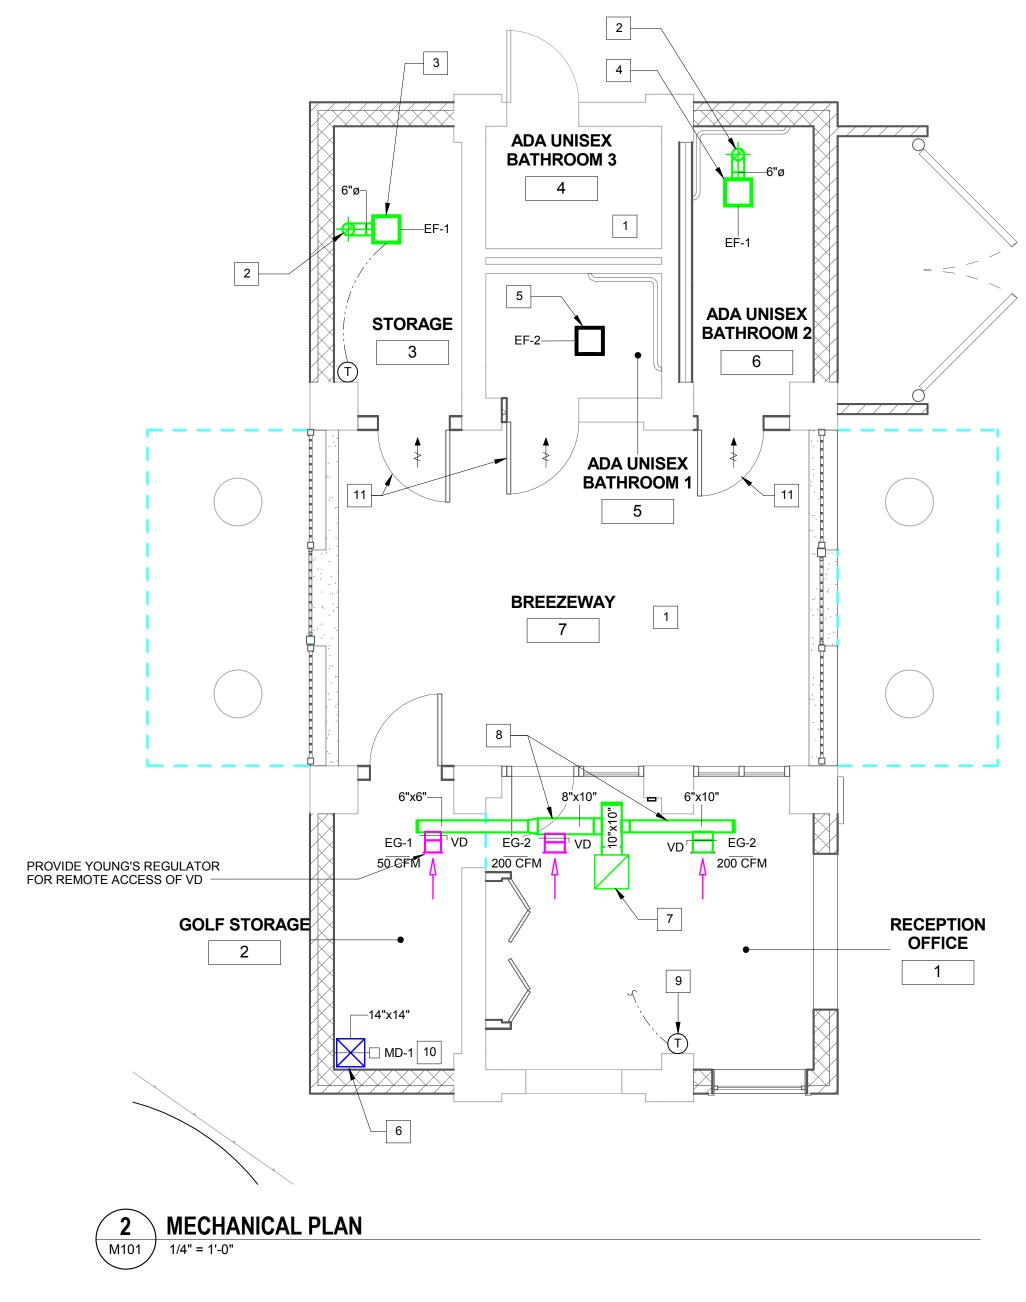

NEW WORK KEY NOTES:

- 1. NO NEW MECHANICAL WORK IN THIS AREA.
- 2. 6" EXHAUST DUCT UP THROUGH ROOF. TERMINATE PER GOOSENECK DETAIL ON SHEET M501.
- 3. EXHAUST FAN TO BE CONTROLLED WITH A WALL MOUNTED THERMOSTAT. SET FAN TO OPERATE AT 80 °F (ADJ).
- 4. EXHAUST FAN TO BE CONTROLLED WITH A LIGHT SWITCH. SEE ELECTRICAL DWGS FOR ADDITIONAL INFORMATION.
- 6. 14" X 14" MAKE-UP AIR DUCT. TERMINATE DUCT UP THROUGH ROOF PER GOOSENECK DETAIL ON SHEET M501. INSIDE THE SPACE, TERMINATE DUCT 12" OF FLOOR WITH WIRE SCREEN AT OPEN END.
- 7. EXHAUST DUCT UP TO EF-3 ON ROOF. DUCT SIZE SHALL MATCH FULL FAN OPENING. SEE ROOF MOUNTED EXHAUST FAN DETAIL FOR ADDITIONAL INFORMATION.

5. EXHAUST FAN TO BE CONNECTED WITH EXISTING EXHAUST DUCTWORK. REUSE EXISTING ELECTRICAL CONNECTIONS AND CONTROLS.

- 8. INSTALL EXHAUST DUCTWORK AND ASSOCIATED AIR DEVICES ABOVE DECORATIVE-OPEN CEILING.
- 9. WALL MOUNTED THERMOSTAT TO CONTROL EF-3. SET FAN TO OPERATE AT 75 °F (ADJ).
- 10. INSTALL MOTORIZED DAMPER MD-1 INSIDE THE SPACE, WITHIN 6" OF ROOF PENETRATION. INTERLOCK MD-1 OPERATION WITH EF-3 TO OPEN WHEN FAN IS RUNNING AND TO CLOSE WHEN FAN STOPS.
- 11. PROVIDE 1" DOOR UNDERCUT.



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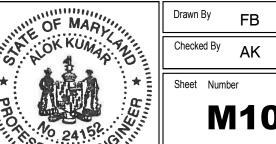
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MECHANICAL FLOOR PLANS

☐ CONCEPT ☐ 35% ☐ 60% ☐ 80% **☐** 100%

M101

A/E Project Number Drawing Scale: AS NOTED 12-0009.012 CADD Filename CADD Plot Scale 06.30.2016 Revit Model








	EXHAUST FAN SCHEDULE												
				FAN DATA		ELECTRIC DATA							
MARK	TYPE	AIRFLOW (CFM)	ESP (IN. WG.)	DRIVE	FAN RPM	RPM	HP (AMPS)	VOLT	PHASE	Hz	WEIGHT (LBS)	BASIS OF DESIGN: GREENHECK	NOTES
EF-1	CEILING	90	0.25	DIRECT	950	950	(1.14)	115	1	60	10	SP-B110	1,2,3
EF-2	CEILING	60	0.25	DIRECT	900	900	(0.16)	115	1	60	9	SP-B80	2,3
EF-3	ROOF MOUNT / CENTRIF	450	0.35	DIRECT	1631	1725	1/10	115	1	60	33	G-085-VG	1,2,4

- DISCONNECT SWITCH.
 BACKDRAFT DAMPER.
 ALUMINUM GRILLE
- 4. PROVIDE WITH 14" ROOF CURB TO BE INSTALLED ON PITCHED ROOF. COORDINATE ROOF CURB REQUIREMENTS WITH MANUFACTURER.


	AIR DEVICE SCHEDULE									
MARK	ТҮРЕ	SERVICE	AIRFLOW (CFM)	FRAME SIZE (IN X IN)	NECK SIZE (IN X IN))	MAX NC	BASIS OF DESIGN: TITUS	NOTES		
EG-1	LOUVERED FACE	EXHAUST	0-100	10 X 8	8 X 6	15	350	1,2,3,4		
EG-2	LOUVERED FACE	EXHAUST	0-300	12 X 12	10 X 10	15	350	1,2,3,4		

NOTES:

- PROVIDE FRAME AND/OR ACCESSORIES AS REQUIRED TO MATCH SURFACE TYPE. SEE ARCHITECTURAL DWGS FOR ADDITIONAL INFORMATION.
 BALANCE TO CFM INDICATED ON PLANS.
 PROVIDE WITH VOLUME DAMPER AT AIRTITE FITTING.
- 4. UNLESS OTHERWISE INDICATED, RUNOUT DUCTS SHALL MATCH AIR DEVICE NECK.

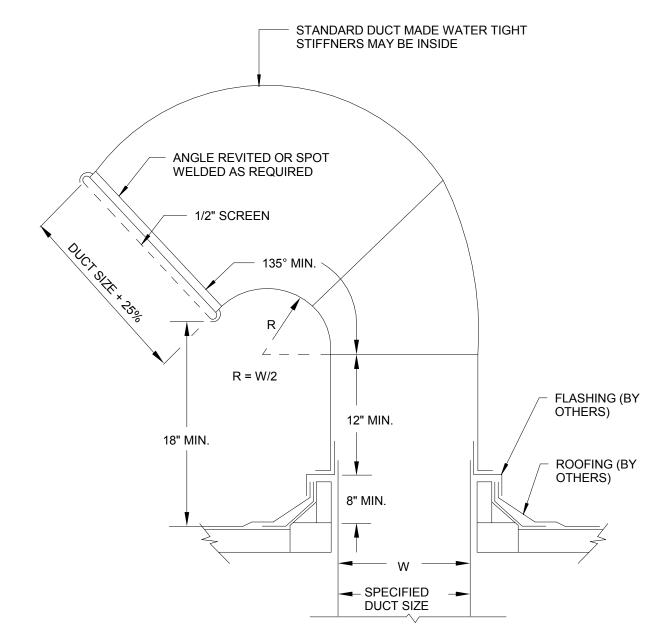



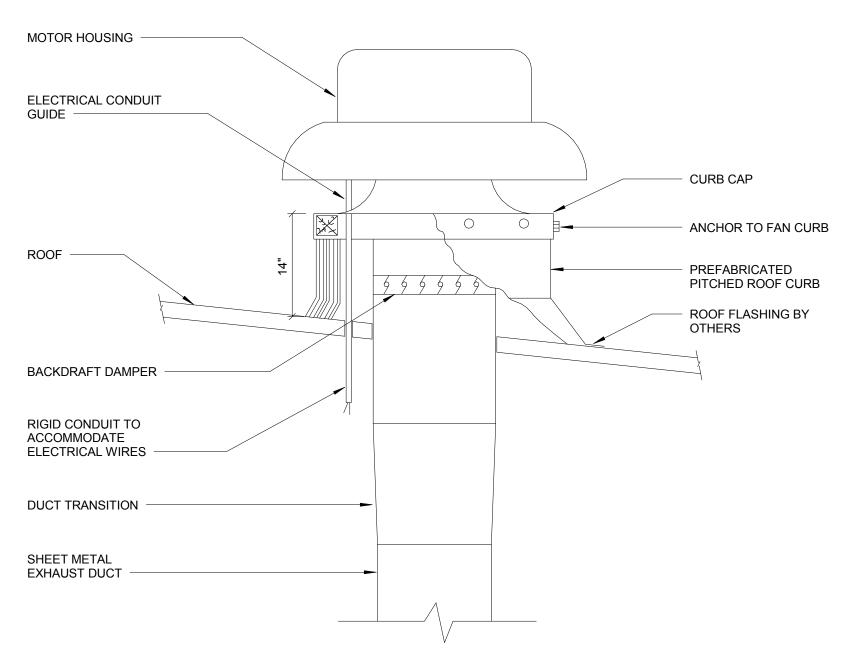





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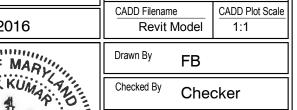
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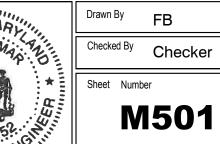
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MECHANICAL SCHEDULES AND DETAILS

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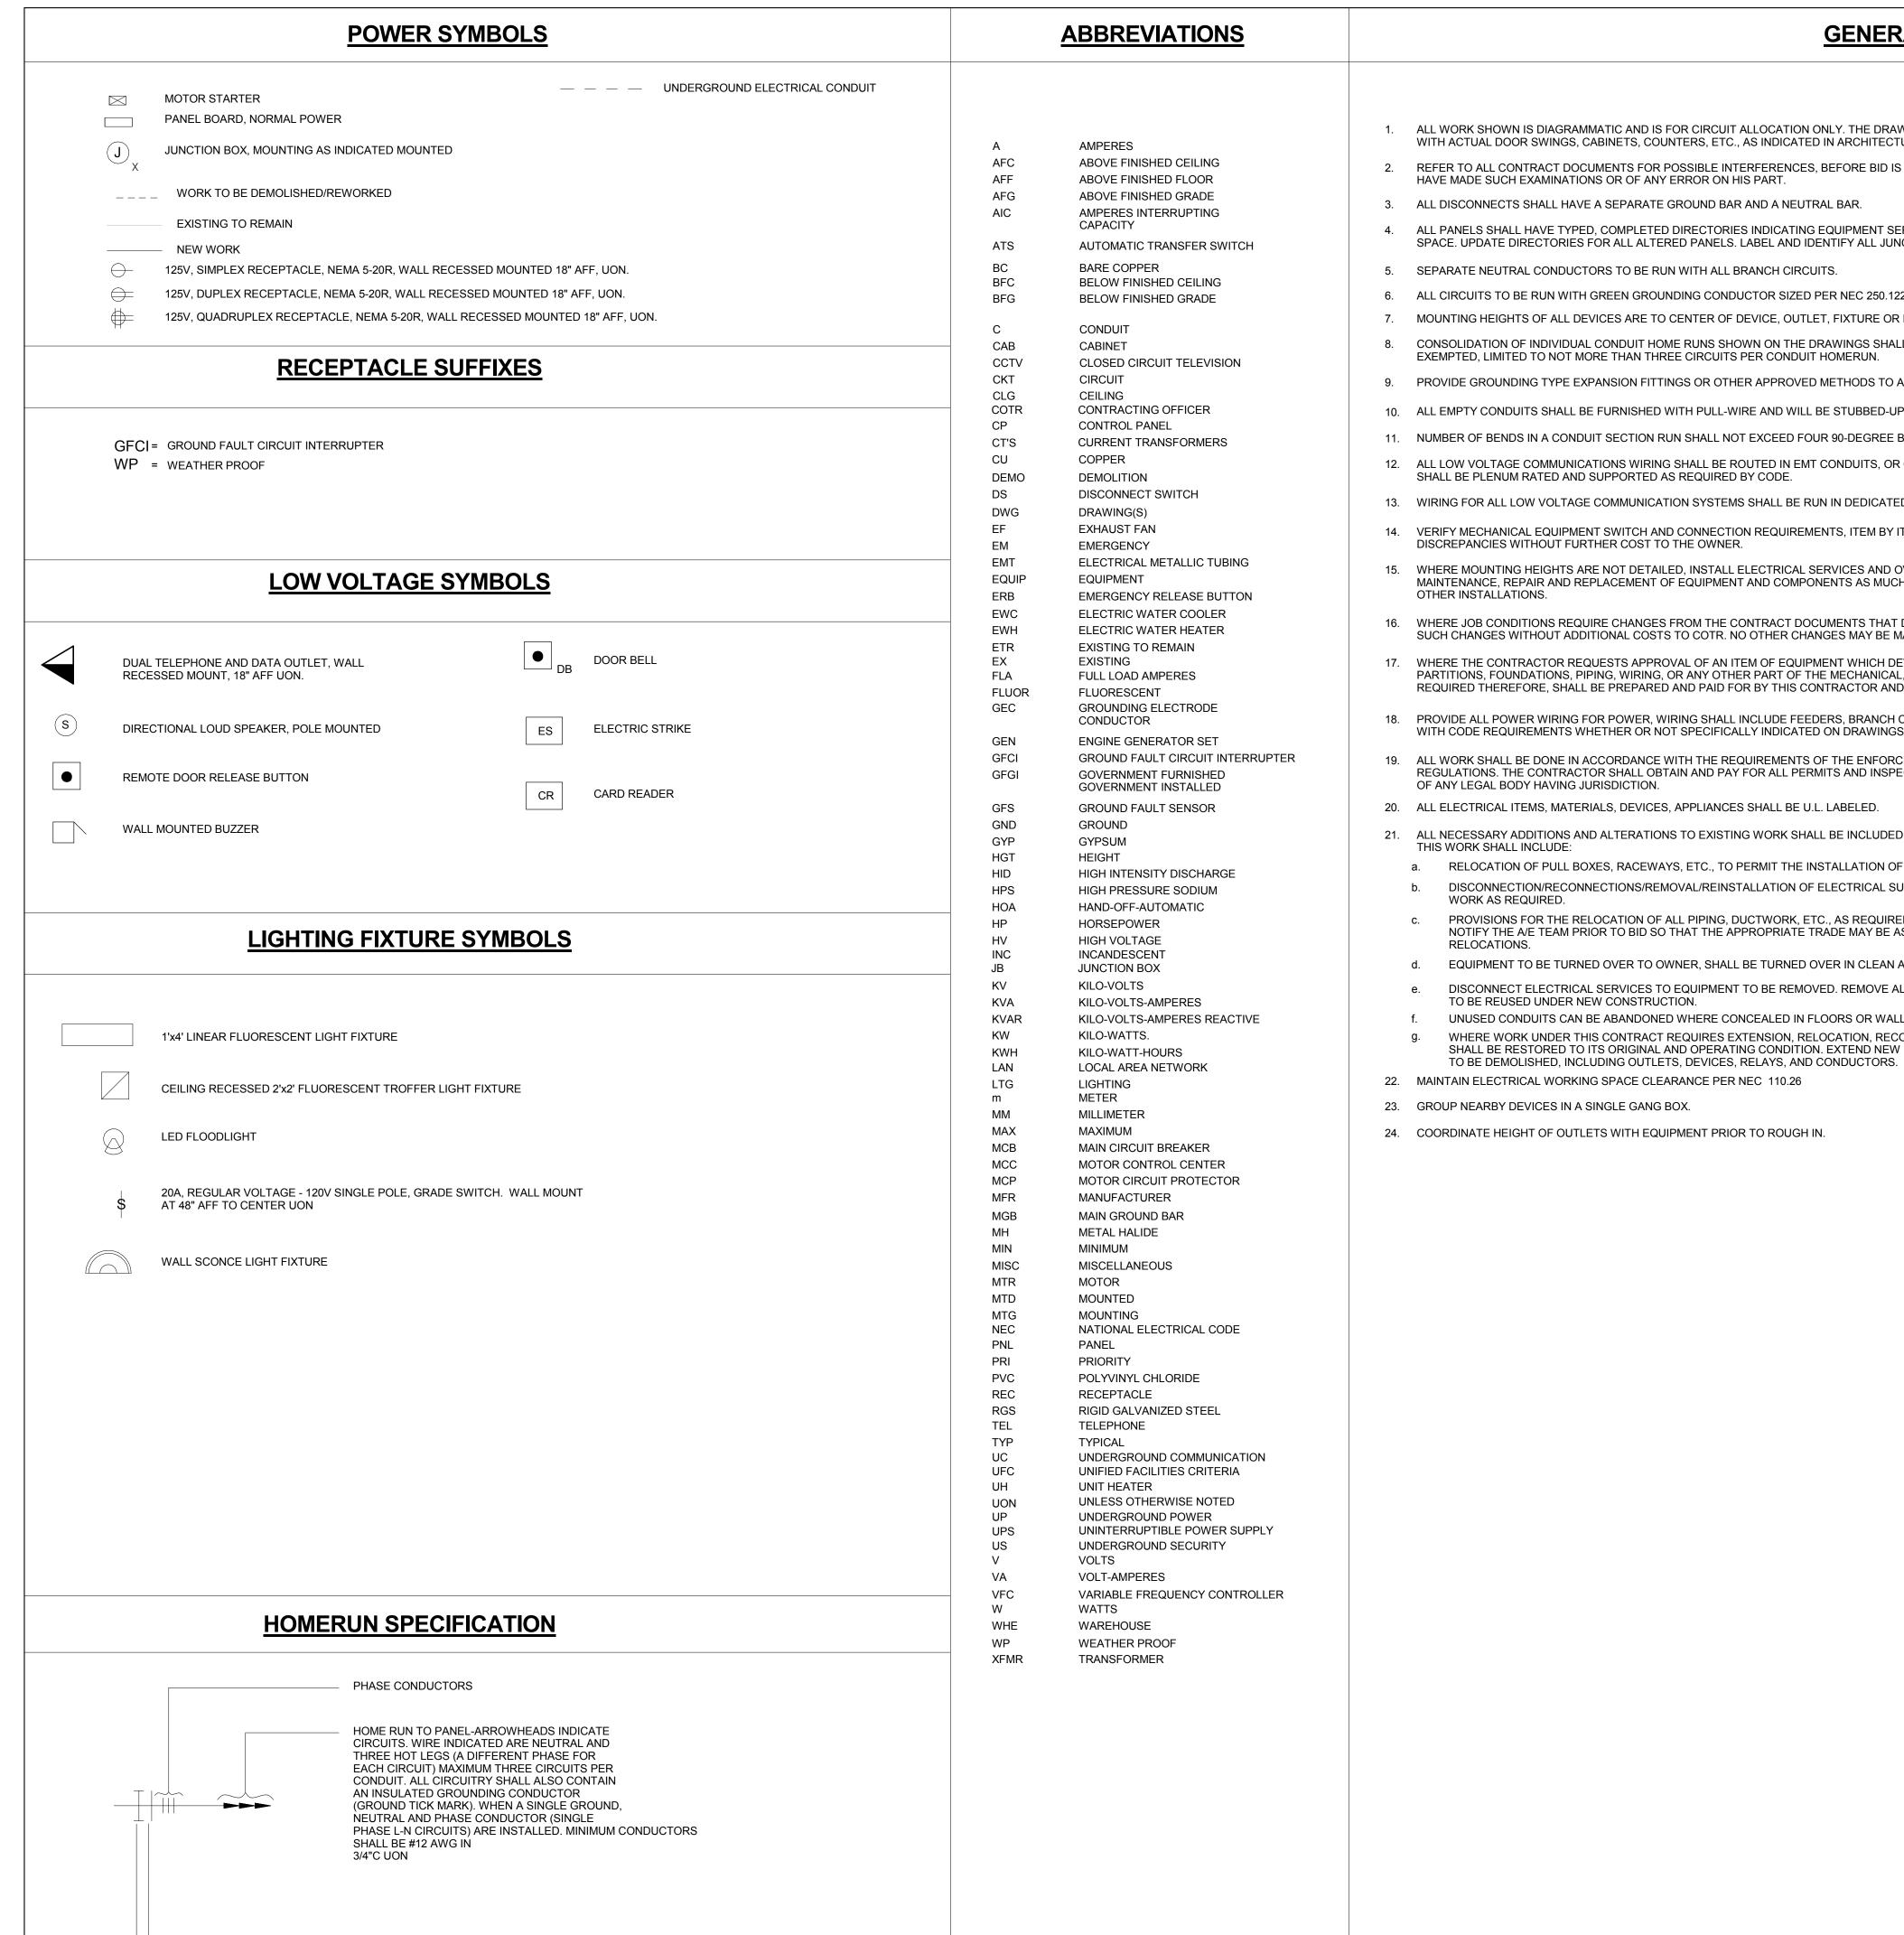
A/E Project Number 12-0009.012 06.30.2016





Drawing Scale: AS NOTED






NEUTRAL

GROUNDING

GENERAL NOTES

- ALL WORK SHOWN IS DIAGRAMMATIC AND IS FOR CIRCUIT ALLOCATION ONLY. THE DRAWINGS INDICATE THE GENERAL ARRANGEMENT OF ELECTRICAL EQUIPMENT. COORDINATE ALL DEVICE LOCATIONS WITH ACTUAL DOOR SWINGS, CABINETS, COUNTERS, ETC., AS INDICATED IN ARCHITECTURAL DRAWINGS.
- REFER TO ALL CONTRACT DOCUMENTS FOR POSSIBLE INTERFERENCES, BEFORE BID IS MADE. NO ALLOWANCE SHALL SUBSEQUENTLY BE MADE TO THE CONTRACTOR BY REASON OF HIS FAILURE TO HAVE MADE SUCH EXAMINATIONS OR OF ANY ERROR ON HIS PART.
- 3. ALL DISCONNECTS SHALL HAVE A SEPARATE GROUND BAR AND A NEUTRAL BAR.
- ALL PANELS SHALL HAVE TYPED, COMPLETED DIRECTORIES INDICATING EQUIPMENT SERVED AND ROOM NUMBER (AS INDICATED ON FINAL BUILDING SIGNAGE) OF EQUIPMENT LOCATION, SPARE, OR SPACE. UPDATE DIRECTORIES FOR ALL ALTERED PANELS. LABEL AND IDENTIFY ALL JUNCTION BOXES WITH PANEL AND CIRCUIT NUMBER
- SEPARATE NEUTRAL CONDUCTORS TO BE RUN WITH ALL BRANCH CIRCUITS.
- ALL CIRCUITS TO BE RUN WITH GREEN GROUNDING CONDUCTOR SIZED PER NEC 250.122.
- MOUNTING HEIGHTS OF ALL DEVICES ARE TO CENTER OF DEVICE, OUTLET, FIXTURE OR EQUIPMENT UNLESS OTHERWISE NOTED.
- CONSOLIDATION OF INDIVIDUAL CONDUIT HOME RUNS SHOWN ON THE DRAWINGS SHALL NOT BE PERMITTED WITHOUT PRIOR WRITTEN APPROVAL. LIGHTING AND RECEPTACLE CIRCUITS ONLY MAY BE EXEMPTED, LIMITED TO NOT MORE THAN THREE CIRCUITS PER CONDUIT HOMERUN.
- PROVIDE GROUNDING TYPE EXPANSION FITTINGS OR OTHER APPROVED METHODS TO ALLOW FOR EXPANSION, CONTRACTIONS AND DEFLECTION WHERE CONDUITS CROSS EXPANSION JOINTS.
- 10. ALL EMPTY CONDUITS SHALL BE FURNISHED WITH PULL-WIRE AND WILL BE STUBBED-UP A.F.F., OR ABOVE SUSPENDED CEILING AS THE CASE MAY BE, AND SHALL BE CAPPED AT BOTH ENDS.
- 11. NUMBER OF BENDS IN A CONDUIT SECTION RUN SHALL NOT EXCEED FOUR 90-DEGREE BENDS, OR EQUIVALENT OF SWEEPS AND RADIUS BENDS.
- 12. ALL LOW VOLTAGE COMMUNICATIONS WIRING SHALL BE ROUTED IN EMT CONDUITS, OR OTHER APPROVED CONDUITS, EXCEPT WHERE RUN IS CONCEALED IN ACCESSIBLE AREAS. ALL EXPOSED WIRING SHALL BE PLENUM RATED AND SUPPORTED AS REQUIRED BY CODE.
- 13. WIRING FOR ALL LOW VOLTAGE COMMUNICATION SYSTEMS SHALL BE RUN IN DEDICATED RACEWAYS AND NOT SHARED WITH POWER WIRING OR OTHER SYSTEMS.
- 14. VERIFY MECHANICAL EQUIPMENT SWITCH AND CONNECTION REQUIREMENTS, ITEM BY ITEM WITH THE MECHANICAL CONTRACTOR PRIOR TO ROUGH-IN AND WIRING OF EQUIPMENT. RESOLVE ALL DISCREPANCIES WITHOUT FURTHER COST TO THE OWNER.
- 15. WHERE MOUNTING HEIGHTS ARE NOT DETAILED, INSTALL ELECTRICAL SERVICES AND OVERHEAD EQUIPMENT TO PROVIDE MAXIMUM HEADROOM POSSIBLE. INSTALL ELECTRICAL EQUIPMENT TO FACILITATE MAINTENANCE, REPAIR AND REPLACEMENT OF EQUIPMENT AND COMPONENTS AS MUCH AS PRACTICAL. CONNECT THE EQUIPMENT FOR EASE OF DISCONNECTING WITH MINIMUM OF INTERFERENCE WITH
- 16. WHERE JOB CONDITIONS REQUIRE CHANGES FROM THE CONTRACT DOCUMENTS THAT DO NOT CHANGE THE SCOPE OF INSTALLATION OR NATURE OF WORK REQUIRED, THE CONTRACTOR SHALL MAKE SUCH CHANGES WITHOUT ADDITIONAL COSTS TO COTR. NO OTHER CHANGES MAY BE MADE WITHOUT WRITTEN PERMISSION OF THE COTR.
- 17. WHERE THE CONTRACTOR REQUESTS APPROVAL OF AN ITEM OF EQUIPMENT WHICH DEVIATES FROM THE REQUIREMENTS OF THE DRAWINGS AND WILL REQUIRE A REDESIGN OF STRUCTURE, PARTITIONS, FOUNDATIONS, PIPING, WIRING, OR ANY OTHER PART OF THE MECHANICAL, ELECTRICAL, OR ARCHITECTURAL LAYOUT, ALL SUCH REDESIGN, AND ALL NEW DRAWINGS AND DETAILING REQUIRED THEREFORE, SHALL BE PREPARED AND PAID FOR BY THIS CONTRACTOR AND SUBMITTED TO THE ARCHITECT FOR APPROVAL
- PROVIDE ALL POWER WIRING FOR POWER, WIRING SHALL INCLUDE FEEDERS, BRANCH CIRCUITS, DISCONNECT SWITCHES, EQUIPMENT TERMINALS. DISCONNECTS SHALL BE PROVIDED IN ACCORDANCE WITH CODE REQUIREMENTS WHETHER OR NOT SPECIFICALLY INDICATED ON DRAWINGS.
- 19. ALL WORK SHALL BE DONE IN ACCORDANCE WITH THE REQUIREMENTS OF THE ENFORCED EDITION OF THE NATIONAL ELECTRICAL CODE, N.F.P.A. 70, AND ALL LOCAL AND STATE CODES AND REGULATIONS. THE CONTRACTOR SHALL OBTAIN AND PAY FOR ALL PERMITS AND INSPECTIONS REQUIRED BY THE BUILDING AND SAFETY CODES AND ORDINANCES, AND THE RULES AND REGULATIONS OF ANY LEGAL BODY HAVING JURISDICTION.
- 20. ALL ELECTRICAL ITEMS, MATERIALS, DEVICES, APPLIANCES SHALL BE U.L. LABELED.
- 21. ALL NECESSARY ADDITIONS AND ALTERATIONS TO EXISTING WORK SHALL BE INCLUDED IN THE CONTRACT AS REQUIRED TO PROVIDE AND MAINTAIN A COMPLETE AND PROPER ELECTRICAL INSTALLATION.
- RELOCATION OF PULL BOXES, RACEWAYS, ETC., TO PERMIT THE INSTALLATION OF NEW EQUIPMENT.
- DISCONNECTION/RECONNECTIONS/REMOVAL/REINSTALLATION OF ELECTRICAL SUPPLY, CONTROL, AND UTILIZATION EQUIPMENT REQUIRED FOR CONTINUED OPERATION, INCLUDING TEMPORARY
- PROVISIONS FOR THE RELOCATION OF ALL PIPING, DUCTWORK, ETC., AS REQUIRED FOR ELECTRICAL WORK, WHERE NOT SHOWN OR SPECIFIED BY OTHERS. THE ELECTRICAL CONTRACTOR SHALL NOTIFY THE A/E TEAM PRIOR TO BID SO THAT THE APPROPRIATE TRADE MAY BE ASSIGNED TO BID; OTHERWISE, THE ELECTRICAL CONTRACTOR SHALL BE HELD RESPONSIBLE FOR ALL SUCH
- EQUIPMENT TO BE TURNED OVER TO OWNER, SHALL BE TURNED OVER IN CLEAN AND WORKING CONDITION.
- DISCONNECT ELECTRICAL SERVICES TO EQUIPMENT TO BE REMOVED. REMOVE ALL UNUSED CONDUIT AND CONDUCTORS BACK TO POINT OF SERVICE, OR NEXT ACTIVE DEVICE, UNLESS THEY ARE TO BE REUSED UNDER NEW CONSTRUCTION.
- UNUSED CONDUITS CAN BE ABANDONED WHERE CONCEALED IN FLOORS OR WALLS, BUT MUST BE REMOVED FROM CEILING SPACES, EXPOSED AREAS AND ACCESSIBLE LOCATIONS.
- WHERE WORK UNDER THIS CONTRACT REQUIRES EXTENSION, RELOCATION, RECONNECTIONS OR MODIFICATIONS TO EXISTING EQUIPMENT OR SYSTEMS, THE EXISTING EQUIPMENT OR SYSTEM SHALL BE RESTORED TO ITS ORIGINAL AND OPERATING CONDITION. EXTEND NEW HOMERUNS OR CIRCUIT EXTENSIONS, WHERE REQUIRED. DISCONNECT AND REMOVE ALL EQUIPMENT INDICATED
- 22. MAINTAIN ELECTRICAL WORKING SPACE CLEARANCE PER NEC 110.26
- 23. GROUP NEARBY DEVICES IN A SINGLE GANG BOX.
- 24. COORDINATE HEIGHT OF OUTLETS WITH EQUIPMENT PRIOR TO ROUGH IN.

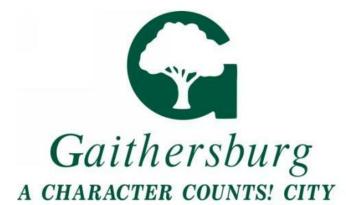

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No.	Description	Date
1	REVISION # 1	06/30/2016
2	REVISION # 2	07/12/2016
3	REVISION #3	07/19/2016

Drawing Title

ELECTRICAL SYMBOLS AND ABBREVIATIONS

CONCEPT 35% 60% 80% 100%

A/E Project Number Drawing Scale: AS NOTED 12-0009.012 CADD Filename CADD Plot Scale 06.30.2016 Revit Model Drawn By JO

Checked By AM

Sheet Number

E001



1. REFER TO SHEET EP501 FOR CONDUIT RISER.

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KEY NOTES

- NEW (3) 2" UNDERGROUND IT CONDUIT SHALL TERMINATE IN NEW 16"x16" WEATHERPROOF JUNCTION BOX. EXTEND CONDUITS FROM JUNCTION BOX TO PENETRATE ACTIVITIES BUILDING WITH 90° ELBOW ROUTED 10' A.F.F TO NEW 16"x16" JUNCTION BOX. SEE SHEET E501 FOR DETAILS.
- PROVIDE 2 JUNCTION BOXES SIZE 10"x10" MOUNTED 12" A.F.F. TO SERVE DATA AND POWER. NO CONDUIT SHALL BE EXPOSED. REFER TO DETAIL 3 ON SHEET E501.
- NEW 2" CONDUIT FOR IT AND 1" CONDUIT FOR POWER TO BE RUN UNDERGROUND.
- NEW 120V WALL MOUNTED LED FLOODLIGHT FIXTURE. FIXTURE TO BE MOUNTED AT 12'. TILT FIXTURE AT A 35° ANGLE.
- NEW 120V WALL MOUNTED LED FLOODLIGHT FIXTURE. FIXTURE TO BE MOUNTED AT 15'. TILT FIXTURE AT A 35° ANGLE.
- CONNECT NEW SITE LIGHTING TO EXISTING LOBBY LIGHT CIRCUIT.
- MOUNT NEW 30W, 70V, BOGEN SPT30A OR EQUIVALENT HORN LOUDSPEAKER 20'-0" A.F.F. HORN LOUD SPEAKER DISPERSION IS 100 DEGREES WITH A COVERAGE OF APPROXIMATELY 6,000 SQ. FT. AND RADIUS DISTANCE OF APPROXIMATELY 80'-0" OF CLEAR
- NEW (3) 2" CONDUIT FOR IT TO BE RUN UNDERGROUND.
- PROVIDE NEW EXTERIOR POLE FOR SPEAKER. COLOR AND SIZE IS TO MATCH EXISTING. 11. EXISTING POLE FOR LIGHT FIXTURES AND
- 12. NEW 1" CONDUIT TO BE RUN UNDERGROUND FOR SPEAKER WIRING. ROUTE SPEAKER
- BOOTH FOR CONNECTION TO AMPLIFIER. 13. SPEAKER TO BE MOUNTED ON WALL. HEIGHT SHALL MATCH PREVIOUS SPEAKER HEIGHT. PROVIDE 1" CONDUIT FOR SPEAKER WIRING. ROUTE SPEAKER WIRING BACK TO JUNCTION BOX IN TICKET BOOTH FOR CONNECTION TO
- 14. COORDINATE THE ROUTING OF ELECTRICAL CONDUIT WITH EXISTING UNDERGROUND
- 15. NEW 120V POLE MOUNTED LED FLOODLIGHT FIXTURE. FIXTURE TO BE MOUNTED AT 15'. TILT FIXTURE AT A 35° ANGLE.
- 16. COORDINATE CONDUIT RUN WITH MECHANICAL AND PLUMBING PIPE, AND ALL FOOTINGS.
- 17. CONDUIT TO BE BURIED AT 30" MINIMUM.

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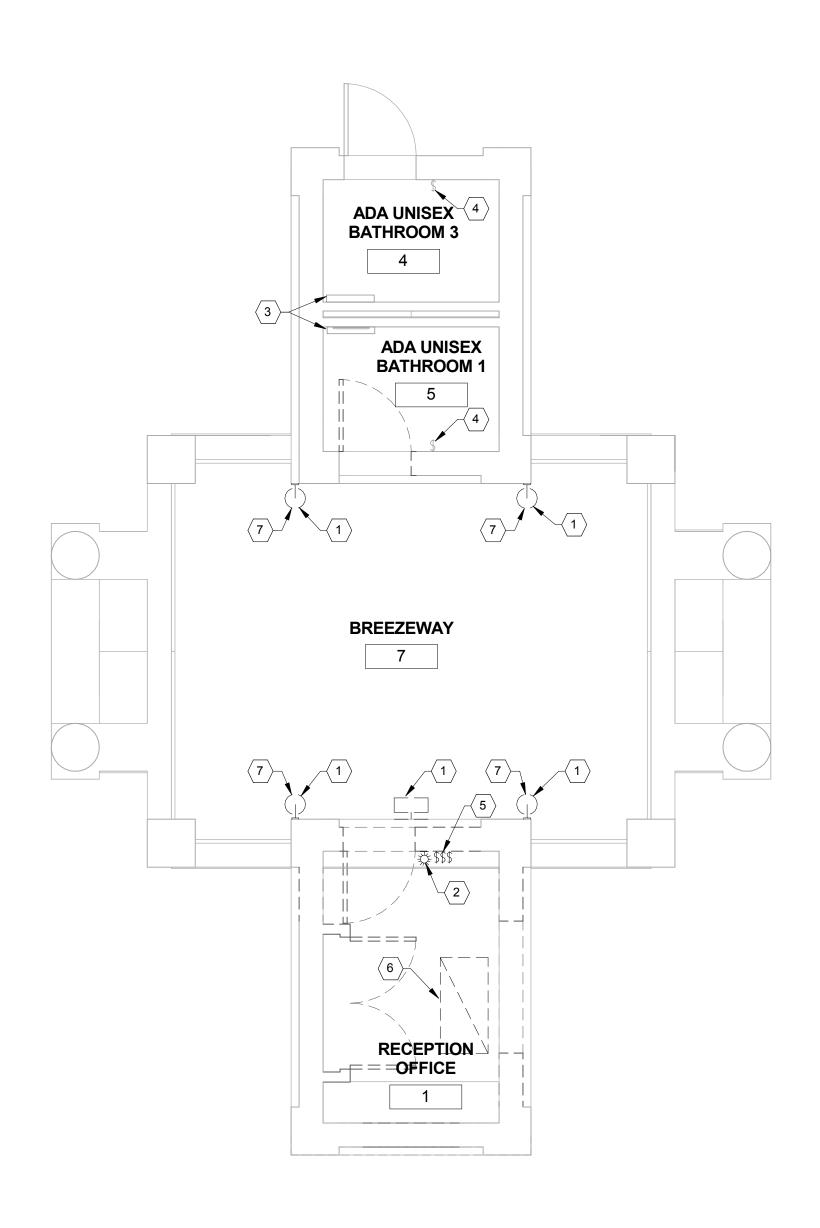
ELECTRICAL SITE PLAN

CONCEPT 35% 60% 80% 100%

A/E Project Number 12-0009.012	Drawing Scale: AS NC	TED
Date 06.30.2016	CADD Filename Revit Model	CADD Plot Sca 1:1
	Drawn By	

Checked By AM

Sheet Number **ES101**



1 ELECTRICAL LIGHTING PLAN - DEMOLITION

1/4" = 1'-0"

GENERAL NOTES

 REMOVE ALL WIRING, DEVICES, AND FIXTURES IN OFFICE COMPLETELY BACK TO SOURCE.

KEY NOTES (#)

- EXISTING WALL MOUNTED LIGHT FIXTURES ARE TO BE REMOVED.
- 2. EXISTING WALL MOUNTED FLOOD LIGHT IN RECEPTION OFFICE IS TO BE REMOVED.
- EXISITING 2' LINEAR LIGHT FIXTURE IN BATHROOM IS TO REMAIN.
- 4. EXISTING LIGHT SWITCH IS TO REMAIN.
- EXISTING LIGHT SWITCHES ARE TO BE DEMOLISHED.
- 6. EXISTING 2'x4' LIGHT FIXTURE IS TO BE REMOVED.
- 7. RETAIN WIRING FOR REUSE.



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Revision

Drawing T

ELECTRICAL LIGHTING PLAN -DEMOLITION

Phase


CONCEPT 35% 60% 80% 100%


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	A/E Project Number 12-0009.012	Drawing Scale: AS NO
	Date 06.30.2016	CADD Filename Revit Model
- 1		

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Sheet Number

EDL101



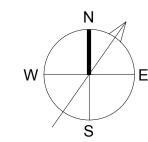

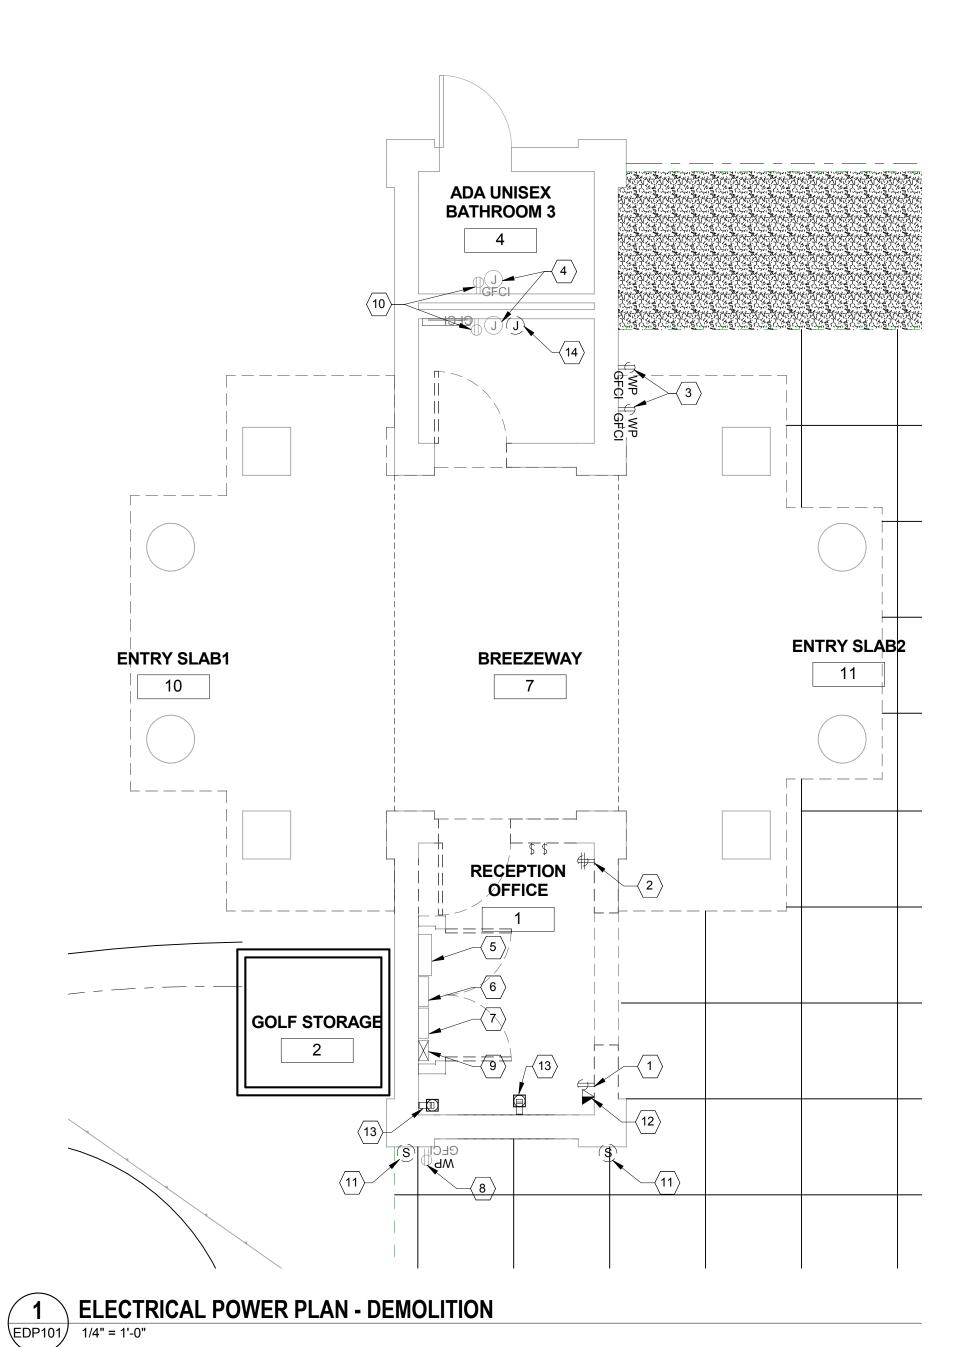 REMOVE ALL ELECTRICAL CONDUIT, WIRING, AND DEVICES FROM THE RECEPTION OFFICE.
 REMOVE LOUD SPEAKER SYSTEM BACK TO SOURCE.

3. REMOVE DATA SYSTEM BACK TO SOURCE.

4. REMOVE CCTV SYSTEM BACK TO SOURCE.

KEY NOTES (#)

- EXISTING DUPLEX RECEPTACLE IS TO BE REMOVED. EXISTING QUADRUPLEX RECEPTACLE IS TO BE REMOVED.
- 2. EXISTING QUADRUPLEX RECEPTACLE IS TO BE REMOVED.
- 3. EXISTING 120V WEATHERPROOF GFCI DUPLEX RECEPTACLES ARE TO BE REMOVED. RETAIN WIRING FROM ONE OF THE RECEPTACLES FOR REUSE.
- 4. EXISTING INSTANT WATER HEATERS ARE TO REMAIN.
- 5. EXISTING 120 / 208V, 100A, 3PH, PANEL G IS TO REMAIN.
- EXISTING 120/ 208V, 200A, 3PH PANEL "MIDDLE" IS TO REMAIN.
- 7. EXISTING 120 / 208V, 200A, 3PH PANEL "LEFT" IS TO REMAIN.
- 8. EXISTING 120V WEATHERPROOF GFCI RECEPTACLE IS TO REMAIN.9. EXISTING MOTOR STARTERS ARE TO
- 9. EXISTING MOTOR STARTERS ARE TO REMAIN.

 10. EXISTING 120V GFCI RECEPTACLES
- IN THE BATHROOMS ARE TO REMAIN.

 11. EXISTING WALL MOUNTED LOUD
- SPEAKERS ARE TO BE REMOVED.

 12. EXISTING WALL MOUNTED LOOD

 SPEAKERS ARE TO BE REMOVED.
- REMOVED.

 13. EXISTING SECURITY CAMERAS ARE
- TO BE REMOVED.

 14. EXISTING SECONTT CAMERAS AND
 TO BE REMOVED.
- 14. EXISTING HAND DRYER IS TO BE DEMOLISHED. REMOVE ALL WIRING BACK TO PANEL G.



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3	REVISION #3	07/19/2016

Revision

Drawing T

ELECTRICAL POWER PLAN - DEMOLITION

Phase

CONCEPT 35% 60% 80% 11

 A/E Project Number
 Drawing Scale: AS NOTED

 12-0009.012
 CADD Filename
 CADD Plot Scale


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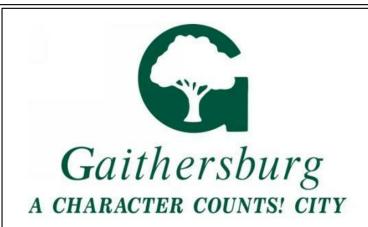
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EDP101



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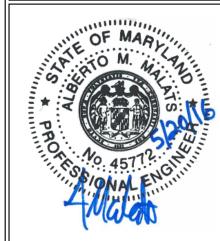


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No.	Description	Date
1	REVISION # 1	06/30/2016
2	REVISION # 2	07/12/2016

ELECTRICAL - POWER RISER DIAGRAM - EXISTING

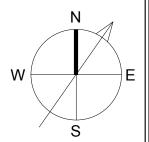
 □ CONCEPT
 □ 35%
 □ 60%
 □ 80%
 ■ 100%


A/E Project Number 12-0009.012	Drawing Scale: AS NOTED
Date 06.30.2016	CADD Filename CADD Plot Some CADD Pl
	Drawn By

Checked By AM

Sheet Number

EDP501

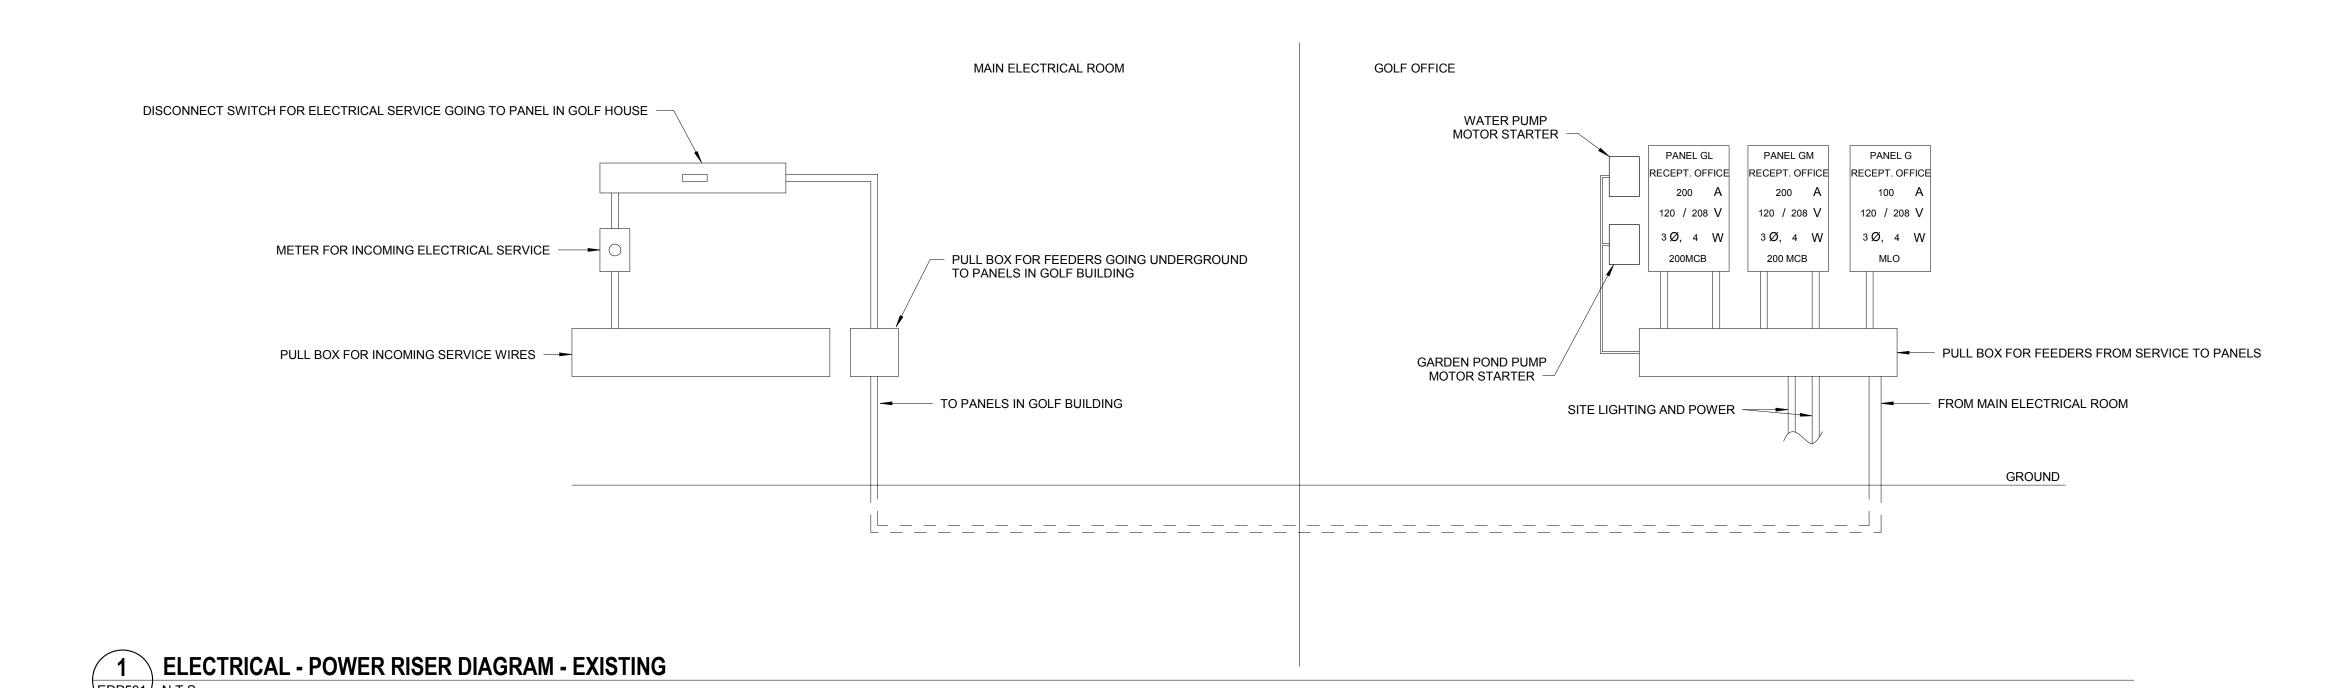

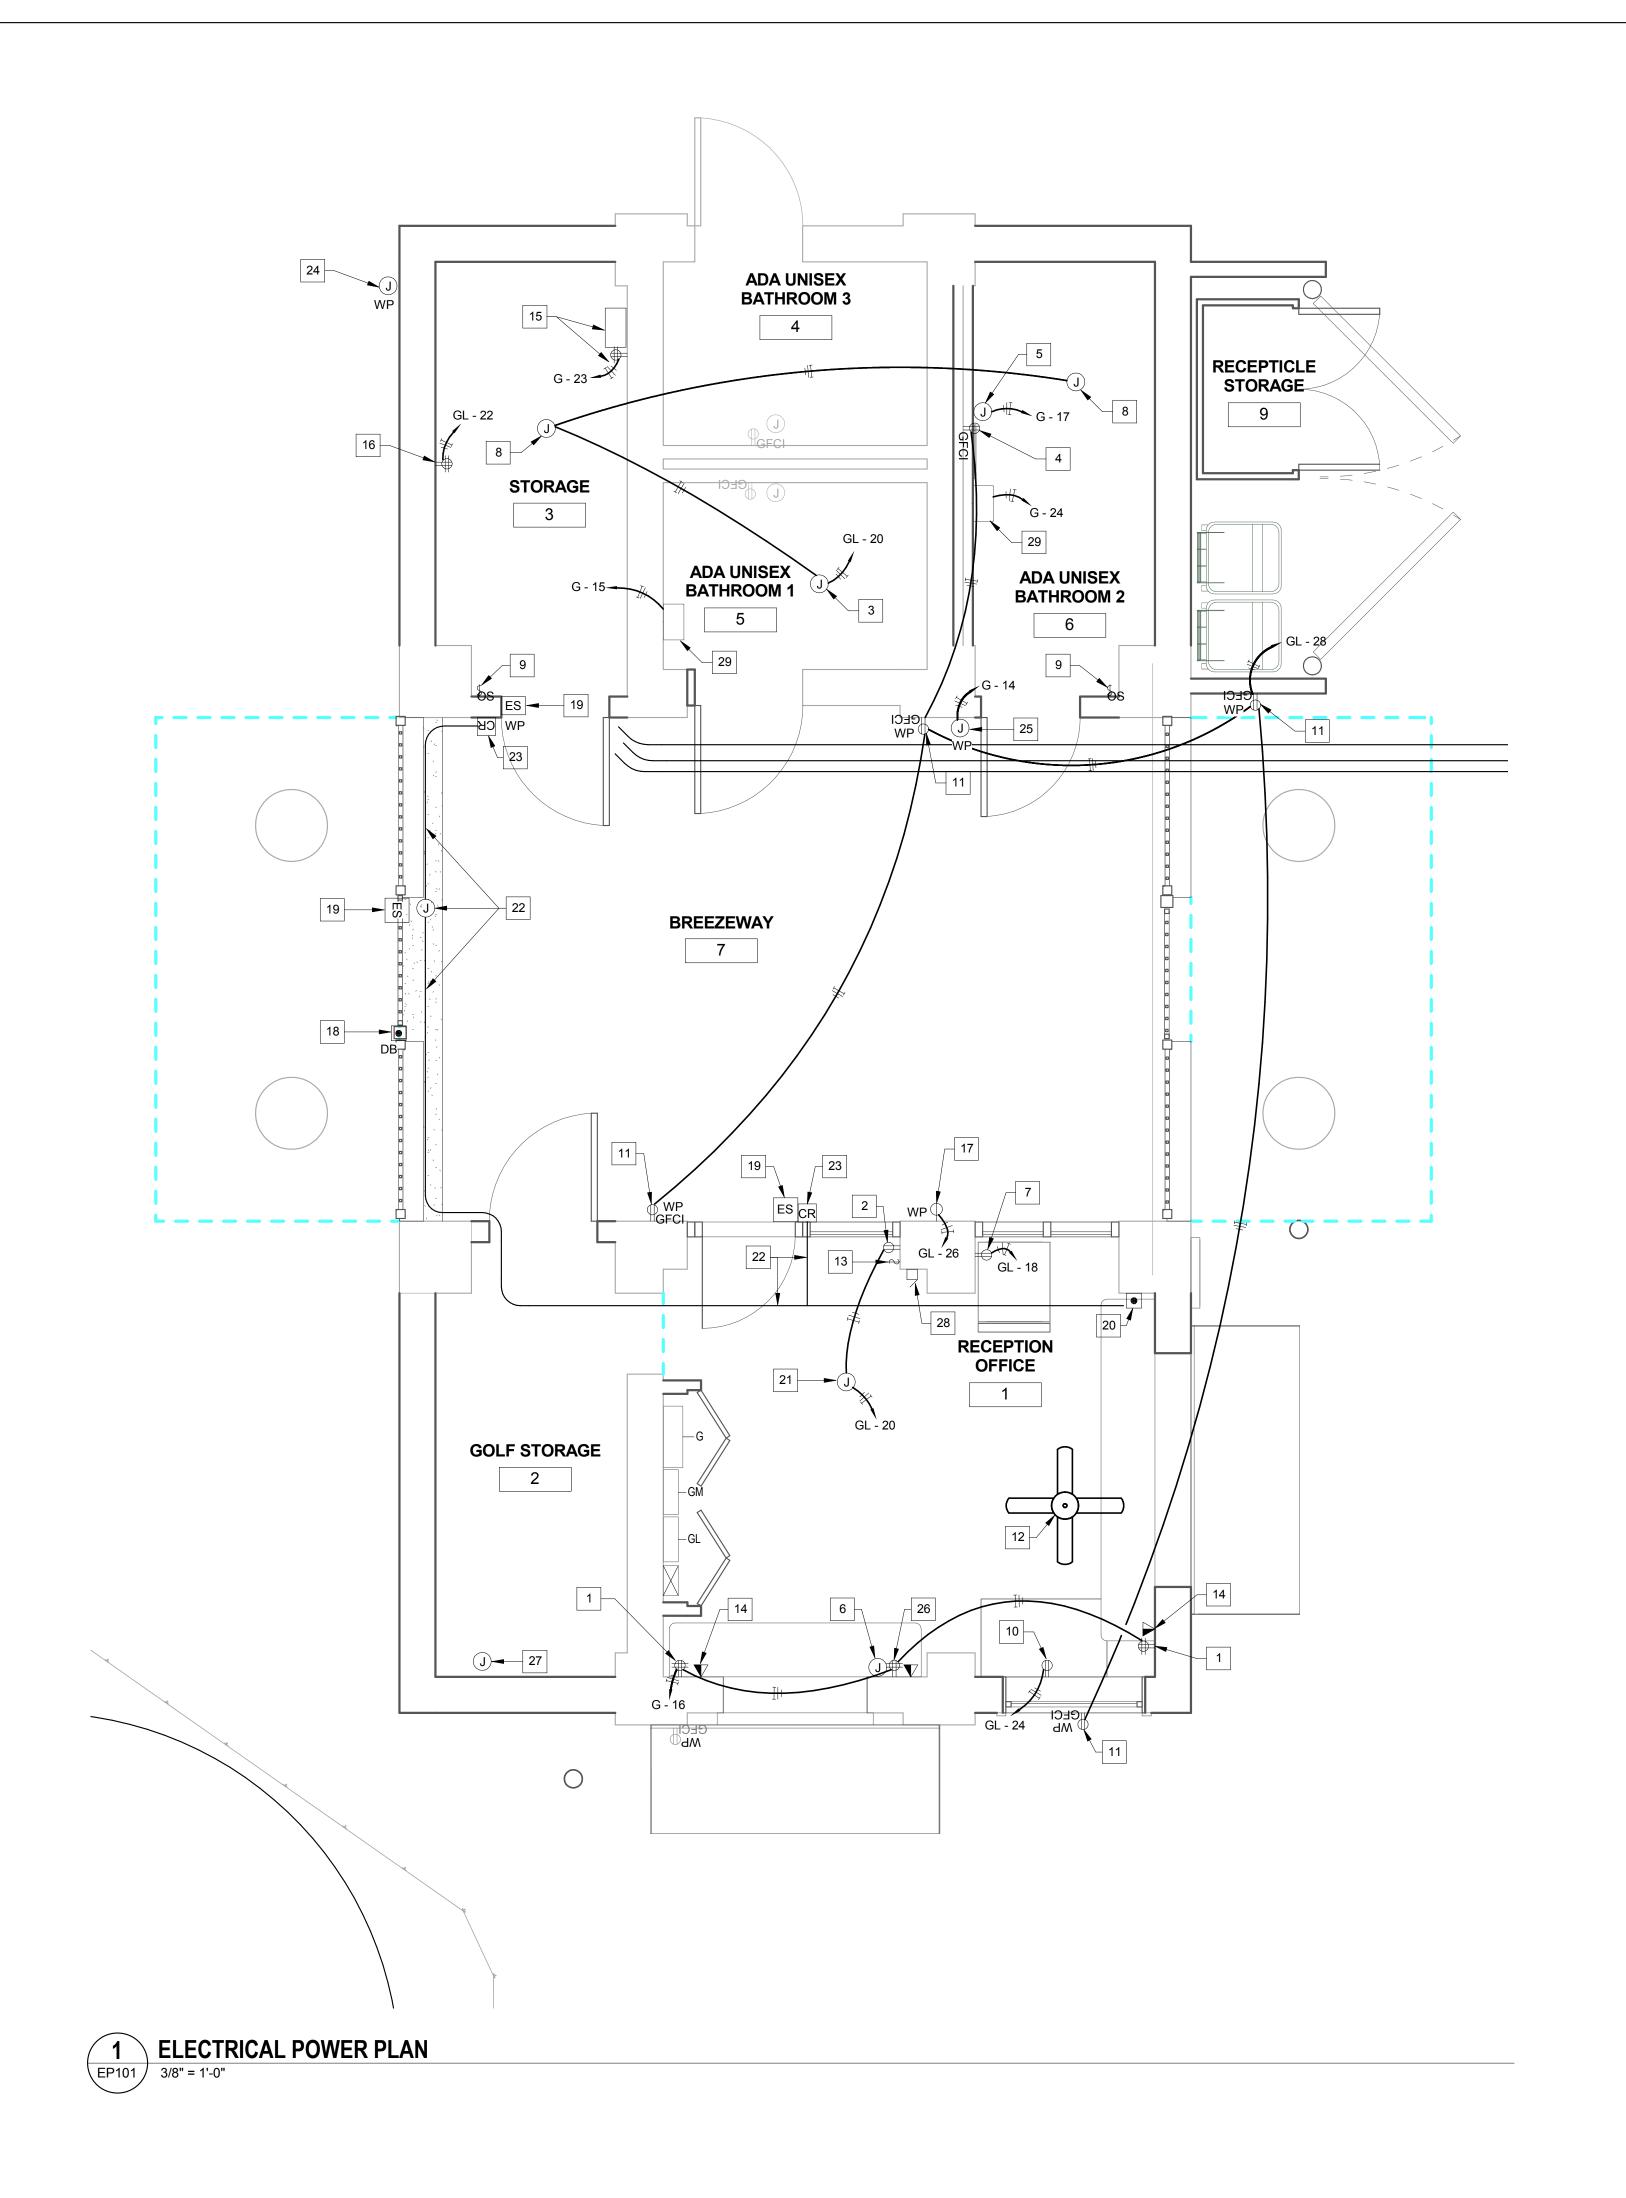

1. ALL CONDUITS SHALL BE CONCEALED. NO CONDUITS SHALL BE EXPOSED.

KEY NOTES

- NEW 120V QUADRUPLEX RECEPTACLES.
- NEW 120V DUPLEX RECEPTACLE. NEW 115V, 1P EXHAUST FAN EF-2
- **SERVING BATHROOM 1.**
- NEW 120V GFCI DUPLEX RECEPTACLE MOUNTED 42" A.F.F. REUSE EXISTING WIRING AND EXTEND AS NEEDED.
- NEW 120V, 60Hz INSTANT HOT WATER HEATER.
- NEW JUNCTION BOX FOR SPEAKER WIRING TO CONTROL UNIT AMPLIFIER WITH MICROPHONE FOR THE NEW PUBLIC ADDRESS SYSTEM MOUNTED 12" ABOVE EQUIPMENT. ALLOW SUFFICIENT ROOM FOR ACCESS. PROVIDE PASS THROUGH FACEPLATE FOR WIRING.
- NEW 120V DUPLEX RECEPTACLE FOR FREEZER. NEW 115V, 1P EXHAUST FAN EF-1

RECEPTACLES.

- SERVING NEW STORAGE ROOM (3) AND ADA BATHROOM 2. CONNECT NEW EXHAUST FANS TO LIGHT
- SWITCH. NEW 120V DUPLEX RECEPTACLE FOR
- FREEZER. NEW 120V WEATHERPROOF GFCI
- 12. NEW CEILING MOUNTED FAN. PROVIDE JUNCTION BOX AND ELECTRICAL POWER. TIE INTO GENERAL RECEPTACLE CIRCUIT (GL-20). JUNCTION BOX SHALL BE RATED TO SUPPORT CEILING FAN.
- NEW SWITCH FOR CEILING FAN. NEW DUAL TELEPHONE AND DATA
- OUTLET.
- NEW TELECOMMUNICATIONS CABINET (BY OTHERS). PROVIDE QUADRUPLEX OUTLET TO PROVIDE POWER AS NECESSARY.
- 16. DEDICATED 120V QUADRUPLEX RECEPTACLE FOR FUTURE IT EQUIPMENT.
- 17. NEW DEDICATED 120V SIMPLEX RECEPTACLE FOR ICE MACHINE.
- NEW DOORBELL FOR POOL AREA EXIT MOUNTED ON FRAME OF GATE. DEVICE SHALL BE WEATHERPROOF. PROVIDE NOTIFICATION DEVICE IN RECEPTION OFFICE.
- 19. NEW ELECTRIC DOOR STRIKE.
- 20. NEW REMOTE ELECTRIC STRIKE DOOR RELEASE BUTTON MOUNTED 54" A.F.F.
- 21. NEW 115V, 1P EXHAUST FAN EF-3 IN RECEPTION OFFICE.
- 22. PROVIDE PULLBOX ABOVE GATE TO RUN WIRING AND CONDUIT TO ALL CARD READERS AND ELECTRIC STRIKES ON THE GATE, STORAGE ROOM, AND THE RECEPTION OFFICE GLASS DOOR. CONDUIT FOR ELECTRIC STRIKES SHALL BE RUN THROUGH DOOR FRAMES.
- 23. NEW CARD READER. CONNECT CARD READER TO ELECTRIC STRIKE.
- 24. PROVIDE POWER FOR RELOCATED WATER FOUNTAIN. REUSE EXISTING WIRING AND CIRCUIT. EXTEND WIRING AS NEEDED.
- 25. PROVIDE POWER FOR NEW 120V WATER COOLER.
- 26. NEW QUADRUPLEX OUTLET PROVIDED
- FOR NEW CONTROL UNIT AMPLIFIER. 27. PROVIDE POWER FOR NEW MOTORIZED DAMPER.
- 28. NEW BUZZER FOR DOORBELL. BUZZER TO BE MOUNTED 8' A.F.F.
- 29. NEW 120V, 1P, HAND DRYER.



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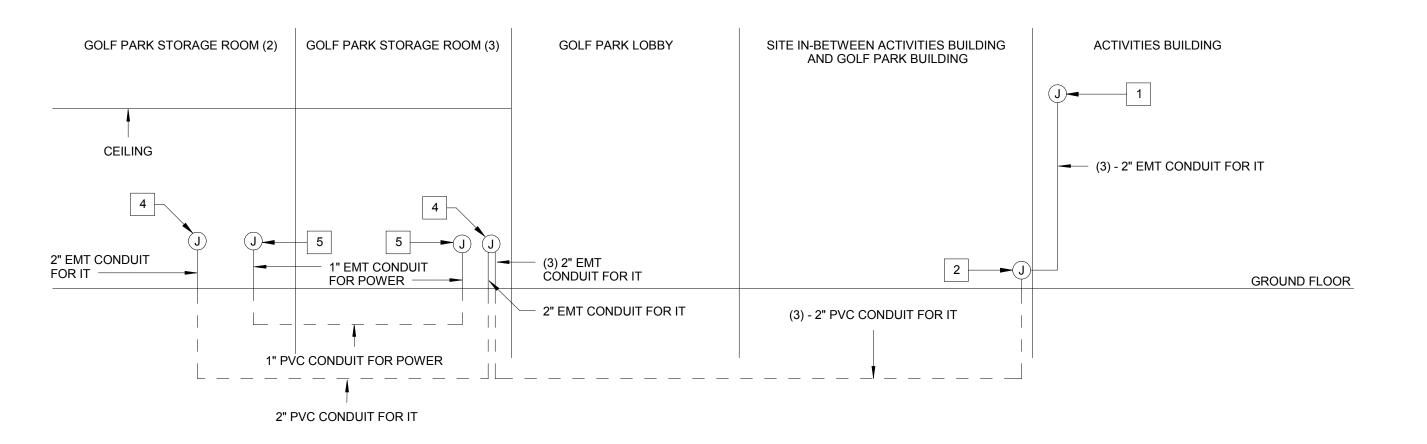
ELECTRICAL POWER PLAN

CONCEPT 35% 60% 80% 100%

A/E Project Number 12-0009.012	Drawing Scale: AS NC	OTED
Date 06.30.2016	CADD Filename Revit Model	CADD Plot Scale 1:1
	Drawn By JO	

Checked By AM Sheet Number

EP101




1 ELECTRICAL CONDUIT RISER DIAGRAM (IT AND POWER ONLY)
N.T.S.

GENERAL NOTES

- 1. ALL EXTERIOR AND NEW GOLF BUILDING CONDUIT SHALL BE CONCEALED.
- 2. PROVIDE RGS FOR 90° ELBOW STUB UP ABOVE GROUND. SEE SHEET E501 FOR DETAILS.

KEY NOTES

- 16"x16" JUNCTION BOX TO BE MOUNTED AT 10' A.F.F. IN THE ACTIVITIES BUILDING.
- 2. 16"x16" WEATHERPROOF JUNCTION
 BOX TO BE MOUNTED OUTSIDE OF THE
 ACTIVITIES BUILDING. RUN TWO 1"
 CONDUIT UNDERGROUND FOR IT
 CABLES AND POWER. JUNCTION BOX
 AND EXPOSED CONDUIT SHALL BE
 PAINTED TO MATCH BUILDING.
- 3. (2) 16"x16" JUNCTION BOXES TO BE MOUNTED ABOVE THE CEILING IN THE GOLF PARK BUILDING. ONE JUNCTION BOX WILL BE USED FOR THE IT CABLES AND THE OTHER WILL BE FOR THE POWER.
- 4. 10"x10" JUNCTION BOX MOUNTED 12"
 A.F.F. IN STORAGE ROOM FOR IT
 CABLES.
- 5. 10"x10" JUNCTION BOX MOUNTED 12" A.F.F. IN STORAGE ROOM FOR POWER FEEDERS.

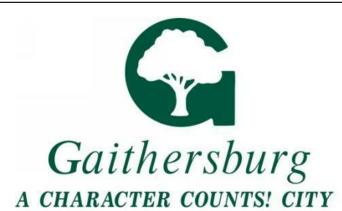

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ELECTRICAL CONDUIT RISER
DIAGRAM
(IT AND POWER ONLY)

CONCEPT 35% 60% 80% ■1

A/E Project Number 12-0009.012	Drawing Scale: AS NOTE	- :C
Date 06.30.2016	CADD Filename CAR Revit Model	\D

Drawn By JO

Checked By AM

Sheet Number

EP501

Branch Panel: G Location: GOLF OFFICE Volts: 120/208 Wye A.I.C. Rating: 10kA Mains Type: MLO Supply From: GM Phases: 3 Mains Rating: 100 A Mounting: Surface Enclosure: Type 1 MCB Rating: 100 A Trip Poles A B
-- -- 0 VA 0 VA 0 VA
-- -- 0 VA 750 VA **Circuit Description** CKT **Circuit Description** CKT 3 Space 5 Space 0 VA 0 VA -- -- Space 7 Space 9 Space 0 VA 0 VA -- -- Space 11 Space 13 Space 1 15 A NEW WATER FOUNTAIN 14 20 A 1 1 1500 VA 1080 VA 15 NEW HAND DRYER (BATHROOM 1) 1 20 A RECEPTION OFFICE COMPUTERS 17 NEW HOT WATER HEATER (BATHROOM 2) 20 A 1 1440 VA | 1200 VA | 1 | 20 A | EX LOAD 19 EX ICE MACHINE 1 20 A EX LOAD 60 A 2 1040 VA 1200 VA 21 ---- -- 1040 VA 1200 VA 1 20 A EX LIGHTS 22 23 NEW IT EQUIPMENT 1440 VA 1500 VA 1 20 A NEW HAND DRYER (BATHROOM 2) 1 20 A EX HAND DRYER 20 A 1 1440 VA 1500 VA 25 EX HOT WATER HEATERS 2 20 A EX DOUBLE HEAD POST LIGHT 27 EX BATHROOM RECEPTACLES 20 A 1 1500 VA 750 VA 1200 VA 750 VA -- -- --29 EX RECEPTACLES 20 A 1 Total Load: 5930 VA 7530 VA 7070 VA Total Amps: 49 A 60 A Connected Load Load Classification **Demand Factor Estimated Demand Panel Totals** 15010 VA 100.00% 15010 VA 0 VA 0.00% 0 VA Total Conn. Load: 20530 VA Largest Motor 0 VA 0.00% 0 VA Total Est. Demand: 20530 VA Total Conn. Current: 57 A Total Est. Demand Current: 57 A

otes:	Branch Panel: GL Location: GOLF OFFICE Supply From: ELECTRICAL SER Mounting: Surface Enclosure: Type 1					Volts: Phases: Wires:	-	/ye				A.I.C. Rating: 10kA Mains Type: MCB Mains Rating: 200 A MCB Rating: 225 A	
СКТ	Circuit Description	Trip	Poles		A	E	3		2	Poles	-	Circuit Description	СКТ
1	EX POND	20 A	3	960 VA	100 VA					1		EX POND STARTERS	2
3						960 VA	1200 VA			1		EX SODA MACHINE	4
5								960 VA	1200 VA	1		EX ISOLATED GRND CASH REGISTER	6
7	EX WATERFALL	40 A	3	3600 VA	1200 VA					1		EX SODA MACHINE	8
9			-			3600 VA	600 VA			1		EX SECURITY LIGHT	10
11								3600 VA	1200 VA	1		EX LEFT QUAD	12
13	EX POLE 1 / PUTT PRAC	20 A	2	1040 VA	1200 VA					1	20 A	EX LOAD	14
15			-			1040 VA	1200 VA			1	20 A	EX PLUG ICE CREAM	16
17	EX POLE6 / HOLE 4	20 A	2					1040 VA	1200 VA	1	20 A	NEW FREEZER RECEPTACLE	18
19			-	1040 VA	1403 VA					1	20 A	NEW OFFICE REC+LGT,CLG FAN, EF-1,2,3	20
21	EX PLANTER GROUND LIGHTS	20 A	1			600 VA	360 VA			1	20 A	NEW IT ROOM RECEPTACLE	22
23	EX WATERFALL GRND LIGHTS & SPIKE	20 A	1					600 VA	1200 VA	1	20 A	NEW ICE CREAM FREEZER RECEPTACLE	24
25	EX EMERGENCY LIGHTS	20 A	1	600 VA	1200 VA					1	20 A	NEW ICE MACHINE RECEPTACLE	26
27	EX EMERGENCY LIGHTS	20 A	1			600 VA	1680 VA			1	20 A	NEW GFCI RECPTS BATHROOM & OUTDOOR	28
29	EX EMERGENCY LIGHTS	20 A	1					600 VA	1200 VA	1	20 A	EX 10' TIME CLOCK LIGHT POLES	30
	1	Total	Load:	1234	43 VA	1184	0 VA	1280	0 VA		1		
		Total	Amps:	10	4 A	99	Α	107	7 A	ı			
egeno	l: : :lassification		Conne	cted Load	I	Demand Fac	ctor	Estimated	d Demand	1		Panel Totals	
wer			171	141 VA		100.00%		1714	1 VA				
otor				80 VA		100.00%			0 VA		Total Conn. Load: 36996 VA		
argest Motor				300 VA		125.00%			00 VA			Total Est. Demand: 39696 VA	
.3555.51					33 V/V		120.0070		10000 VA			Total Conn. Current: 103 A	
											Tota	I Est. Demand Current: 110 A	
otes:													



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3	REVISION # 3	07/19/2016

Revis

Drawing T

ELECTRICAL PANEL SCHEDULES

Pha

 □ CONCEPT
 □ 35%
 □ 60%
 □ 80%
 ■ 100%


A/E Project Number 12-0009.012	Drawing Scale: AS NOTED		
Date 06.30.2016	CADD Filename Revit Model	CADD Plot Scale 1:1	
	Drawn By JO		

Drawn By JO

Checked By AM

Sheet Number

EP601

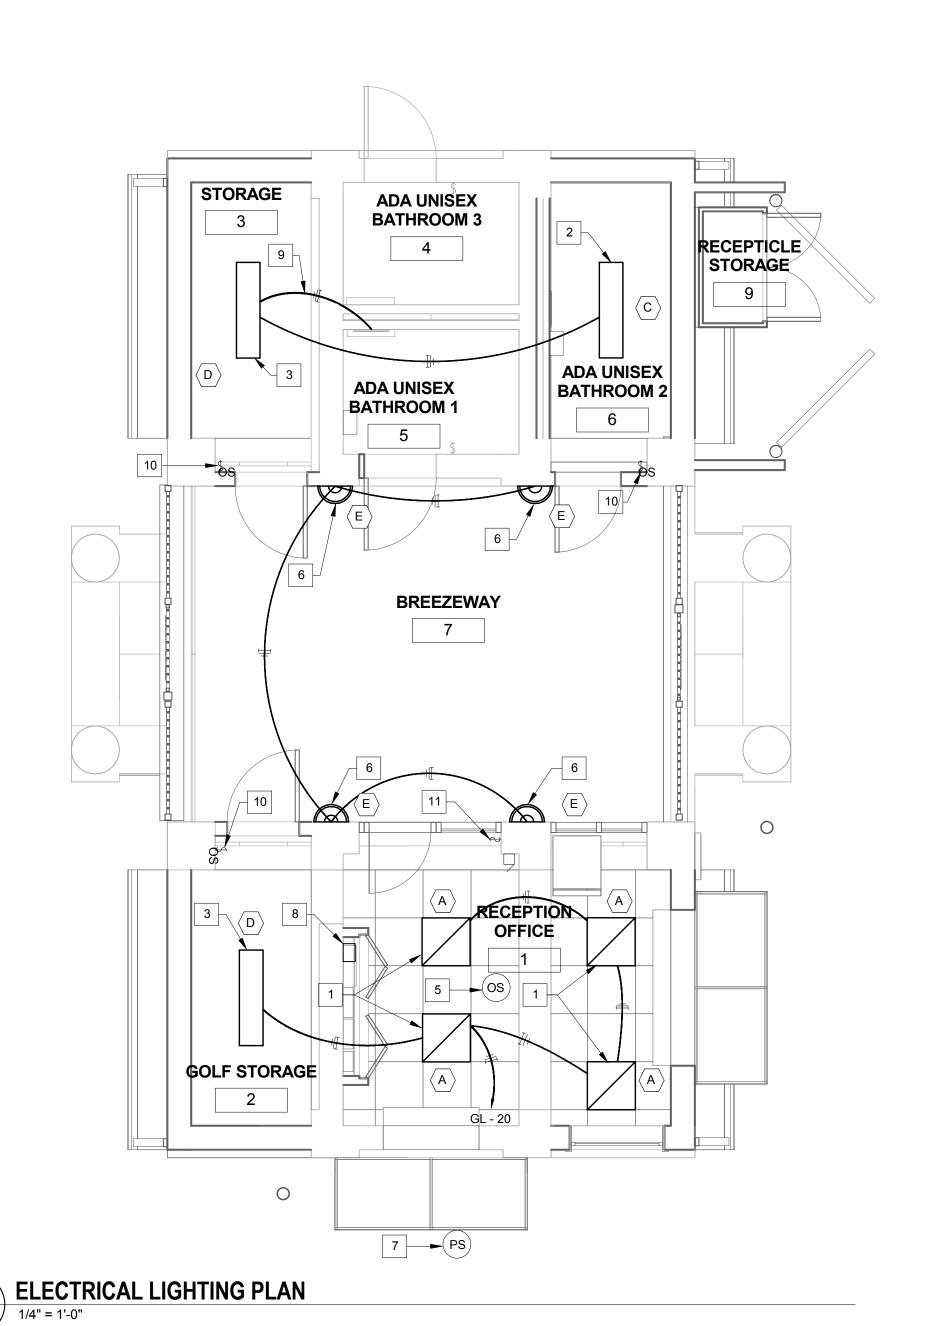

EL101

GENERAL NOTES

- 1. ALL FLUORESCENT FIXTURES AND LAMPS MUST BE RATED TO WITHSTAND TEMPERATURES AT 0° F.
- 2. TIE LOBBY AND EXTERIOR FIXTURES TO NEW TIMECLOCK AND PHOTOCELL. EXISTING TIMECLOCK AND PHOTOCELL MAY BE REUSED.

KEY NOTES

- 1. NEW 120V 2'x2' RECESSED FLUORESCENT PARALOUVER LIGHT FIXTURE.
- 2. NEW 120V 1'x4' FLUORESCENT LIGHT FIXTURE TO BE INSTALLED IN BATHROOM.
- NEW 120V 1'x4' LINEAR
 FLUORESCENT LIGHT FIXTURE TO
 BE INSTALLED IN STORAGE ROOM.
 NOT USED.
- 5. NEW OCCUPANCY SENSOR
 MOUNTED ON THE CEILING OF THE
 RECEPTION OFFICE.
- 6. NEW LED WALL SCONCE LIGHT FIXTURE. REUSE EXISTING WIRING AND CIRCUIT.
- 7. NEW PHOTO SENSOR LOCATED ON THE WALL AT 14' A.F.F. CONNECT TO THE LOBBY WALL SCONCE AND EXTERIOR LIGHT FIXTURES.
- 8. NEW TIME CLOCK WITH MANUAL OVERRIDE FOR LIGHTING FIXTURES, COORINDATE LOCATION W/EXISTING ELECTRICAL EQUIPMENT.
- 9. CONNECT NEW STORAGE ROOM AND BATHROOM LIGHT FIXTURE TO EXISTING BATHROOM LIGHT CIRCUIT.
- 10. NEW LIGHT SWITCH WITH OCCUPANCY SENSOR.



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Revisions

Drawing 1

ELECTRICAL LIGHTING PLAN


☐ CONCEPT ☐ 35% ☐ 60% ☐ 80% **■** 100%

Date 06.30.2016

Checked By AM

Sheet Number

EL101

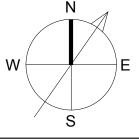

	LUMINARIES SCHEDULE										
							LAMP DATA				
TYPE	FIXTURE TYPE	MOUNTING	MOUNTING HEIGHT (A.F.F.)	VOLTS	NOMINAL WATTS	TOTAL WATTS	LAMPS	TYPE	MANUFACTURER	CATALOG NO.	NOTES
$\langle A \rangle$	2'X2' RECESSED PARALOUVER	CEILING RECESSED	9'-0"	UNV	14	28	2	FLUOR	PHILIPS LIGHTING	2ESG214-23FMW-UNIV1/2	
$\langle B \rangle$	LED FLOOD LIGHT	POLE MOUNTED & WALL MOUNTED	SEE NOTES	UNV	52	52	1	LED	PHILIPS LIGHTING	CSFS32L530NWG1SFSPUNIV	FIXTURE ON THE NORTH EAST SIDE OF THE BUILDING (TOWARDS ACTIVITIES BUILDING) SHALL BE MOUNTED AT 15'. FIXTURE ON THE SOUTH EAST SIDE OF THE BUILDING (TOWARDS GOLF COURSE) SHALL BE MOUNTED AT 12'.
⟨c⟩	1'x4' CEILING MOUNTED LIGHT	CEILING MOUNTED	9'-0"	UNV	32	64	2	FLUOR	PHILIPS LIGHTING	1SPF232-FS01-UNIV	
D	4' SURFACE MOUNTED STRIP LIGHT	CEILING & WALL SURFACE	9'-0"	UNV	31	61	2	FLUOR	PHILIPS LIGHTING	HDS232-UNV-LT	
⟨E⟩	LED WALL SCONCE	WALL SURFACE	8'-0"	UNV	35	35	1	LED	PHILIPS LIGHTING	106L-3-35LA-NW-UNIV-NP	





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Revisions

Drawing T

ELECTRICAL LUMINARES
SCHEDULE

Phase

CONCEPT 35% 60% 80% 100%

A/E Project Number	Drawing Scale: AS NOTED			
Date 06.30.2016	CADD Filename Revit Model	CADD Plot Scale 1:1		
	Drawn Pv			

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Sheet Number

EL501



Statistics						
Description	Symbol	Avg	Max	Min	Max/Min	Avg/Min
ADA BATHROOM	+	24.7 fc	31.3 fc	14.9 fc	2.1:1	1.7:1
LOBBY	+	8.2 fc	10.6 fc	4.4 fc	2.4:1	1.9:1
RECEPTION OFFICE	+	22.9 fc	26.5 fc	16.7 fc	1.6:1	1.4:1
STORAGE (2)	+	22.4 fc	26.7 fc	14.8 fc	1.8:1	1.5:1
STORAGE (3)	+	22.1 fc	27.0 fc	14.1 fc	1.9:1	1.6:1



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LIGHTING CALCULATIONS -**INTERIOR**

☐ CONCEPT ☐ 35% ☐ 60% ☐ 80% **☐** 100%

	Drawing Scale: AS NOTED		
Date 06.30.2016 CADD Fit	lename evit Model	1:1	


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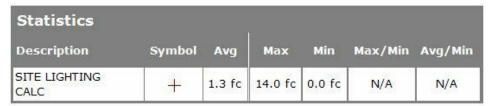
Sheet Number


EL601

1 ELECTRICAL LIGHTING CALCULATIONS - INTERIOR

1/8" = 1'-0"



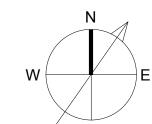

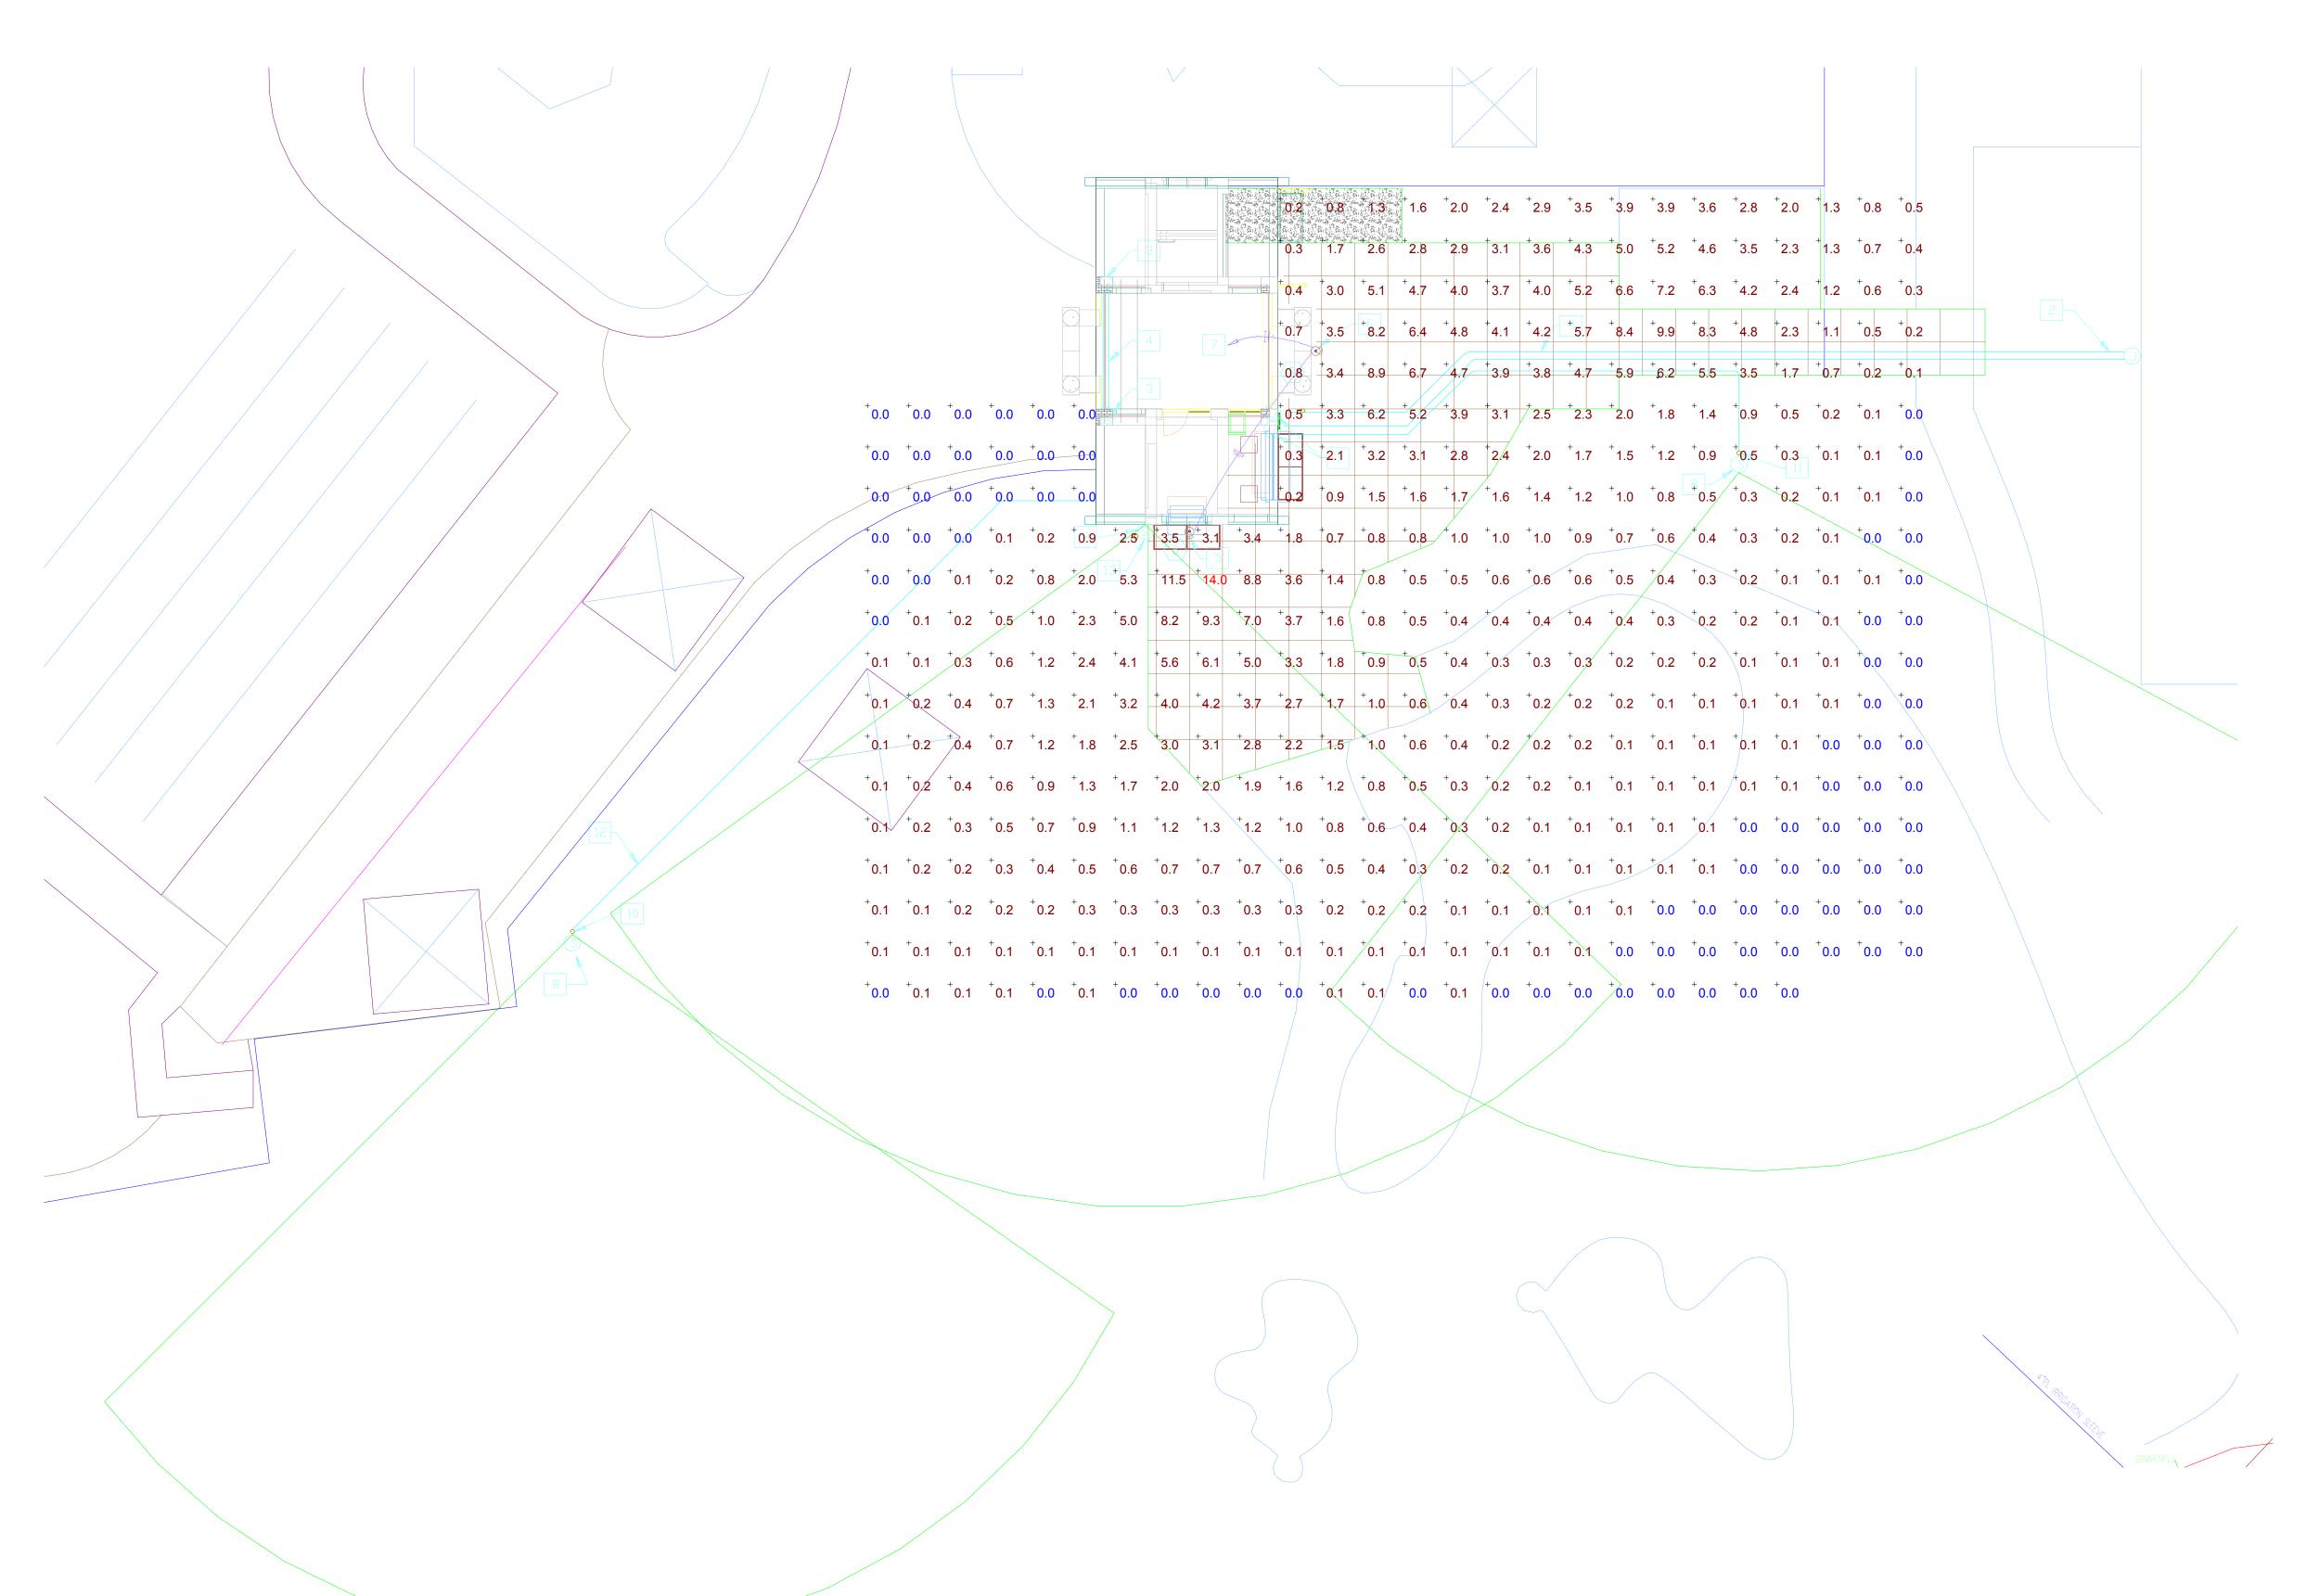



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Revisi

Drawing Title

LIGHTING CALCULATIONS -SITE

Phase

CONCEPT 35% 60% 80% 100%

	A/E Project Number 12-0009.012	Drawing Scale: AS NOTED	
	Date 06.30.2016	CADD Filename Revit Model	CADD Plot Sca 1:1
		Drawn By	

Drawn By JO

Checked By AM


Sheet Number

EL602



GENERAL NOTES

1. ALL CONDUIT SHALL BE CONCEALED.

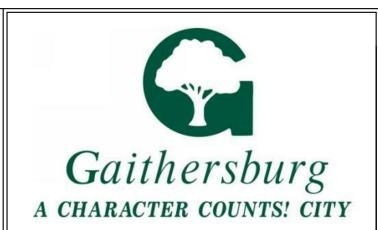

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SECURITY RISER DIAGRAM


☐ CONCEPT ☐ 35% ☐ 60% ☐ 80% **☐** 100%

A/E Project Number	Drawing Cools, AC NC)TED
12-0009.012	Drawing Scale: AS NC	, ED
Date 06.30.2016	CADD Filename Revit Model	CADD Plot So 1:1
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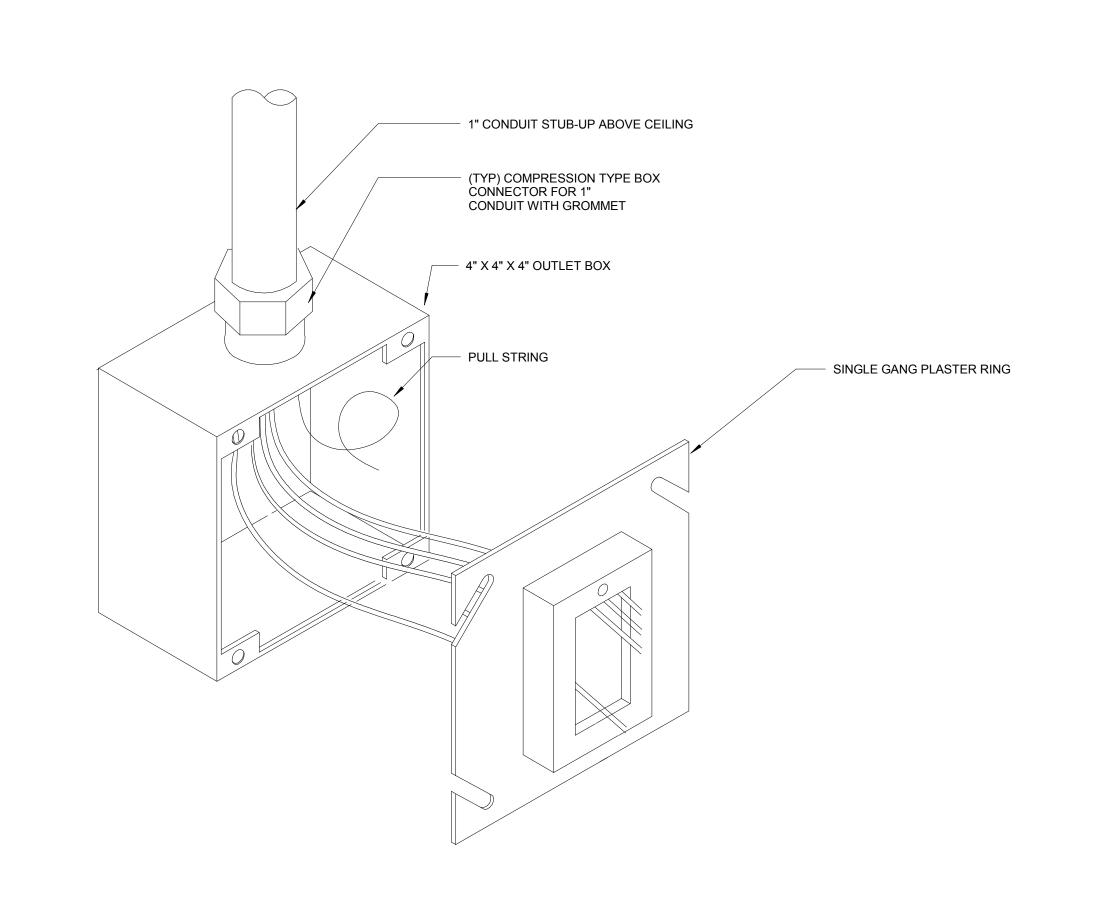
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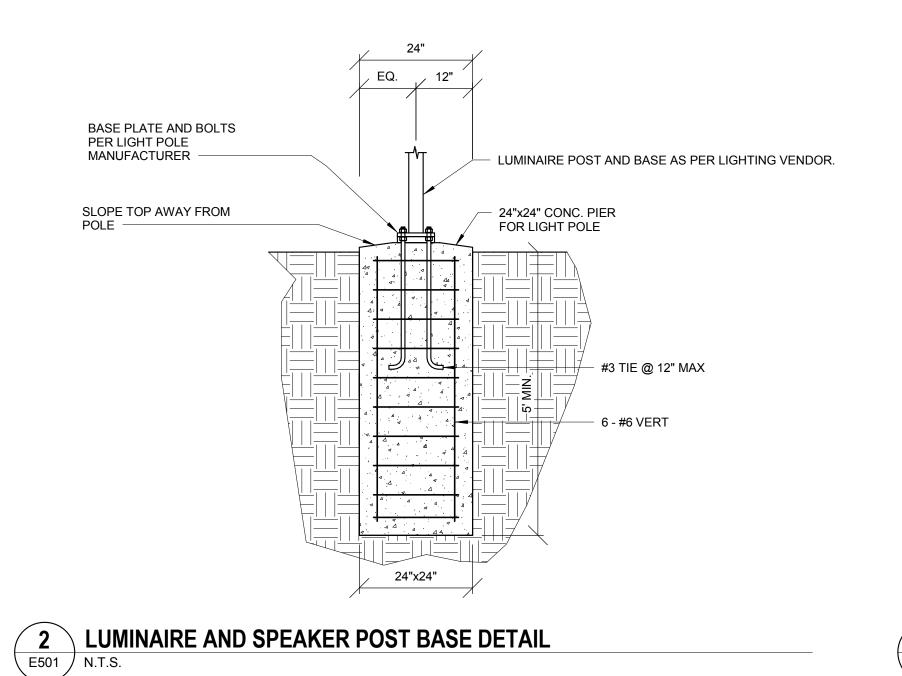
EY501




1 SECURITY RISER DIAGRAM
N.T.S.

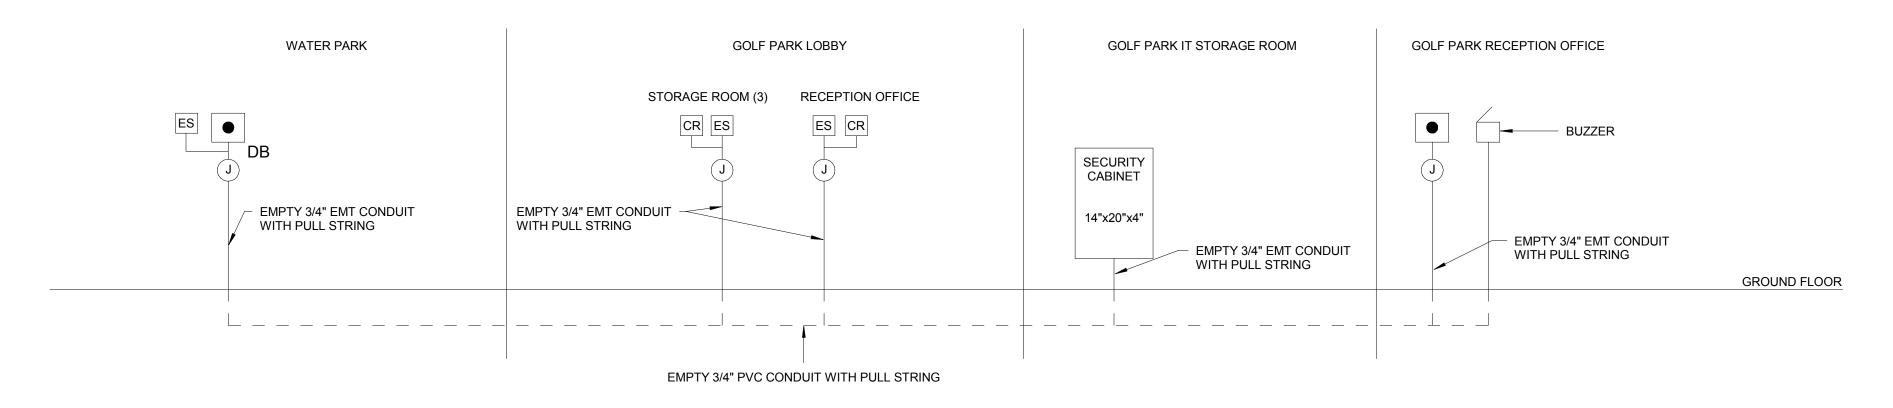

VOICE-DATA OUTLET



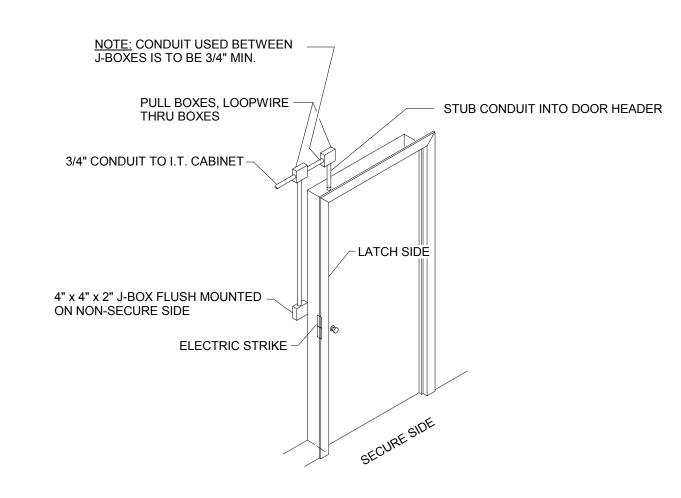

3 DOOR ELECTRIC STRIKE AND CARD READER CONDUIT DETAIL
E501 N.T.S.

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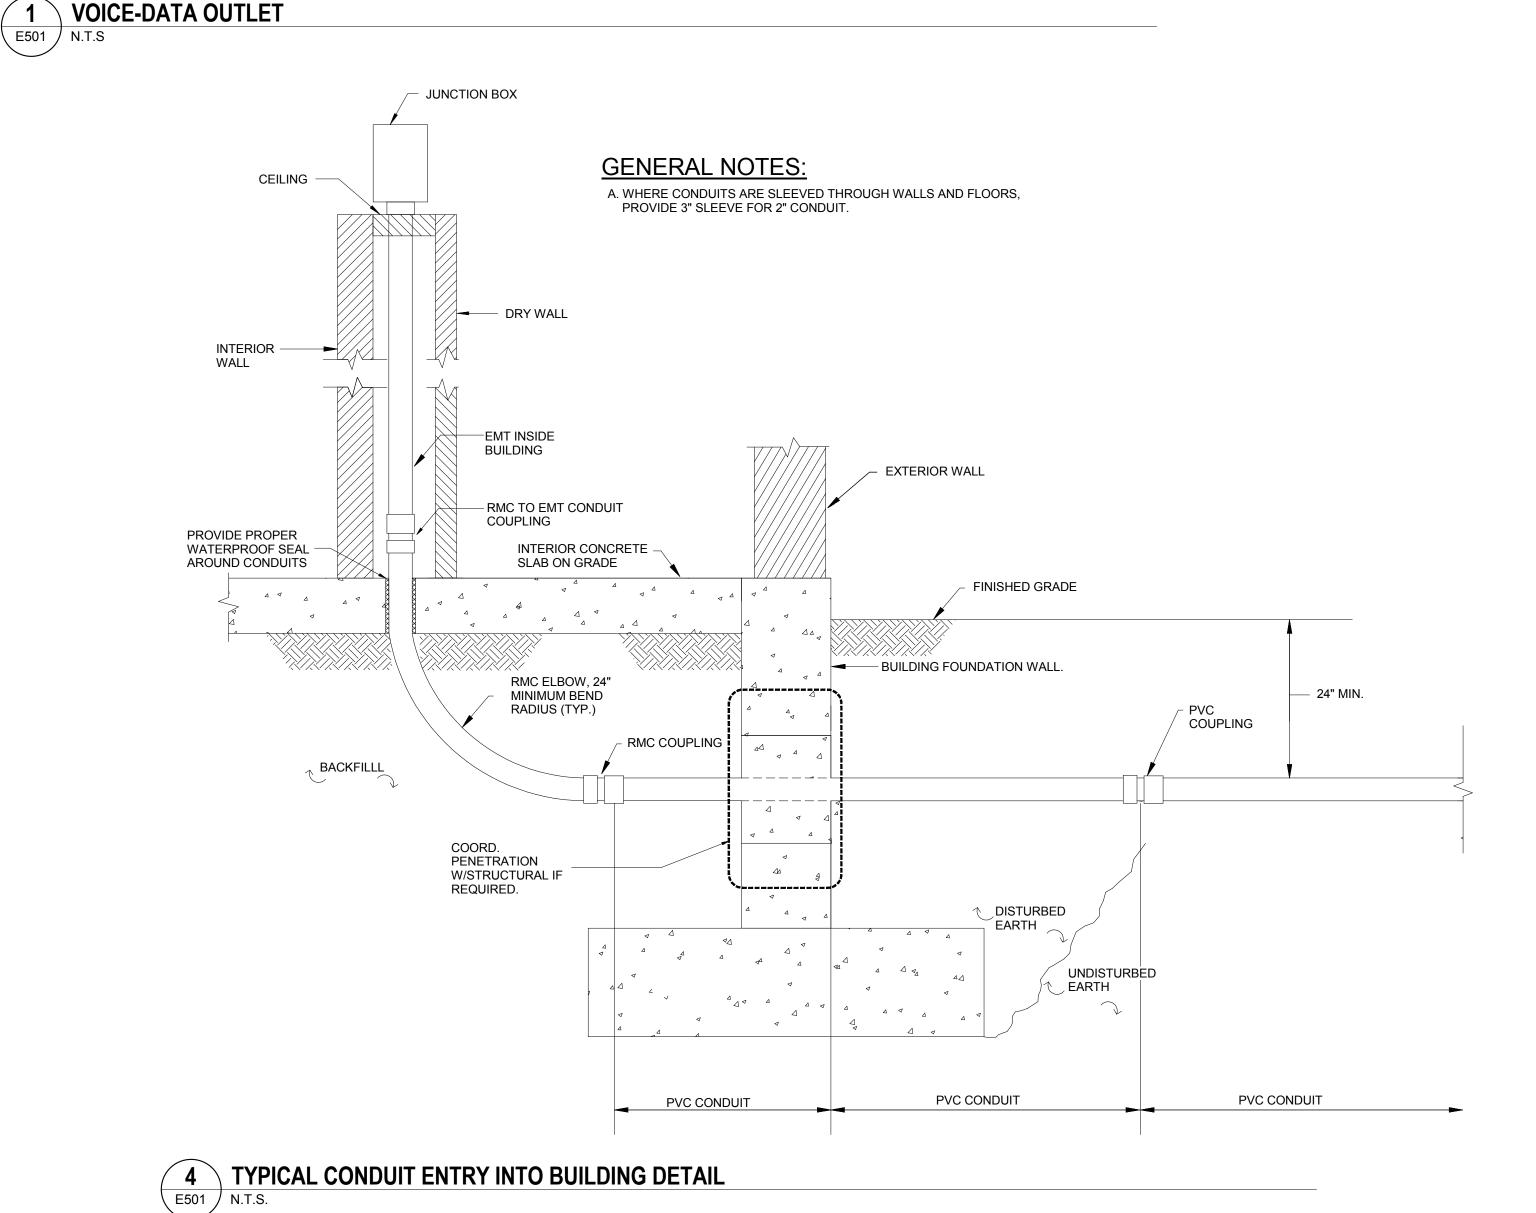
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24" MAX	IN PAVEMENT, PATCH IN ACCORDANCE WITH SPECIFICATIONS. IN LAWN AREA, GRADE AND SEED TO MATCH EXISTING
	(151((1(1)(1)(151((1
	EXISTING GRADE
	6" WIDE MARKER TAPE TO RUN CONTINUOS OVER CONDUIT BACKFIELD EARTH
	— SAND
	— SCHEDULE 40 PVC. REFER TO CABLE SCHEDULE ON SHEET T515 FOR REQUIRED CONDUIT SIZES
	— VOICE/DATA CABLES
NOTE: WHERE MORE THAN ONE CONDUI	T IS INSTALLED IN

WHERE MORE THAN ONE CONDUIT IS INSTALLED IN TRENCH, PROVIDE THE PROPER MARKER TAPE OVER EACH CÓNDUIT.

UNDERGROUND TRENCH DETAIL



E501 N.T.S.

Drawing Title **ELECTRICAL DETAILS** ☐ CONCEPT ☐ 35% ☐ 60% ☐ 80% **☐** 100% A/E Project Number Drawing Scale: AS NOTED 12-0009.012 CADD Filename CADD Plot Scale 1:1 06.30.2016 Drawn By JO Checked By AM Sheet Number **E501**

Description


1 REVISION # 1 2 REVISION # 2 Date

06/30/2016

07/12/2016

PIP	PING SYMBOLS	<u>ABBREVIATIONS</u>		
CW	NEW DOMESTIC COLD WATER (CW)	AP	ACCESS PANEL	
	— NEW DOMESTIC HOT WATER (HW)	ABV	ABOVE	
		AFF	ABOVE FINISH FLOOR	
—— HWR ———	— NEW DOMESTIC HOT WATER RETURN (HWR)	BEL BFPR	BELOW PREVENTER	
	— NEW SANITARY PIPE (SAN)	BV	BACKFLOW PREVENTER BALANCING VALVE	
	_ NEW VENT PIPE (V)	CLG	CEILING	
G	NEW NATURAL GAS PIPE	СО	CLEANOUT	
P	PROPANE GAS PIPE	(E)	EXISTING	
O	—— FUEL OIL PIPE	FCO FD	FLOOR CLEANOUT FLOOR DRAIN	
TP	TRAP PRIMER PIPE	DHWT	DOMESTIC HOT WATER TANK	
	NEW SHUT-OFF VALVE	НВ	HOSE BIBB	
	DEMOLITION PIPE	OHB	OPEN HUB DRAIN	
CW	— EXISTING DOMESTIC COLD WATER (CW)	SP	SOIL PIPE	
		SS TP	SOIL STACK TRAP PRIMER	
—— HW ———	EXISTING DOMESTIC HOT WATER RETURN (LIMP)	V	VENT	
—— HWR ———	EXISTING DOMESTIC HOT WATER RETURN (HWR)	VIF	VERIFY IN FIELD	
	— NEW SANITARY PIPE (SAN)	VS VTR	VENT STACK	
	NEW VENT PIPE (V)	VTR NG	VENT THRU ROOF NATURAL GAS PIPE	
——₩——	EXISTING SHUT-OFF VALVE	LP	LIQUID PROPANE PIPE	

GENERAL SYMBOLS

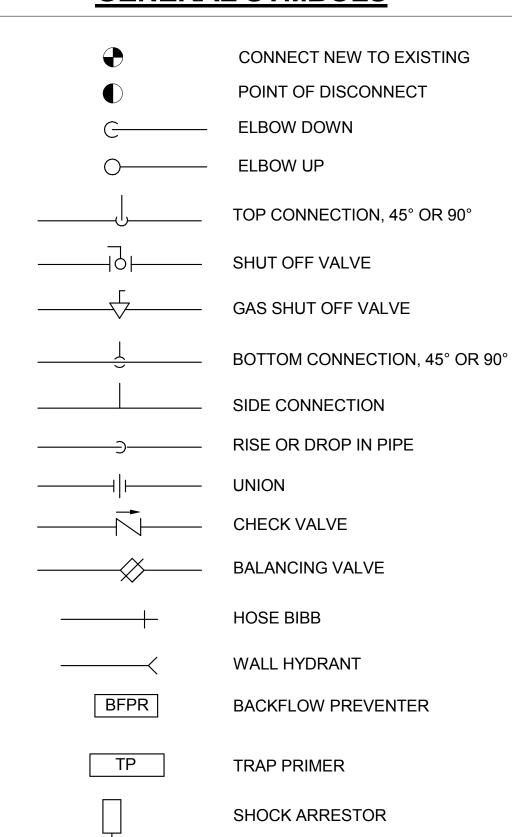

GENERAL CIVIL NOTES:

- 1. LOCATIONS OF EXISTING PIPING SHOWN ARE APPROXIMATE AND TAKEN FROM AVAILABLE RECORDS. CONTRACTOR IS RESPONSIBLE FOR LOCATING/FIELD VERIFYING ALL UTILITES IN PROJECT AREA SHOWN ON DRAWINGS, PRIOR TO ANY EXCAVATION.
- 2. CONTRACTOR SHALL BE RESPONSIBLE FOR PROTECTION OF ALL EXISTING UNDERGROUND UTILITIES.
- 3. CONTRACTOR SHALL CONTACT ALL LOCAL UTILITY AUTHORITIES AS REQUIRED, AT LEAST 48 HOURS PRIOR TO EXCAVATIONS.
- 4. CONTRACTOR SHALL BE RESPONSIBLE FOR PROVIDING ALL NECESSARY DETECTION EQUIPMENTS OR TEST PITTING AS REQUIRED, TO DETERMINE EXACT LOCATIONS OF ALL UTILITIES PRIOR TO EXCAVATION ACTIVITIES.
- 5. WHEN WORKING AROUND EXISTING BUILDING/STRUCTURE, CONTRACTOR NEEDS TO TAKE EXTREEM CARE TO PROTECT IT. ANY DAMAGES SHALL BE REPAIRED, REPLACED, OR RESTORED TO THE SATISFACTION OF TH EOWNER AND SHALL NOT RESULT IN ANY EXTRA COST TO OWNER.
- 6. CONTRACTOR SHALL BE REQUIRED TO RESTORE ALL APVEMENTS, CURBS, GUTTERS, SIDEWALKS, AND PAVEMENT TO THEIR ORIGINAL PRE-CONSTRUCITON CONDITION FOR ALL DISTURBED AREAS.
- 7. UPON COMPLETION OF WORK EVERYDAY, CONTRACTOR SHALL REMOVE DIRT, ASPHALT AN DSWWEP ALL AREAS OF PAVEMENT AND LEAVE THE SITE IN A NEAT AND CLEAN CONDITION. HE/SHE SHALL LEAGLLY DISPOSE IF DEMOLISHED DEBRIS OFF OWNER'S PROPERTY.
- 8. CONTRACTOR SHALL COORDINATE CONSTRUCTION SCHEDULE AND TRAFFIC CONTROL PLAN WITH OWNER IN ORDER TO MAINTAIN ACCESS TO EXISTING FACILITIES.
- 9. CONTRACTOR SHALL PROVIDE TRAFFICE CONTROL MEASURES (VEHICULAR AND PEDESTRIAN) IN ACCORDANCE WIT HTH EMANUAL ON UNIFORM TRAFFIC CONTROL DECIES (MUTCD), TH EOWNER AND AGENCIES HAVING JURISDICTION WHILE WORKING ON SIDEWALKS AND PARKING LOT.

PLUMBING GENERAL NOTES:

- 1. CONTRACTOR SHALL BE RESPONSIBLE FOR VISITING THE SITE AND VERIFYING ALL EXISTING FIELD CONDITIONS PRIOR TO SUBMISSION OF HIS BID.
- 2. CONTRACTOR IS RESPONSIBLE FOR COORDINATING HIS WORK WITH THE WORK OF ALL OTHER TRADES AND MAKING ANY NECESSARY MODIFICATIONS TO HIS WORK AT NO ADDITIONAL COST, INCLUDING ALL OFFSETS.
- 3. CONTRACTOR SHALL BE RESPONSIBLE FOR RELOCATION OF ANY EXISTING MINOR INTERFERENCE'S, INCLUDING CONDUIT, HANGERS, ETC., AT NO ADDITIONAL COST.
- 4. CONTRACTOR SHALL REMOVE EXISTING EQUIPMENT AND MATERIALS PERTAINING TO HIS CONTRACT AS SPECIFIED OR AS REQUIRED WHETHER SHOWN ON THE DRAWINGS OR NOT, TO PREPARE FOR THE NEW WORK.
- 5. ALL WORK AND MATERIALS SHALL BE IN ACCORDANCE WITH LOCAL CODES. THESE CODES SHALL BE FOLLOWED AS MINIMUM PROVIDING HIGHER GRADES OF MATERIAL AND WORKMANSHIP WHERE REQUIRED BY THESE DOCUMENTS. PROVIDE ALL TESTS REQUIRED BY LOCAL CODES.
- 6. CITY OF GAITHERSBURG WILL REIMBURSE ALL PERMITTING FEES TO THE CONTRACTOR.
- 7. SUBMIT ASSEMBLED PRINTED INSTRUCTIONS FOR THE OPERATION AND MAINTENANCE OF EACH ITEM INSTALLED ALONG WITH EQUIPMENT CUTS AND CONTROL WIRING DIAGRAMS.
- 8. SUBMIT COORDINATED SHOP DRAWINGS FOR REVIEW. THE SHOP DRAWINGS SHALL INDICATE WORK OF OTHER TRADES AND MUST BE SUBMITTED PRIOR TO FABRICATION AND INSTALLATION.
- 9. SUBMIT EQUIPMENT SPECIFICATIONS FOR REVIEW BEFORE PURCHASE.
- 10. CONTRACTOR SHALL GUARANTEE ALL WORK AND MATERIAL FOR ONE YEAR AFTER COMPLETION AGAINST ALL DEFECTS OF MATERIAL, EQUIPMENT AND WORKMANSHIP.
- 11. PROVIDE COMPETENT OPERATING TECHNICIAN TO INSTRUCT THE OWNER IN THE OPERATION AND MAINTENANCE OF THE INSTALLED EQUIPMENT.
- 12. PROVIDE ACCESS PANELS FOR ALL VALVES OR ANY PIECE OF EQUIPMENT WHEN NECESSARY TO LOCATE ABOVE NON-ACCESSIBLE CEILINGS. SUBJECT TO THE APPROVAL OF THE ARCHITECT. NO EQUIPMENT SHALL BE LOCATED DIRECTLY ABOVE WALLS.
- 13. PROVIDE ALL HOLES, SLEEVES AND CAULKING FOR INSTALLATION OF THIS WORK. CAULKING TO CONFORM TO FIRE RATING OF WALLS.
- 14. PIPING SHALL BE ABOVE CEILING AND CLEAR ANY EXISTING PIPING, LIGHTING FIXTURES, DUCTS, ETC.
- 15. RUN NEW WASTE PIPES AS CLOSE AS POSSIBLE TO UNDERSIDE OF FLOOR SLAB AND VENT PIPING AS CLOSE AS POSSIBLE TO SLAB ABOVE.
- 16. CONTRACTOR SHALL SUBMIT SKETCH TO THE STRUCTURAL ENGINEER FOR APPROVAL, PRIOR TO MAKING REQUIRED BEAM PENETRATIONS.
- 17. DISRUPTION OF ANY EXISTING SERVICE SHALL BE COORDINATED WITH THE OWNER AND SHALL BE PERFORMED AT A TIME AND MANNER SO AS TO CAUSE THE OWNER A MINIMUM OF INCONVENIENCE.
- 18. FOR EXACT LOCATION OF PLUMBING FIXTURES, REFER TO ARCHITECTURAL PLANS AND ELEVATIONS.
- 19. SIZES AND ROUTING OF EXISTING PIPING ARE BASED ON AS-BUILT DRAWINGS PROVIDES BY CITY OF GAITHERSBURG. CONTRACTOR SHALL FIELD VERIFY EXISTING CONDITIONS AND SHALL REPORT CONSISTENCY TO AE PRIOR TO START OF WORK.
- 20. CONTRACTOR SHALL LOCATE NEW SANITARY (2%SLOPE) AND VENT PIPING TO GREASE INTERCEPTOR TO ENSURE THAT THE INVERT OF EXISTING PIPING (THAT NEED TO BE CONNECTED) ARE MAINTAINED.

EXAMINATION OF EXISTING CONDITIONS:

- 1. PRIOR TO BID VISIT AND CAREFULLY EXAMINE THOSE PORTIONS OF THE PRESENT BUILDING AFFECTED BY THIS WORK SO AS TO BECOME FAMILIAR WITH EXISTING CONDITIONS AND DIFFICULTIES THAT WILL ATTEND THE EXECUTION OF THE WORK BEFORE SUBMITTING PROPOSALS.
- 2. SUBMISSION OF A PROPOSAL WILL BE CONSTRUCTED AS EVIDENCE THAT SUCH EXAMINATION HAS BEEN MADE AND LATER CLAIMS FOR LABOR, EQUIPMENT OR MATERIALS REQUIRED BECAUSE DIFFICULTIES ENCOUNTERED, WHICH COULD, HAVE BEEN FORESEEN HAD SUCH AN EXAMINATION HAD BEEN MADE, WILL NOT BE RECOGNIZED.

CONNECTION TO EXISTING WORK:

- 1. PLAN INSTALLATION OF NEW WORK AND CONNECTIONS TO EXISTING WORK TO INSURE MINIMUM INTERFERENCE WITH REGULAR OPERATION OF EXISTING FACILITIES.
- 2. SUBMIT TO THE OWNER FOR APPROVAL, DATE SCHEDULE OF NECESSARY TEMPORARY SHUT-DOWN OF EXISTING SERVICES. ALL SHUT-DOWNS SHALL BE MADE AT SUCH TIMES AS WILL NOT INTERFERE WITH REGULAR OPERATING OF EXISTING FACILITIES AND ONLY AFTER WRITTEN APPROVAL OF OWNER.
- 3. TO INSURE CONTINUOUS OPERATION, MAKE NECESSARY TEMPORARY CONNECTIONS BETWEEN NEW AND EXISTING WORK.
- 4. CONNECT NEW WORK TO EXISTING WORK IN A NEAT AND APPROVED MANNER. RESTORE EXISTING WORK DISTURBED TO ORIGINAL CONDITION.



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Revisions

Drawing Title

GENERAL NOTES, PLUMBING ABBREVIATIONS & SYMBOLS




Drawn By RP

Checked By AK

CADD Plot Scale

P001

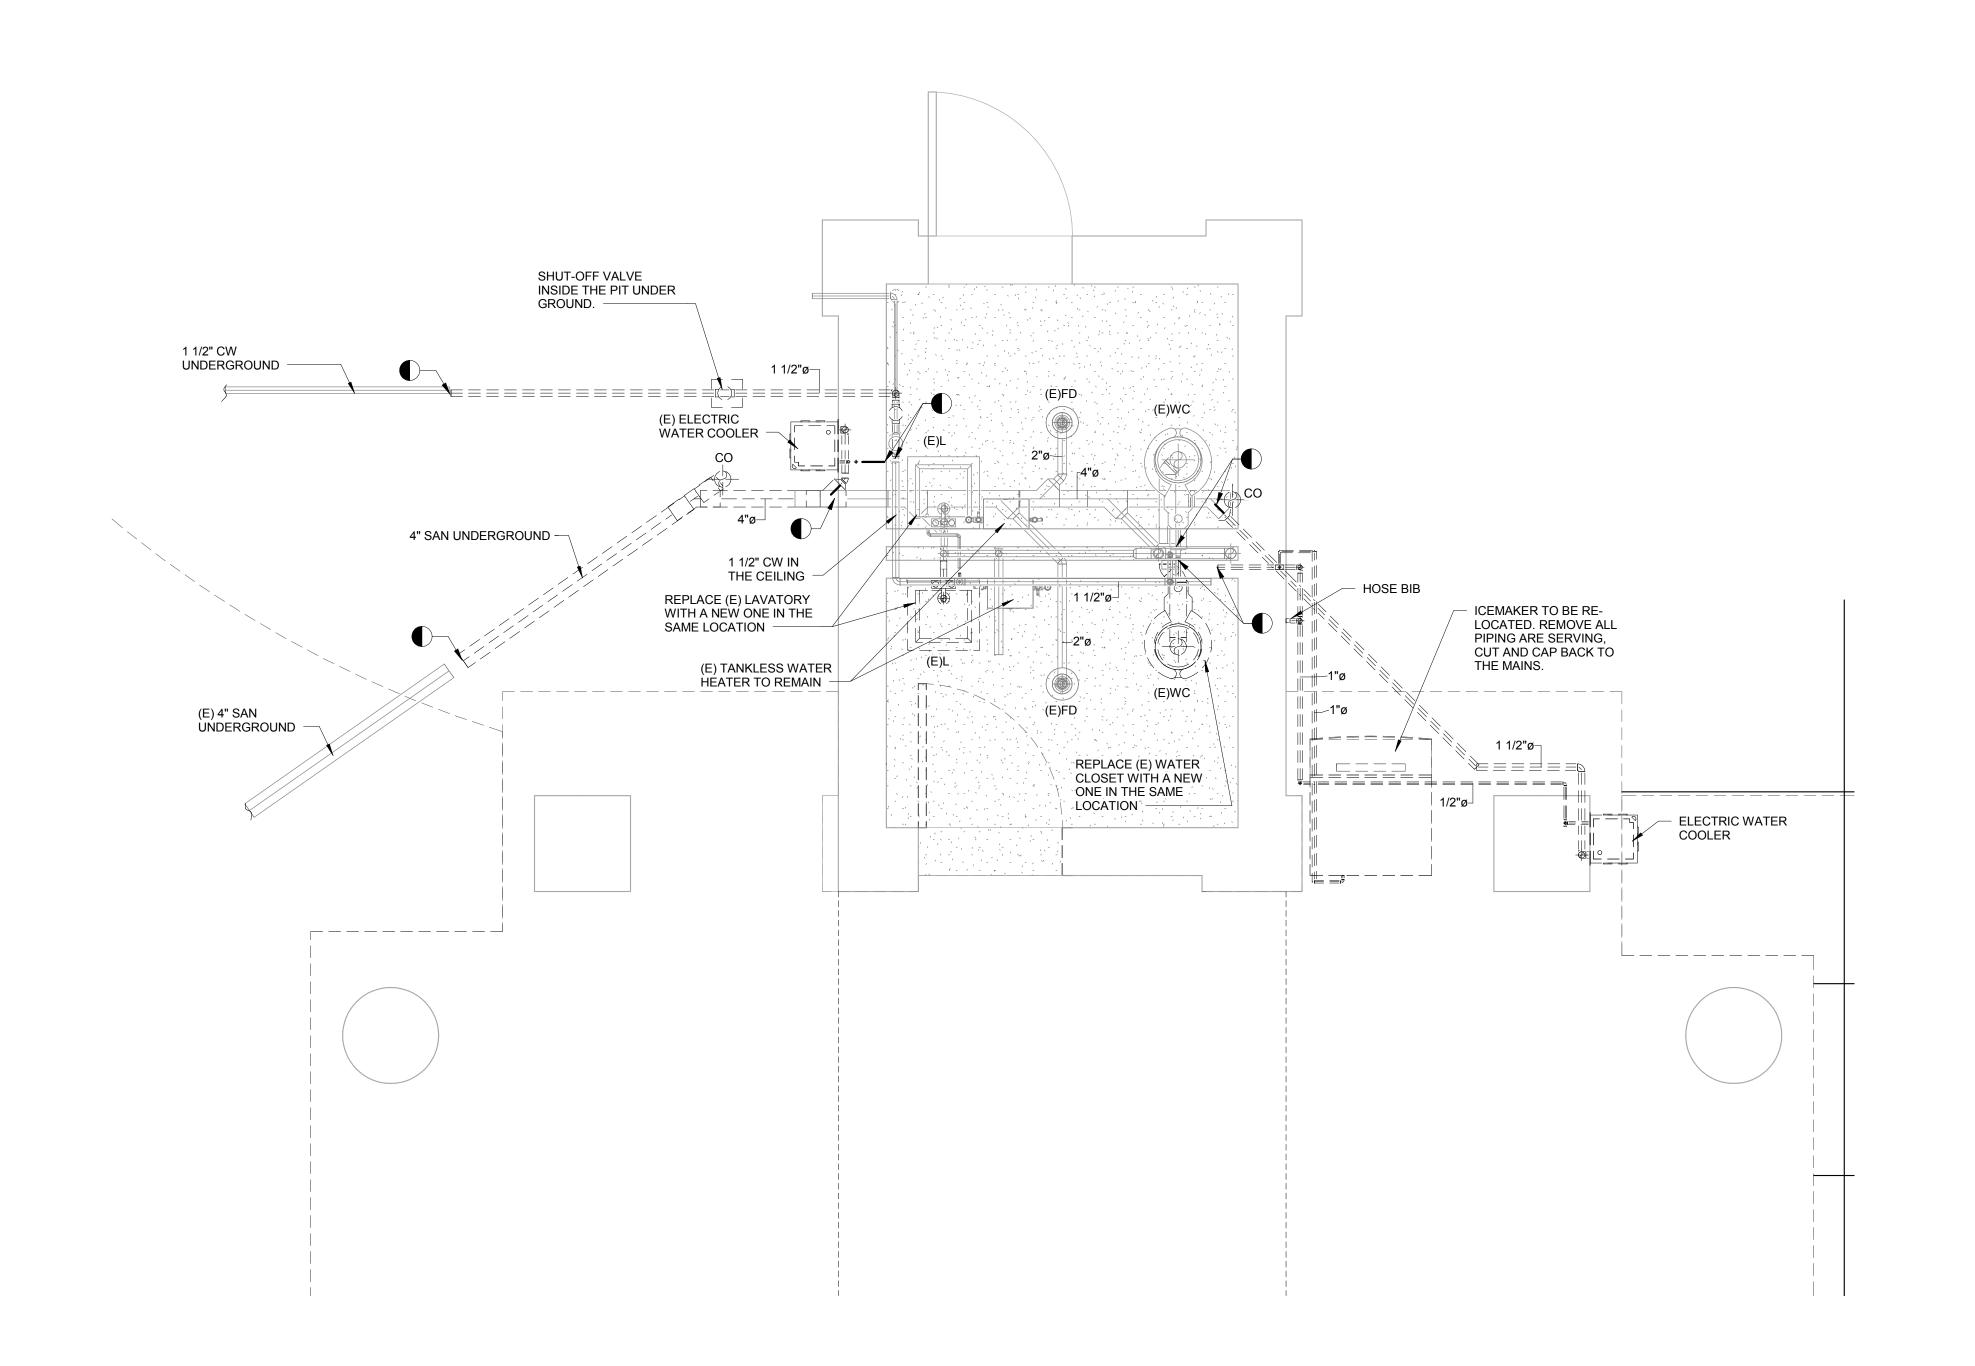

PLUMBING FLOOR PLAN-DEMOLITION



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PLUMBING FLOOR PLAN-DEMOLITION

CONCEPT 35% 60% 80% 100%


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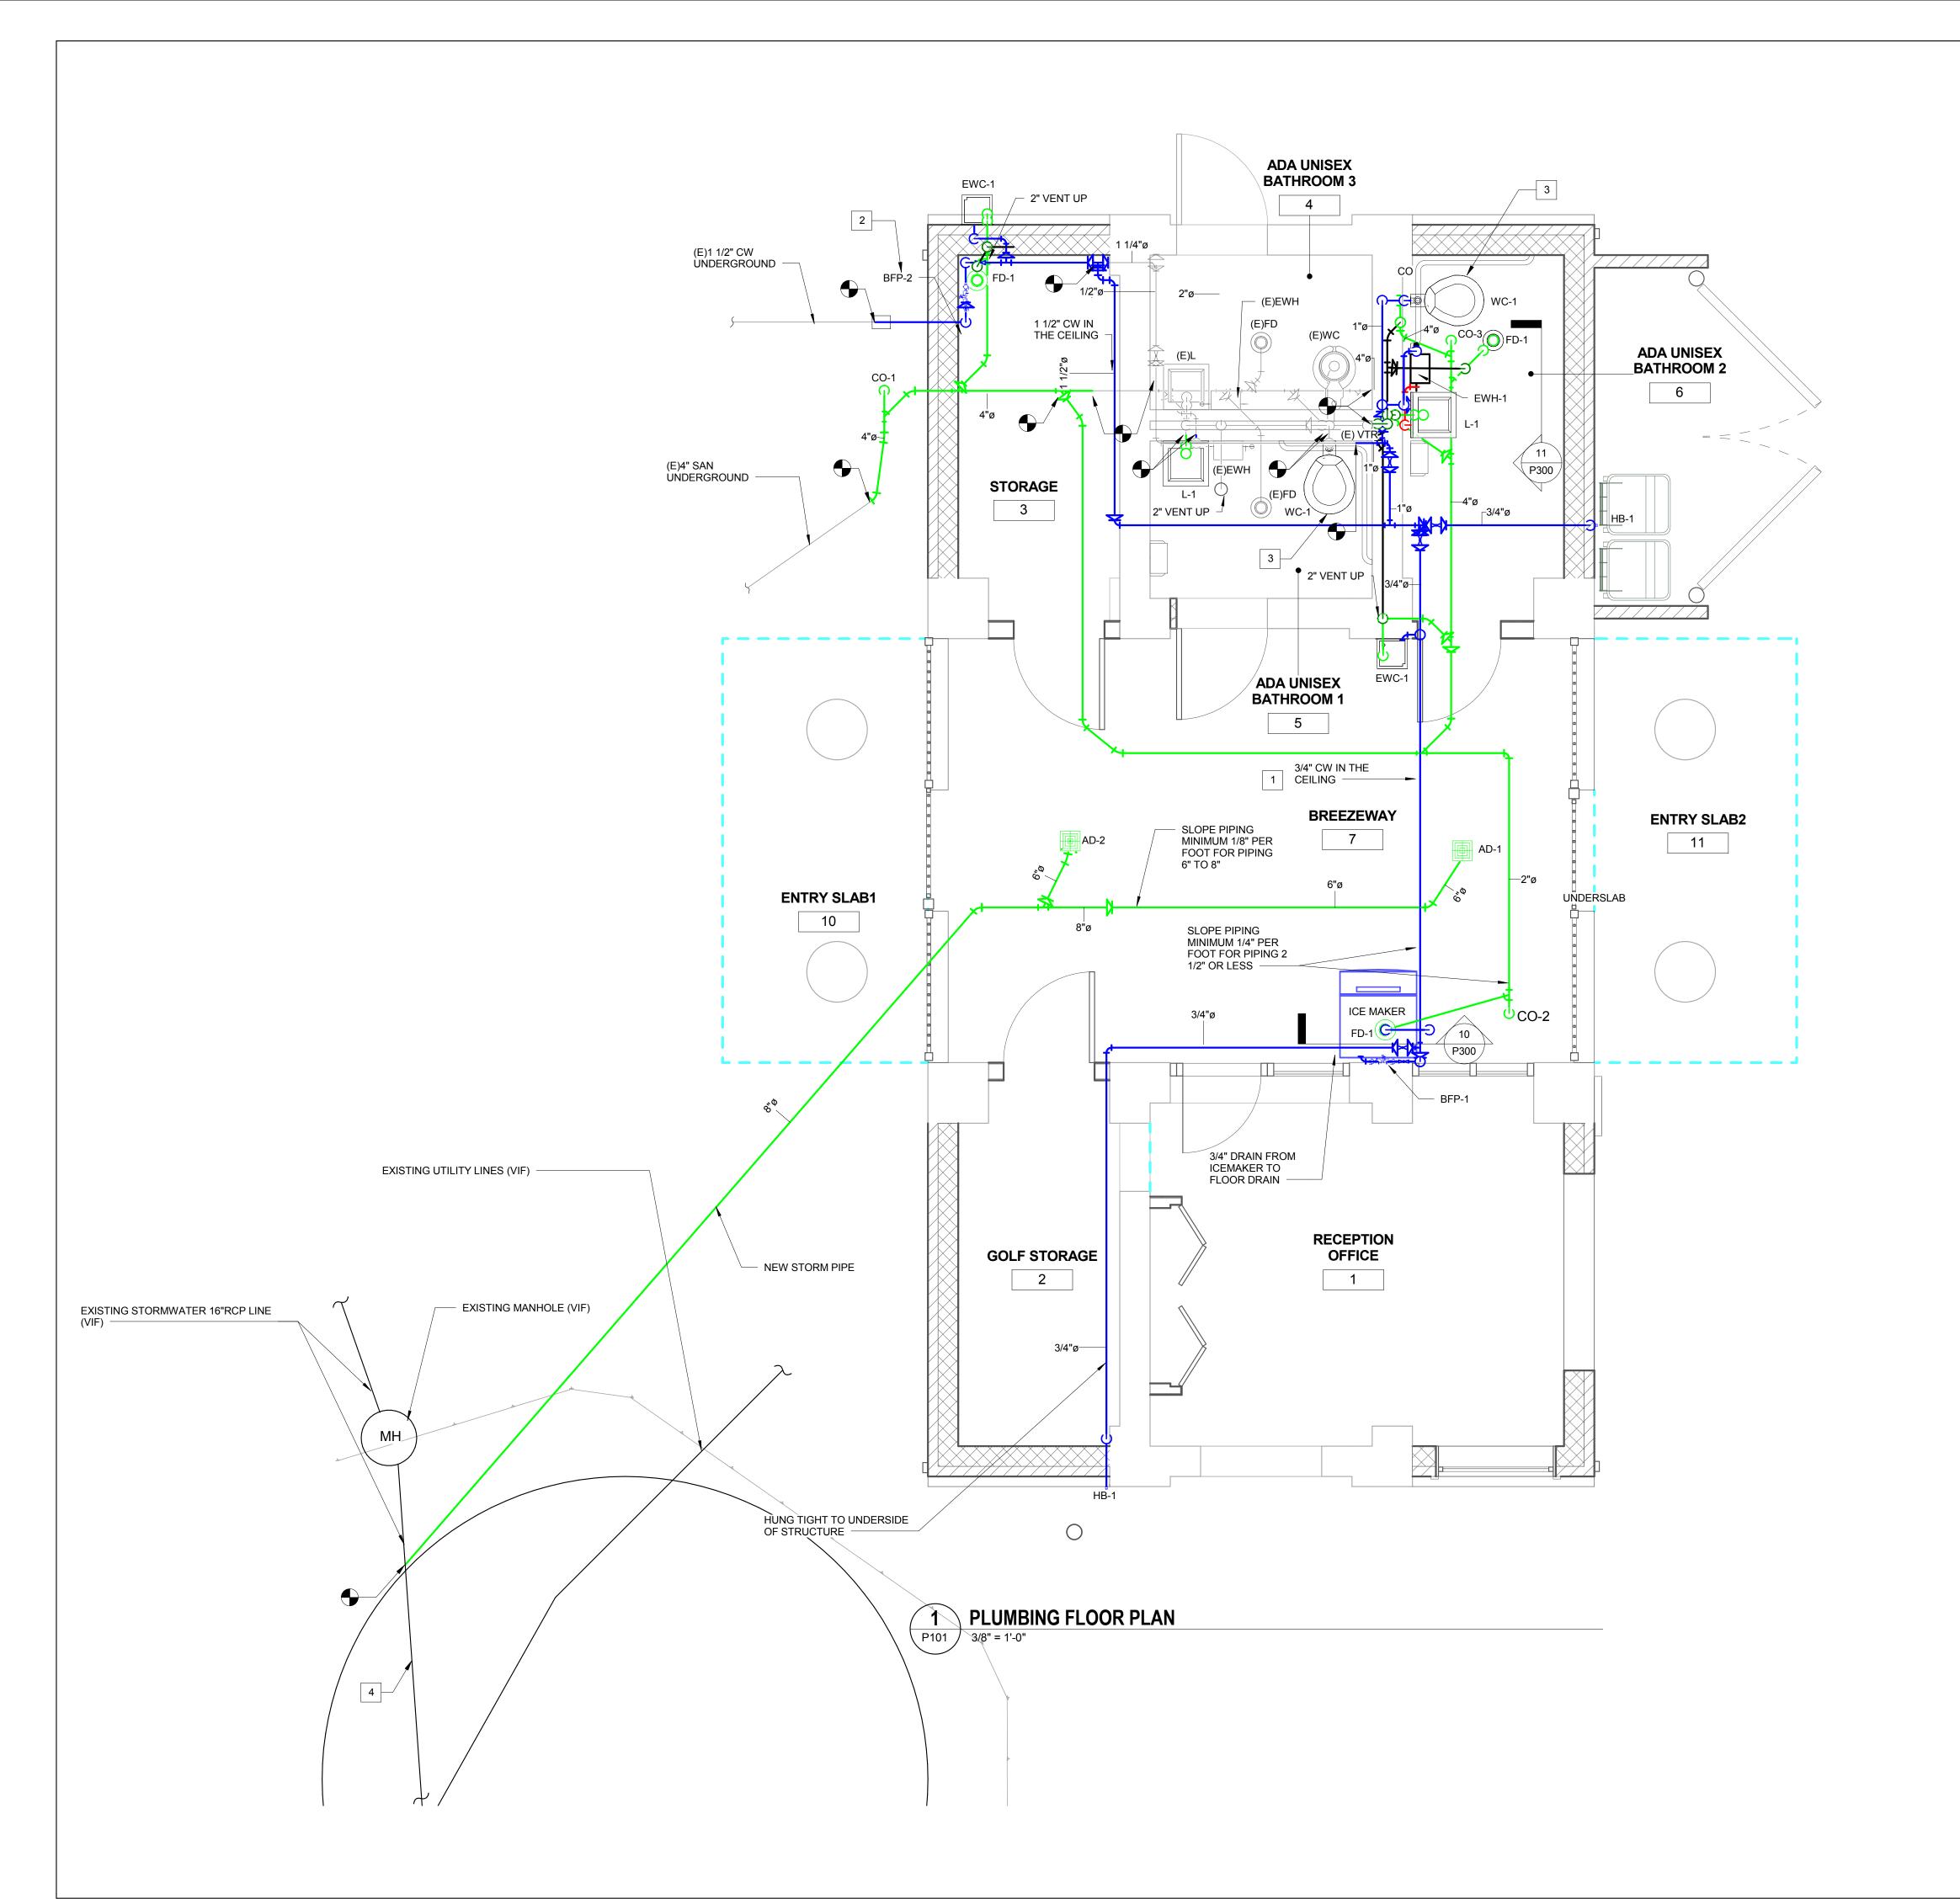
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Checked By AK P100







GENERAL NOTES

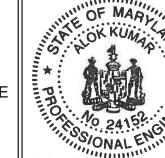1. CONTRACTOR SHALL FIELD VERIFY MATERIALS OF ALL EXISTING UNDERGROUND SANITARY AND STORM PIPING PRIOR TO BID TO ENSURE NO CHANGE ORDER AFTER PROJECT AWARD. REFER TO SPECS FOR ACCEPTABLE PIPING MATERIALS.

2. ALL PLUMBING FIXTURES AND PIPING SHALL BE SELECTED AND SUBMITTED TO AE FOR APPROVAL ONLY AFTER THEY HAVE BEEN APPROVED FOR BY COG. ALLOW ENOUGH TIME FOR THIS COORDINATION WITH COG.

DRAWING KEY NOTES

- 1. PROVIDE INSULATED PIPING W/ASJ HUNG TIGHT TO STRUCTURE
- PROVIDE ACCESSIBLE SHUT-OFF VALVE AND BFP ABOVE FLOOR. REFER TO DETAIL.
- PROVIDE NEW WATER CLOSET AND ASSOCIATED PIPING. CONNECT NEW SAN, CW AND VENT TO EXISTING PIPING IN CHASE WALL.
- 4. FIELD VERIFY SIZE AND MATERIAL OF EXISTING PIPING



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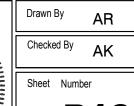
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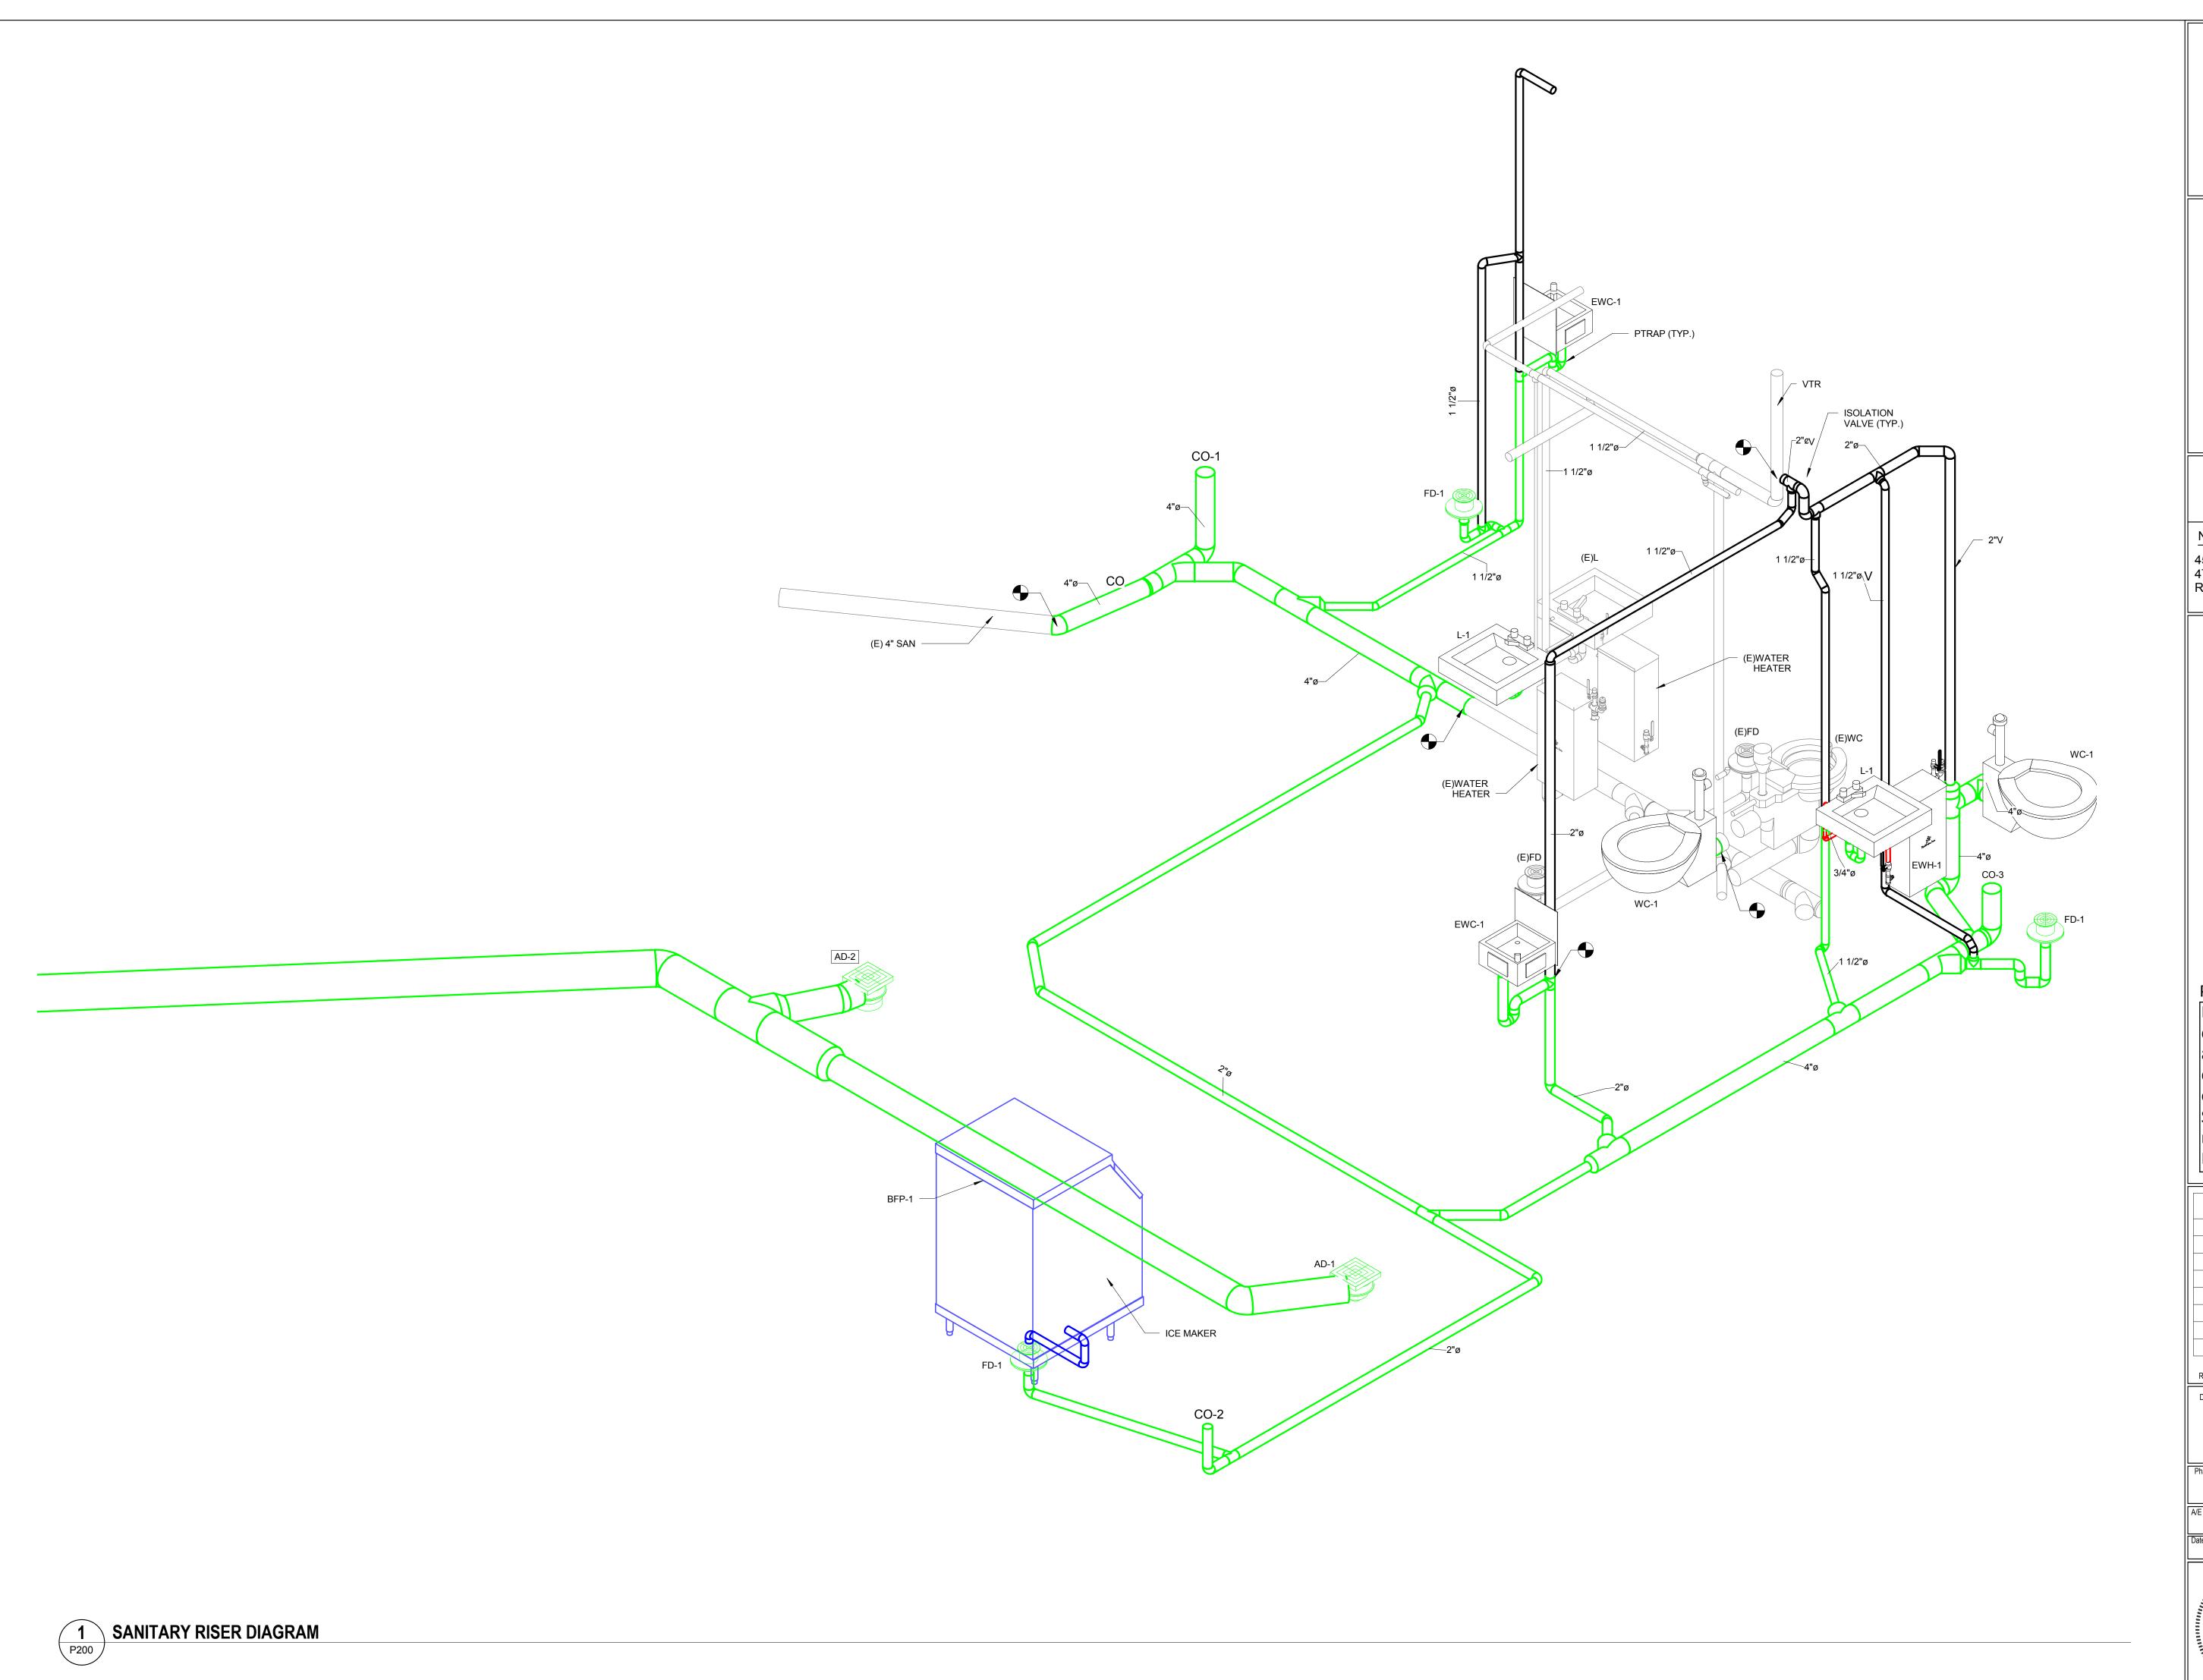
PLUMBING FLOOR PLAN

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Sheet Number P101





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SANITARY RISER DIAGRAM


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P200





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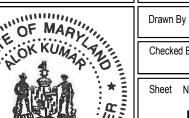
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DOMESTIC WATER RISER DIAGRAM


CONCEPT 35% 60% 80% 100%

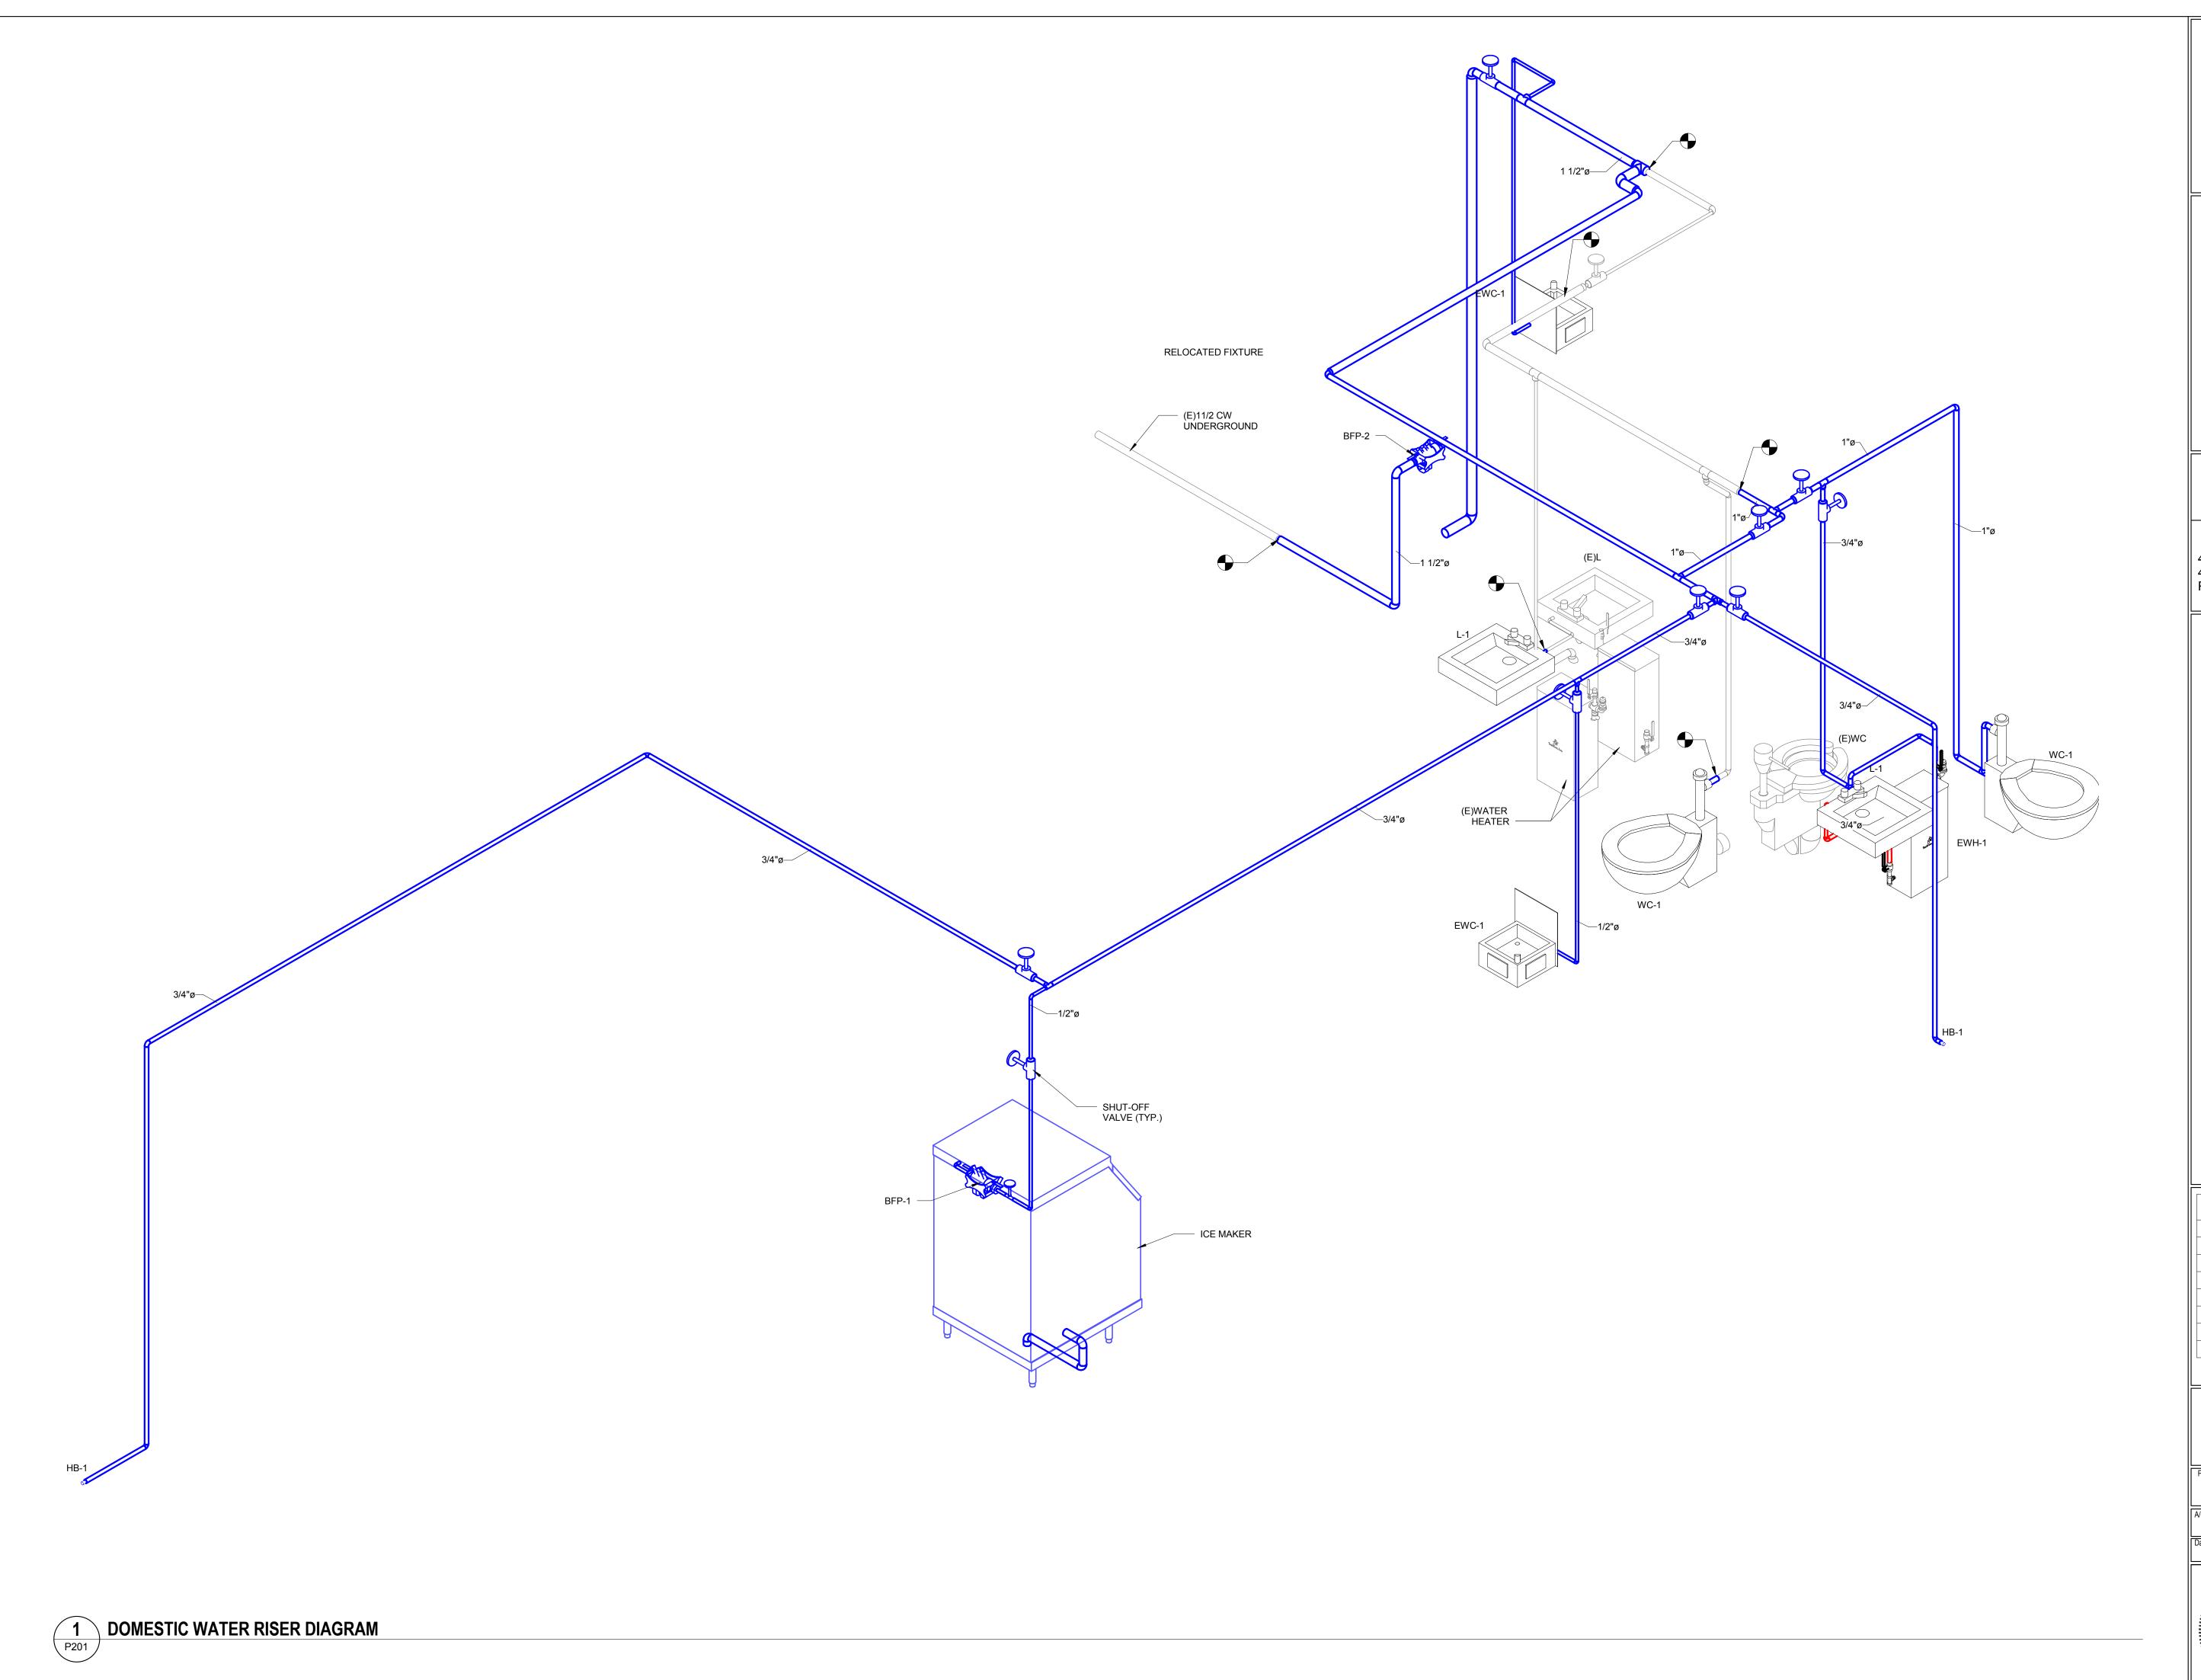12-0009.012 Date 06.30.2016	A/E Project Number
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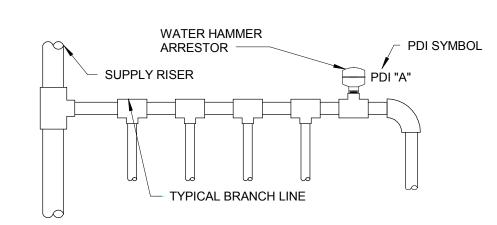
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P201



WATER HAM	MER ARRE	ESTOR SCHE	EDULE			
PDI SYMBOL	А	В	С	D	E	F
FIXTURE UNIT RATING	1-11	12-32	33-60	61-113	114-154	155-330

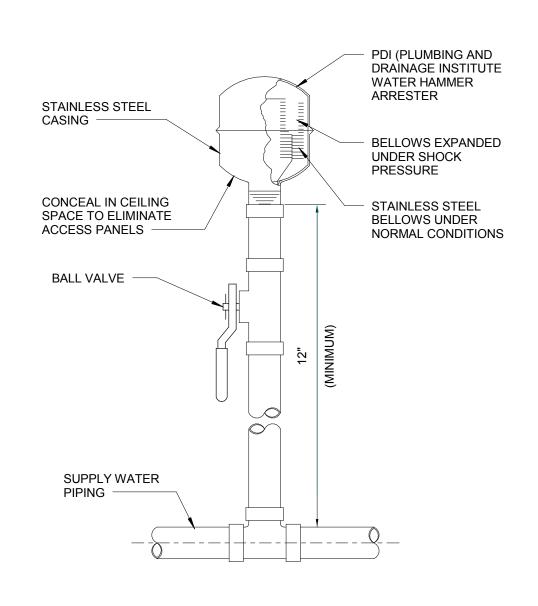


NOTES:

1. INSTALLATION OF WATER HAMMER ARRESTORS SHALL BE AT THE END OF BRANCH LINE BETWEEN THE LAST TWO FIXTURES SERVED.

2. ONE WATER HAMMER ARRESTOR PER 20' LINE, AND ANOTHER FOR BRANCHES OVER 20' IN LENGTH.

3. THE SUM OF FIXTURE UNIT RATING OF UNITS OVER 20' IN LENGTH SHALL BE EQUAL TO OR GREATER THAN THE DEMAND OF THE BRANCHES.

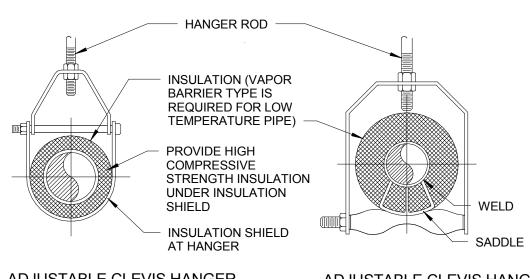

ADJUSTABLE CLEVIS HANGER SEE SPECIFICATIONS FOR MAX. <u>ADJUSTABLE CLEVIS HANGER</u> SEE SPECIFICATIONS FOR MAX **SUPPORT SPACING)** SUPPORT SPACING) 1/2" DIA. HANGER RODS WITH 36" MAX. SPACING PROVIDE INSULATION ON EACH CHANNEL SHIELD & INSERT FOR ALL PIPING (8" MIN.)

MAXIMUM PIPE/TUBING SUPPORT BRACING


NOM. SIZE IN. | THRU 3/4 | 1 | 1 1/4 | 1 1/2 | 2 | 2 1/2 | 3 | 4 | 5 | 6 | 8

NOTE: FOR TRAPEZE HANGER TAKE SPACING OF SMALLEST SIZE ON TRAPEZE

7 7 9 10 11 12 14 16 17 19

5 | 6 | 7 | 8 | 8 | 9 | 10 | 12 | 13 | 14 | 16

1-5/8" 12 GAUGE CHANNEL OR 2"x2"x1/4" NOTES: SEE SPECIFIER FOR DETAILED HANGER REQUIREMENTS

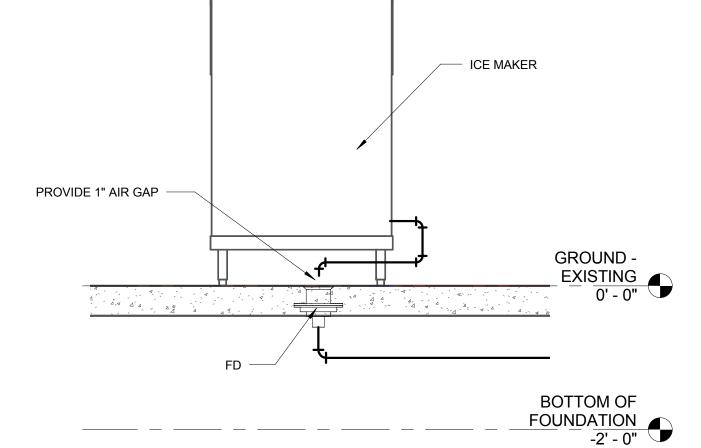



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SIDE VIEW TRAPEZE HANGER FOR UP TO 1000 LB. UNIFORM LOAD








PIPE FT.


TUBING FT.




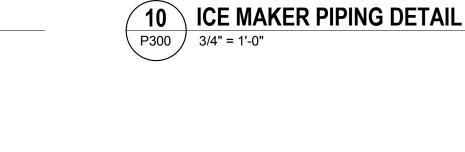


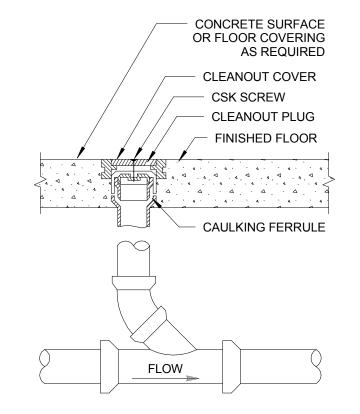

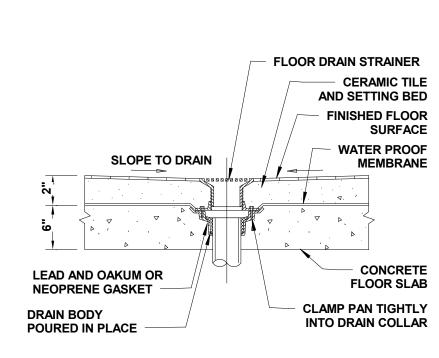

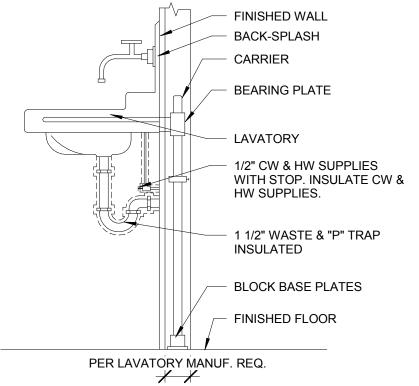

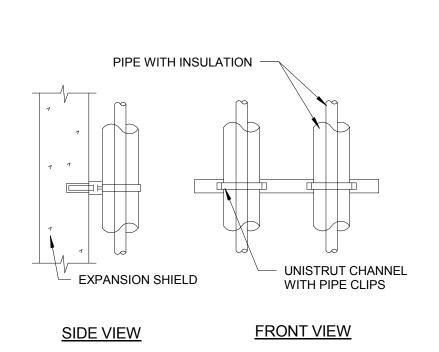

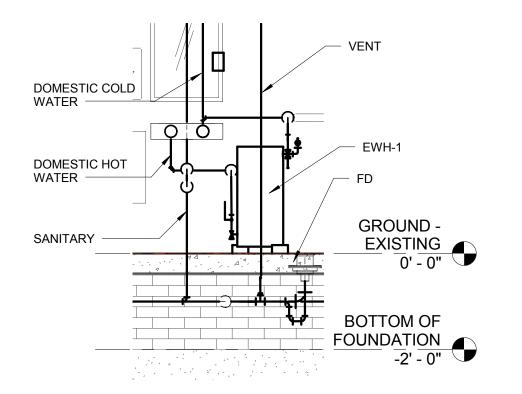


BATHROOM GROUP DETAIL P300 / 1/2" = 1'-0"











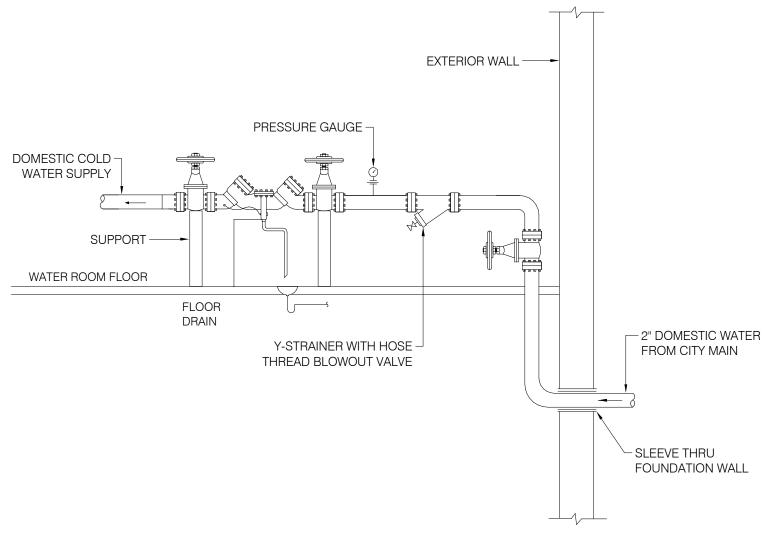

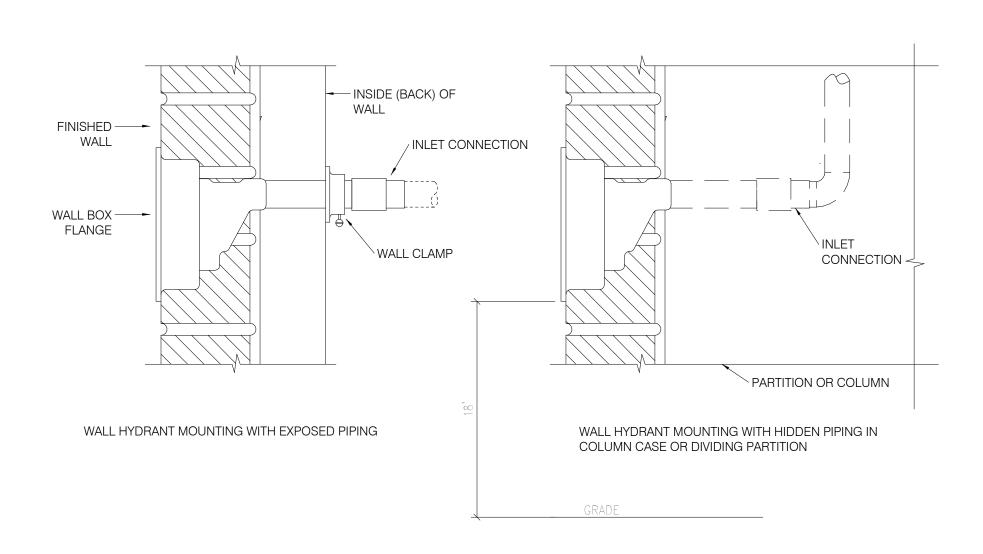

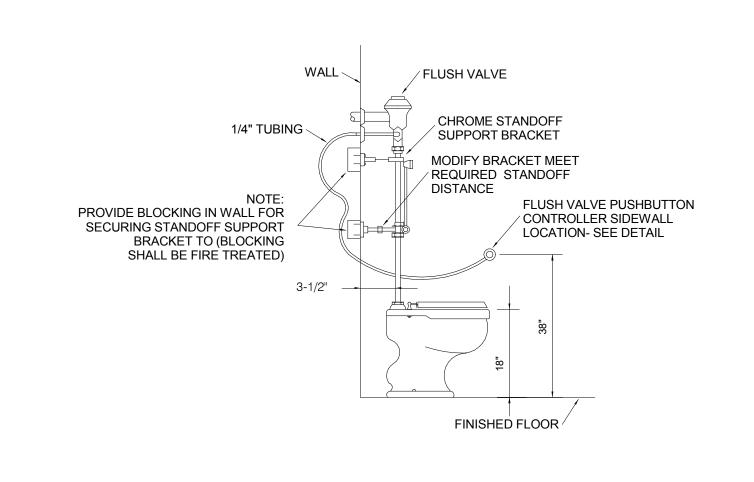

9 WATER CLOSET DETAIL
P300 NTS

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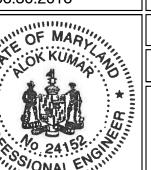
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PLUMBING - DETAILS

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Drawing Title

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Checked By AK Sheet Number **P300**

DOMESTIC WATER INCOMING SERVICE DETAIL P300 NTS

FREEZEPROOF WALL HYDRANT DETAIL P300 / NTS

		DOM	ESTIC	СНО	ΓWA	TEF	R HE	ATER SC	HEDULE	
TAG	TYPE	SERVICE	kW	VOLT	RIC PH	HZ		TEMP. RISE (°F)	TANK VOLUME (GALLONS)	BASIS OF DESIGN MANUFACTURER AND MODEL
EWH-1	ELECTRIC MINI TANK WATER HEATER	NEW TOILET ROOM	1.4	120	1	60	0.80	40	2.5	EEMAX MODEL EMT2.5 POINT OF USE WITH ADJUSTABLE TEMP. CONTROL 50-140 DEG F.

	PLUMBING FIXTURE SCHEDULE						
EQUIP. TAG	FIXTURE	WASTE	VENT	CW	HW	BASIS OF DESIGN	
WC-1	WATER CLOSET (ADA)	4"	2"	1"	-	FLOOR MOUNTED MANUAL FLUSH VALVE WITH 1.28 GPF. ADA. ACORA MODEL #R 2115 OR EQUAL	
L-1	LAVATORY (ADA)	1 1/2"	1 1/2"	1/2"	1/2"	STAINLESS STEEL SINKS WHLV-175-S, WALL MOUNTED, WITH SINGLE FAUCET HOLE FOR FAUCET AND ELECTRONIC PROXIMITY FAUCET WITH CAST SPOUT 2.0 GPM	
FD-1	FLOOR DRAIN	2"	1 1/2"	ı	-	ZURN LIGHT COMMERCIAL Z415B-P WITH STRAINER TRAP PRIMER CONNECTION	
AD-1	AREA DRAIN	6"	-	-	-	HEAVY DUTY NICKEL BRONZE JAY R SMITH MODEL 2295 W/SEDIMENT BUCKET	
HB-1	HOSE BIB	-	-	3/4"	-	WATTS SERIES FHB OR EQUAL	
EWC-1	ELECTRIC WATER COOLER (ADA)	2"	1 1/2"	1/2"	-	OASIS MODEL BARRIER FREE, 1/5 HP, 340 W, 1 PH. MODULAR M8SBPM OR EQUAL	
CO-1	CLEANOUT - PVC					JOSAM SERIES CO-430 PVC CLEANOUT	
CO-2 CO-3	CLEANOUT - CAST IRON					JOSAM 55000 SERIES COATED CAST IRON KLEENATRON® II LEVELEZE® FLOOR CLEANOUT	

BACKFLOW PREVENTER SCHEDULE						
TAG	DESCRIPTION	SIZE	CAPACITY	BASIS OF DESIGN MANUFACTURER AND MODEL		
BFP-1	BACKFLOW PREVENTER	1/2"	5 GPM @ 11 PSI	WATTS MODEL LF007 DUAL CHECK VALVE STYLE (ASSE 1024 COMPLIANT)		
BFP-2	BACKFLOW PREVENTER	1 1/2"	48 GPM @ 15 PSI	REDUCED PRESSURE ZONE ASSEMBLY MODEL WATTS SERIES 009 OR EQUAL		



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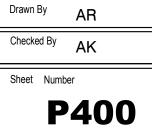
PLUMBING SCHEDULES

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IT SHALL BE THE CONTRACTOR'S RESPONSIBILITY TO COORDINATE THE STRUCTURAL DRAWINGS AND THEIR DIMENSIONS WITH OTHER DRAWINGS AND IF A CONFLICT EXISTS, HE SHALL NOT CARRY OUT THE AFFECTED WORK UNTIL THE ARCHITECT HAS ALL WORK SHALL CONFORM TO THE AISC "SPECIFICATION FOR THE DESIGN. FABRICATION AND ERECTION OF STRUCTURAL STEEL FOR BUILDINGS", AND THE ACI-531 "BUILDING CODE REQUIREMENTS FOR CONCRETE MASONRY STRUCTURES" LATEST EDITIONS. THE DESIGN LOADS ARE AS RECOMMENDED BY THE BUILDING OFFICIALS AND CODE ADMINISTRATORS NATIONAL BUILDING CODE ALL PIERS AND FOOTINGS ARE CENTERED ON COLUMNS UNLESS OTHERWISE INDICATED ON PLAN. DO NOT SCALE FROM DRAWINGS. ALL DIMENSIONS SHALL BE READ OR COMPUTED ALL OPENINGS SHOWN ON PLAN AND/OR SECTIONS SHALL BE VERIFIED WITH THE OTHER CONTRACT DOCUMENTS. OPENINGS NOT SHOWN ON STRUCTURAL DRAWINGS SHALL BE INSTALLED ONLY AFTER THE APPROVAL OF THE ENGINEER CONTRACTORS SHALL VERIFY DIMENSIONS AND LOCATIONS OF ALL SLOTS, PIPE SLEEVES, HANGERS, CHASES, ANCHOR BOLTS ETC., REQUIRED FOR MECHANICAL TRADES BEFORE CONCRETE IS POURED. ALL CONCRETE TO HAVE 3,000 PSI COMPRESSIVE STRENGTH AT 28 DAYS UNLESS OTHERWISE NOTED. ALL CONCRETE, EXCEPT FOOTINGS, SHALL CONTAIN AN APPROVED AIR-ENTRAINING ADMIXTURE THE LOCATION OF ALL ISOLATION, CONTROL AND CONSTRUCTION JOINTS NOT SHOWN ON THE DRAWINGS SHALL BE SUBMITTED TO THE ENGINEER FOR APPROVAL. **MASONRY UNITS** CONCRETE MASONRY UNITS IN BEARING WALLS SHALL CONFORM TO THE APPLICABLE ASTM STANDARDS AS INDICATED IN THE PROJECT SPECIFICATIONS. LOAD BEARING CONCRETE MASONRY UNITS SHALL HAVE A MINIMUM 28 DAY NET COMPRESSIVE STRENGTH OF 2000 PSI WITH A MINIMUM f'm = 1350 PSI. ALL MORTAR TO BE TYPE S MORTAR. ALL GROUT TO BE "EMBECO" NON-SHRINK GROUT (FC = 5,000 PSI) OR EQUAL PROVIDE DUR-O-WALL OR EQUAL JOINT REINFORCEMENT EVERY BLOCK COURSE BELOW GRADE AND EVERY OTHER BLOCK COURSE ABOVE GRADE IN ALL MASONRY WALLS UNLESS NOTED OTHERWISE THE BEARING COURSE UNDER ALL CONCENTRATED LOADS SHALL BE 100% SOLID MASONRY. THE SOLID MASONRY SHALL CONSIST OF 100% SOLID UNITS OR HOLLOW BLOCK GROUTED SOLID AT LEAST (3) COURSES WIDE BY (2) COURSES DEEP UNLESS NOTED OTHERWISE ON THE DRAWINGS. WHERE CHANGES IN MASONRY UNIT TYPES OCCUR, OR AT ANY INCREASE OR DECREASE IN WALL THICKNESS, THE BLOCK COURSE BELOW SHALL BE 100% SOLID. REINFORCING STEEL REINFORCING STEEL SHALL CONFORM TO ASTM A-615, GRADE 60, FY= 60,000 PSI. WELDED WIRE FABRIC SHALL CONFORM TO ASTM A-185. WELDED WIRE FABRIC SHALL BE FURNISHED IN MATS. LAP EDGES OF WELDED WIRE FABRIC AT LEAST 10" IN EACH DIRECTION. MINIMUM CONCRETE COVER FOR CAST-IN-PLACE CONCRETE SHALL BE PROVIDED FOR REINFORCEMENT AS FOLLOWS CONCRETE CAST AGAINST AND PERMANENTLY EXPOSED TO EARTH...3" CONCRETE EXPOSED TO EARTH OR WEATHER #6 THROUGH #18 BARS...2" #5 BAR AND SMALLER...1 1/2" CONCRETE NOT EXPOSED TO WEATHER OR IN CONTACT WITH GROUND SLABS, WALLS, JOISTS: #11 BAR AND SMALLER...3/4" BEAMS, COLUMNS: PRIMARY REINFORCEMENT, TIES, STIRRUPS, SPIRALS...1 1/2 1. UNLESS OTHERWISE INDICATED, PROVIDE LOOSE ANGLE LINTELS AS FOLLOWS, WITH ONE ANGLE FOR EACH 4" OF MASONRY WITH THE 3 – 1/2" LEG HORIZONTAL OPENINGS TO 3' - 0" ... 3 - ½" X 3 - ½" X ¼" ANGLE OPENINGS FROM 3' - 1" TO 5' - 0"... 4" X 3 - 1/2" X 5/16" ANGLE OPENINGS FROM 5' - 1" TO 6' - 0"... 5" X 3 - 1/2" X 3/8" ANGLE ALL ANGLES TO HAVE 8 INCH MINIMUM BEARING. PRECAST LINTELS FOR OPENINGS UP TO 6' - 0" SHALL BE OF SAME TEXTURE AS ADJOINING MASONRY AND SHALL BE AS FOLLOWS UNLESS OTHERWISE NOTED. 4" WALLS... 4 X 8 REINFORCED WITH (1) - #4 TOP AND BOTTOM 6" WALLS... 6 X 8 REINFORCED WITH (1) - #4 TOP AND BOTTOM 8" WALLS... 8 X 8 REINFORCED WITH (2) - #4 TOP AND BOTTOM 12" WALLS... 12 X 8 REINFORCED WITH (2) - #4 TOP AND BOTTOM 4. ALL PRECAST LINTELS TO HAVE 8 INCH MINIMUM BEARING. ATTACHMENTS, MODIFICATIONS TO STRUCTURE AND MISCELLANEOUS NO HOLES ARE TO BE CUT OR DRILLED IN STRUCTURAL MEMBERS IN THE FIELD UNLESS APPROVED BY THE ENGINEER AND UNLESS SPECIFICALLY DIRECTED BY NOTES AND DETAILS ON THE STRUCTURAL DRAWINGS. PROVIDE STRUCTURE, SUPPORTS, BRACES, ETC. AS REQUIRED FOR THE INSTALLATION OF ALL TYPES OF EQUIPMENT INSTALLATION TO BE AS SHOWN ON THE STRUCTURAL DRAWINGS OR IF NOT SHOWN, THEN SUBJECT TO THE APPROVAL OF THE ENGINEER. STRUCTURE SPECIALLY REQUIRED FOR SUPPORT OF EQUIPMENT SHALL BE LOCATED AND INSTALLED AS REQUIRED SUBJECT OT THE ENGINEER'S APPROVAL. **ROOF FRAMING** LIVE LOADS: ROOF = 30 PSF WOOD FRAMING MEMBERS SHALL HAVE STRUCTURAL PROPERTIES (AS A MIN.) EQUIVALENT TO THOSE OF NO. 2 SOUTHERN PINE (SURFACE DRY) 19% M.C. AS DEFINED BY THE NDS 1986 WITH A Fb = 1200 PSI, Fv = 90 PSI, E = 1.6 X 106 PSI. PLYWOOD ROOF SHEATHING SHALL BE 3/4 INCH THICK, WITH TONGUE AND GROOVE EDGES, AND ALSO ½ INCH THICK, WITH ONE PANEL EDGE CLIP BETWEEN EACH SUPPORT, AS SPECIFIED ON THE ROOF FRAMING PLAN. REFER TO THE PROJECT SPECIFICATIONS FOR MATERIAL AND FASTENING CRITERIA. UNLESS NOTED OTHERWISE, ALL TIMBER NAILING WILL BE DONE IN ACCORDANCE WITH APPENDIX C - BOCA BASIC BUILDING CODE, A COPY OF WHICH SHALL BE ON THE SITE AT ALL TIMES. ALL ROOF TRUSS AND RAFTER CONNECTIONS SHALL BE MADE WITH TECO OR SIMPSON STRONG TIE STRUCTURAL WOOD FASTENERS AS SPECIFIED ON THE STRUCTURAL DRAWINGS. ALL WOOD MEMBERS TO BE PROTECTED AGAINST DECAY AND INSECT INFESTATION, WHERE REQUIRED, WITH APPROVED TREATMENT AND AS CALLED FOR UNDER THE PROVISIONS OF SECTION 1712.0 BOCA 1987. ROOF TRUSS SHOP DRAWINGS SHALL BE FURNISHED BY THE MANUFACTURER AND SHALL INCLUDE CERTIFICATION BY A PROFESSIONAL ENGINEER REGISTERED IN MARYLAND. DESIGN AND GENERAL ARRANGEMENT ARE SUBJECT TO THE REVIEW OF THE ARCHITECT/ENGINEER. ROOF TRUSSES SHALL BE DESIGNED FOR THE FOLLOWING LOADS: TOP CHORD L.L. = 30 PSF BOTTOM CHORD D.L. = 5 PSF = 10 PSF = 5 PSF TOP CHORD D.L. MISC LOAD SNOW DRIFT LOAD OF 65 PSF AT THE EDGE OF THE MANSARD, TAPERING DOWN TO ZERO AT A DISTANCE OF 9' - 0". SNOW DRIFT LOAD IS IN ADDITION TO 30 PSF TOP CHORD LIVE LOAD (SNOW LOAD). DESIGN, FABRICATION AND INSTALLATION OF METAL PLATE CONNECTED TRUSSES SHALL BE IN ACCORDANCE WITH THE NATIONAL DESIGN SPECIFICATION FOR WOOD CONSTRUCTION (NFPA) AND THE SPECIFICATION FOR LIGHT METAL PLATE CONNECTED WOOD TRUSSES (TPI). STAGGER ROOF TRUSSES IN LINE THE MINIMUM AMOUNT REQUIRED IN ORDER TO PROVIDE FULL TRUSS BEARING ANY ATTACHMENT TO TRUSSES FOR SUPPORT OF ANY MATERIAL OTHER THAN SHEATHING SHOULD BE MADE AT CHORD PANEL POINTS AND BE APPROVED BY THE ENGINEER. IF ATTACHMENT AT CHORD PANEL POINT IS NOT POSSIBLE, PROVIDE ATTACHMENT SUBJECT TO THE ENGINEER'S APPROVAL.

12. EXTRA ROOF TRUSSES AND SPECIAL FRAMING HAVE BEEN INDICATED IN MOST CASES WHERE REQUIRED BY SPECIAL APPLICATIONS. LOCATIONS SHOWN ARE SCHEMATIC AND MUST BE VERIFIED BY THE TRUSS MANUFACTURER.

THE MAXIMUM SLOPE BETWEEN BOTTOMS OF ADJACENT FOOTINGS SHALL BE (2) HORIZONTAL TO (1) VERTICAL.

WHERE BACKFILL IS REQUIRED ON BOTH SIDES OF WALLS, BACKFILL BOTH SIDES SIMULTANEOUSLY.

SLAB ON GRADE CONTROL JOINTS SHALL BE LOCATED AS SHOWN ON PLAN.

THE TOP OF THE WALL THAN A DISTANCE EQUAL TO THE HEIGHT OF THE WALL.

THE FOUNDATION SYSTEM AND THE ALLOWABLE SOIL BEARING PRESSURE SHALL BE AS SPECIFIED ON THE FOUNDATION PLAN. FOOTINGS SHALL NOT BE CONSTRUCTED UNTIL THE SOIL IS APPROVED AS HAVING THE ASSUMED BEARING VALUE BY THE SOILS

WHERE MACHINERY USED FOR BACKFILL COULD DAMAGE THE WALL, THE WALL MUST BE ADEQUATELY BRACED DURING THE

ENTIRE BACKFILLING OPERATION, ALTERNATELY, HEAVY EQUIPMENT USED IN BACKFILLING SHOULD NOT APPROACH CLOSER TO

FOUNDATIONS

SUBSURFACE INVESTIGATION AND REPORT BY:

ALL BACKFILL SHALL BE CLEAN, POROUS MATERIAL


EARTH ENGINEERING & SCIENCES, INC.

3401 CARLINS PARK DRIVE

ENGINEER OR INSPECTOR.

(301) 466-1400

BALTIMORE, MARYLAND 21215

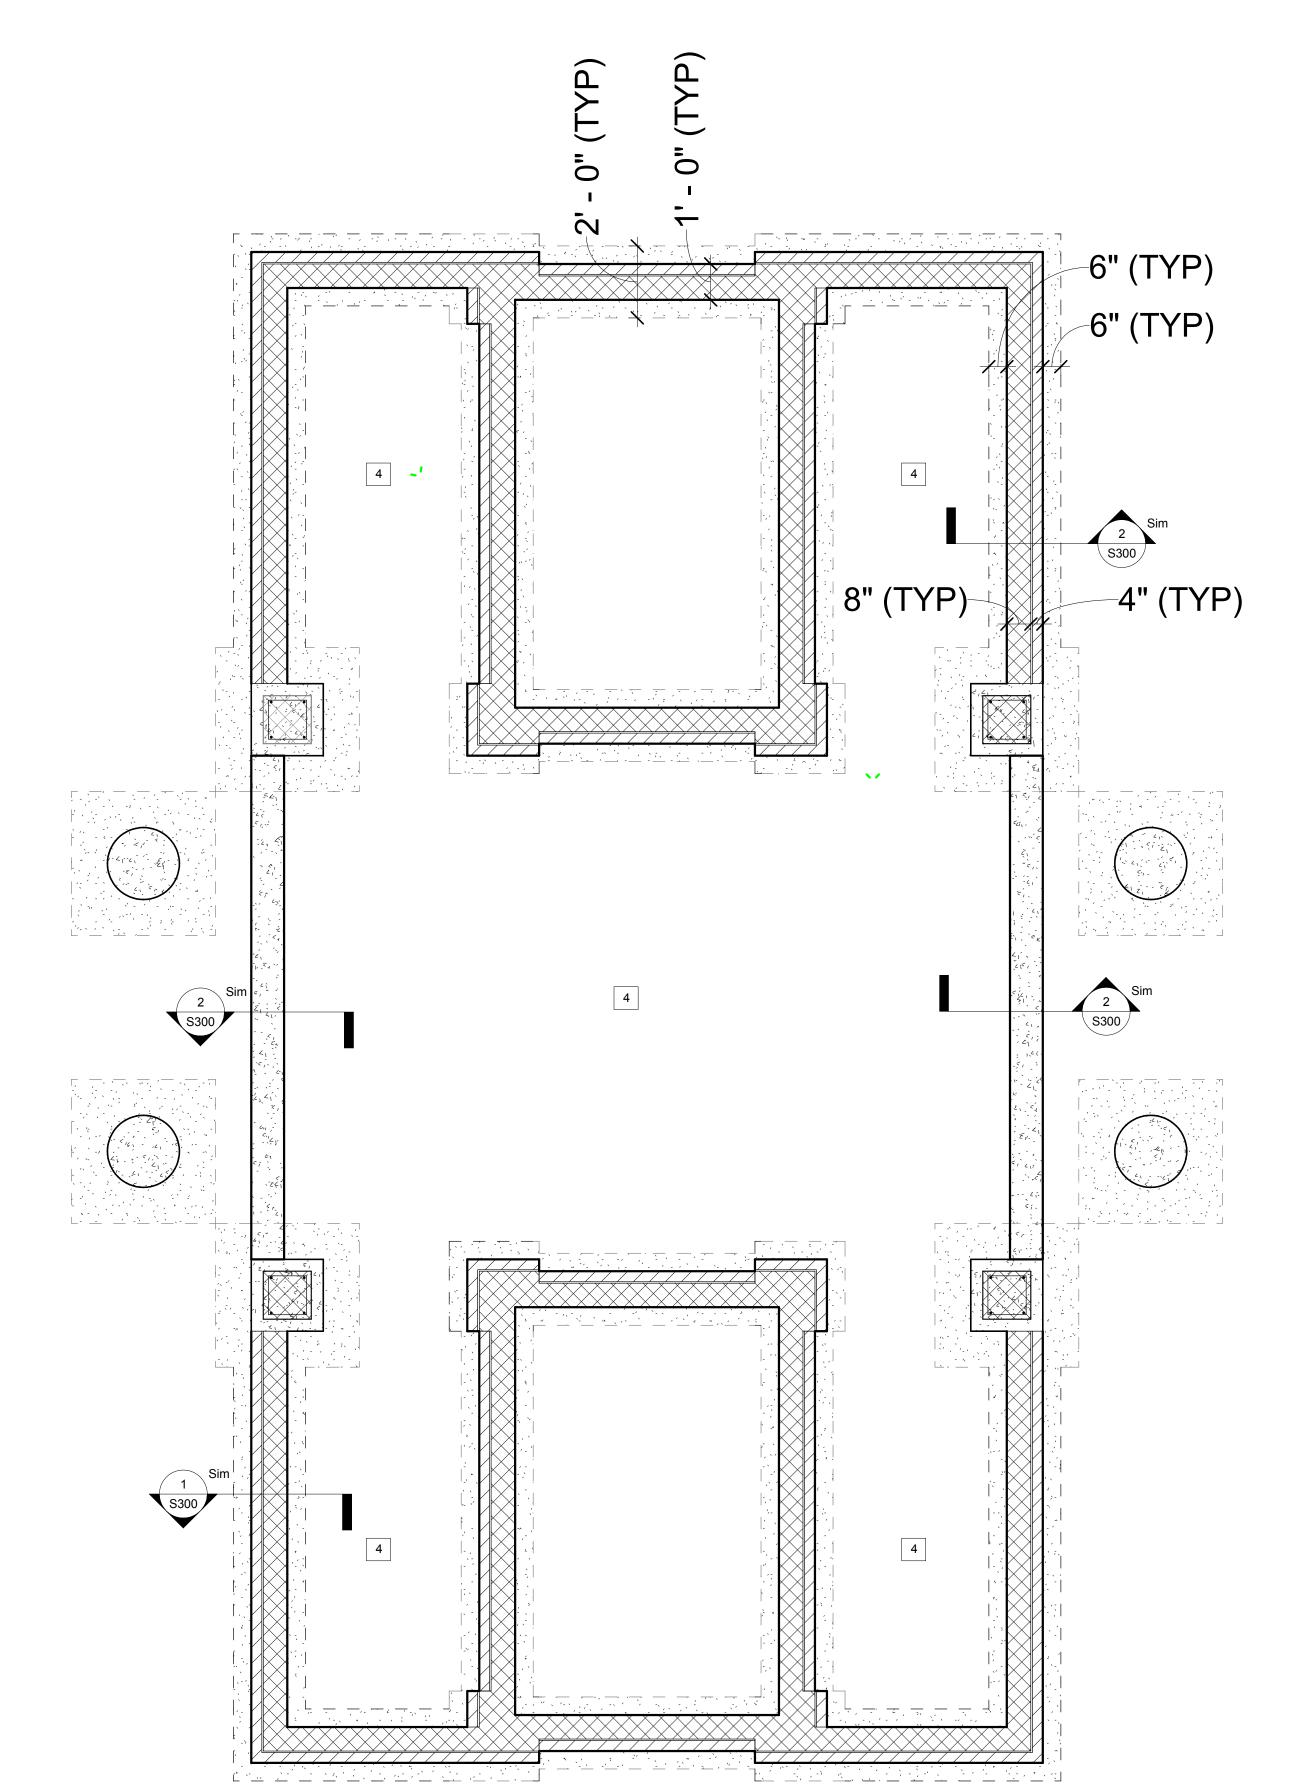

FOUNDATION PLAN NOTES:

- 1: TOP OF SLAB ELEVATION 0'-0"
- 2: ALLOWABLE SOIL BEARING PRESSURE: 2,000 PSF
- 3: TOP OF NEW WALL FOOTING TO MATCH ADJACENT EXISTING FOOTING
- 4: 4" CONCRETE SLAB ON GRADE REIN. W/ 6X6 - W1.4 X W1.4 WWF, PLACED 2" BELOW SURFACE ON VAPOR BARRIER ON COMPACTED EARTH TYP.
- 5: THE SPACING OF SAW-CUT JOINT FOR SLAB ON GRADE SHALL BE LESS THAN 14'-0"



MINIATURE GOLF PARK OFFICE BUILDING RENOVATION

514 S Frederick Ave, Gaithersburg, MD 20877



NIKA

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Professional Certification.

I certify that these documents were prepared or approved by me, and that I am a duly licensed architect under the laws of the State of Maryland, license number 15975, expiration date 10.16.2015

No.	Description	Date
1	REVISION # 1	06/30/2016
2	REVISION # 2	07/12/2016

Revisions

Drawing Title

STRUCTURAL - FLOOR PLAN

☐ CONCEPT ☐ 35% ☐ 60% ☐ 80% **☐** 100%

 A/E Project Number
 Drawing Scale: AS NOTED

 12-0009.012
 CADD Filename
 CADD Plot Scale

 06.30.2016
 Revit Model
 1:1

License #15975

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Checked By AV

Sheet Number


\$100

Drawn By

1 FOUNDATION PLAN - PROPOSE \$100 3/8" = 1'-0"

1 FOUNDATION PLAN - PROPOSED

W

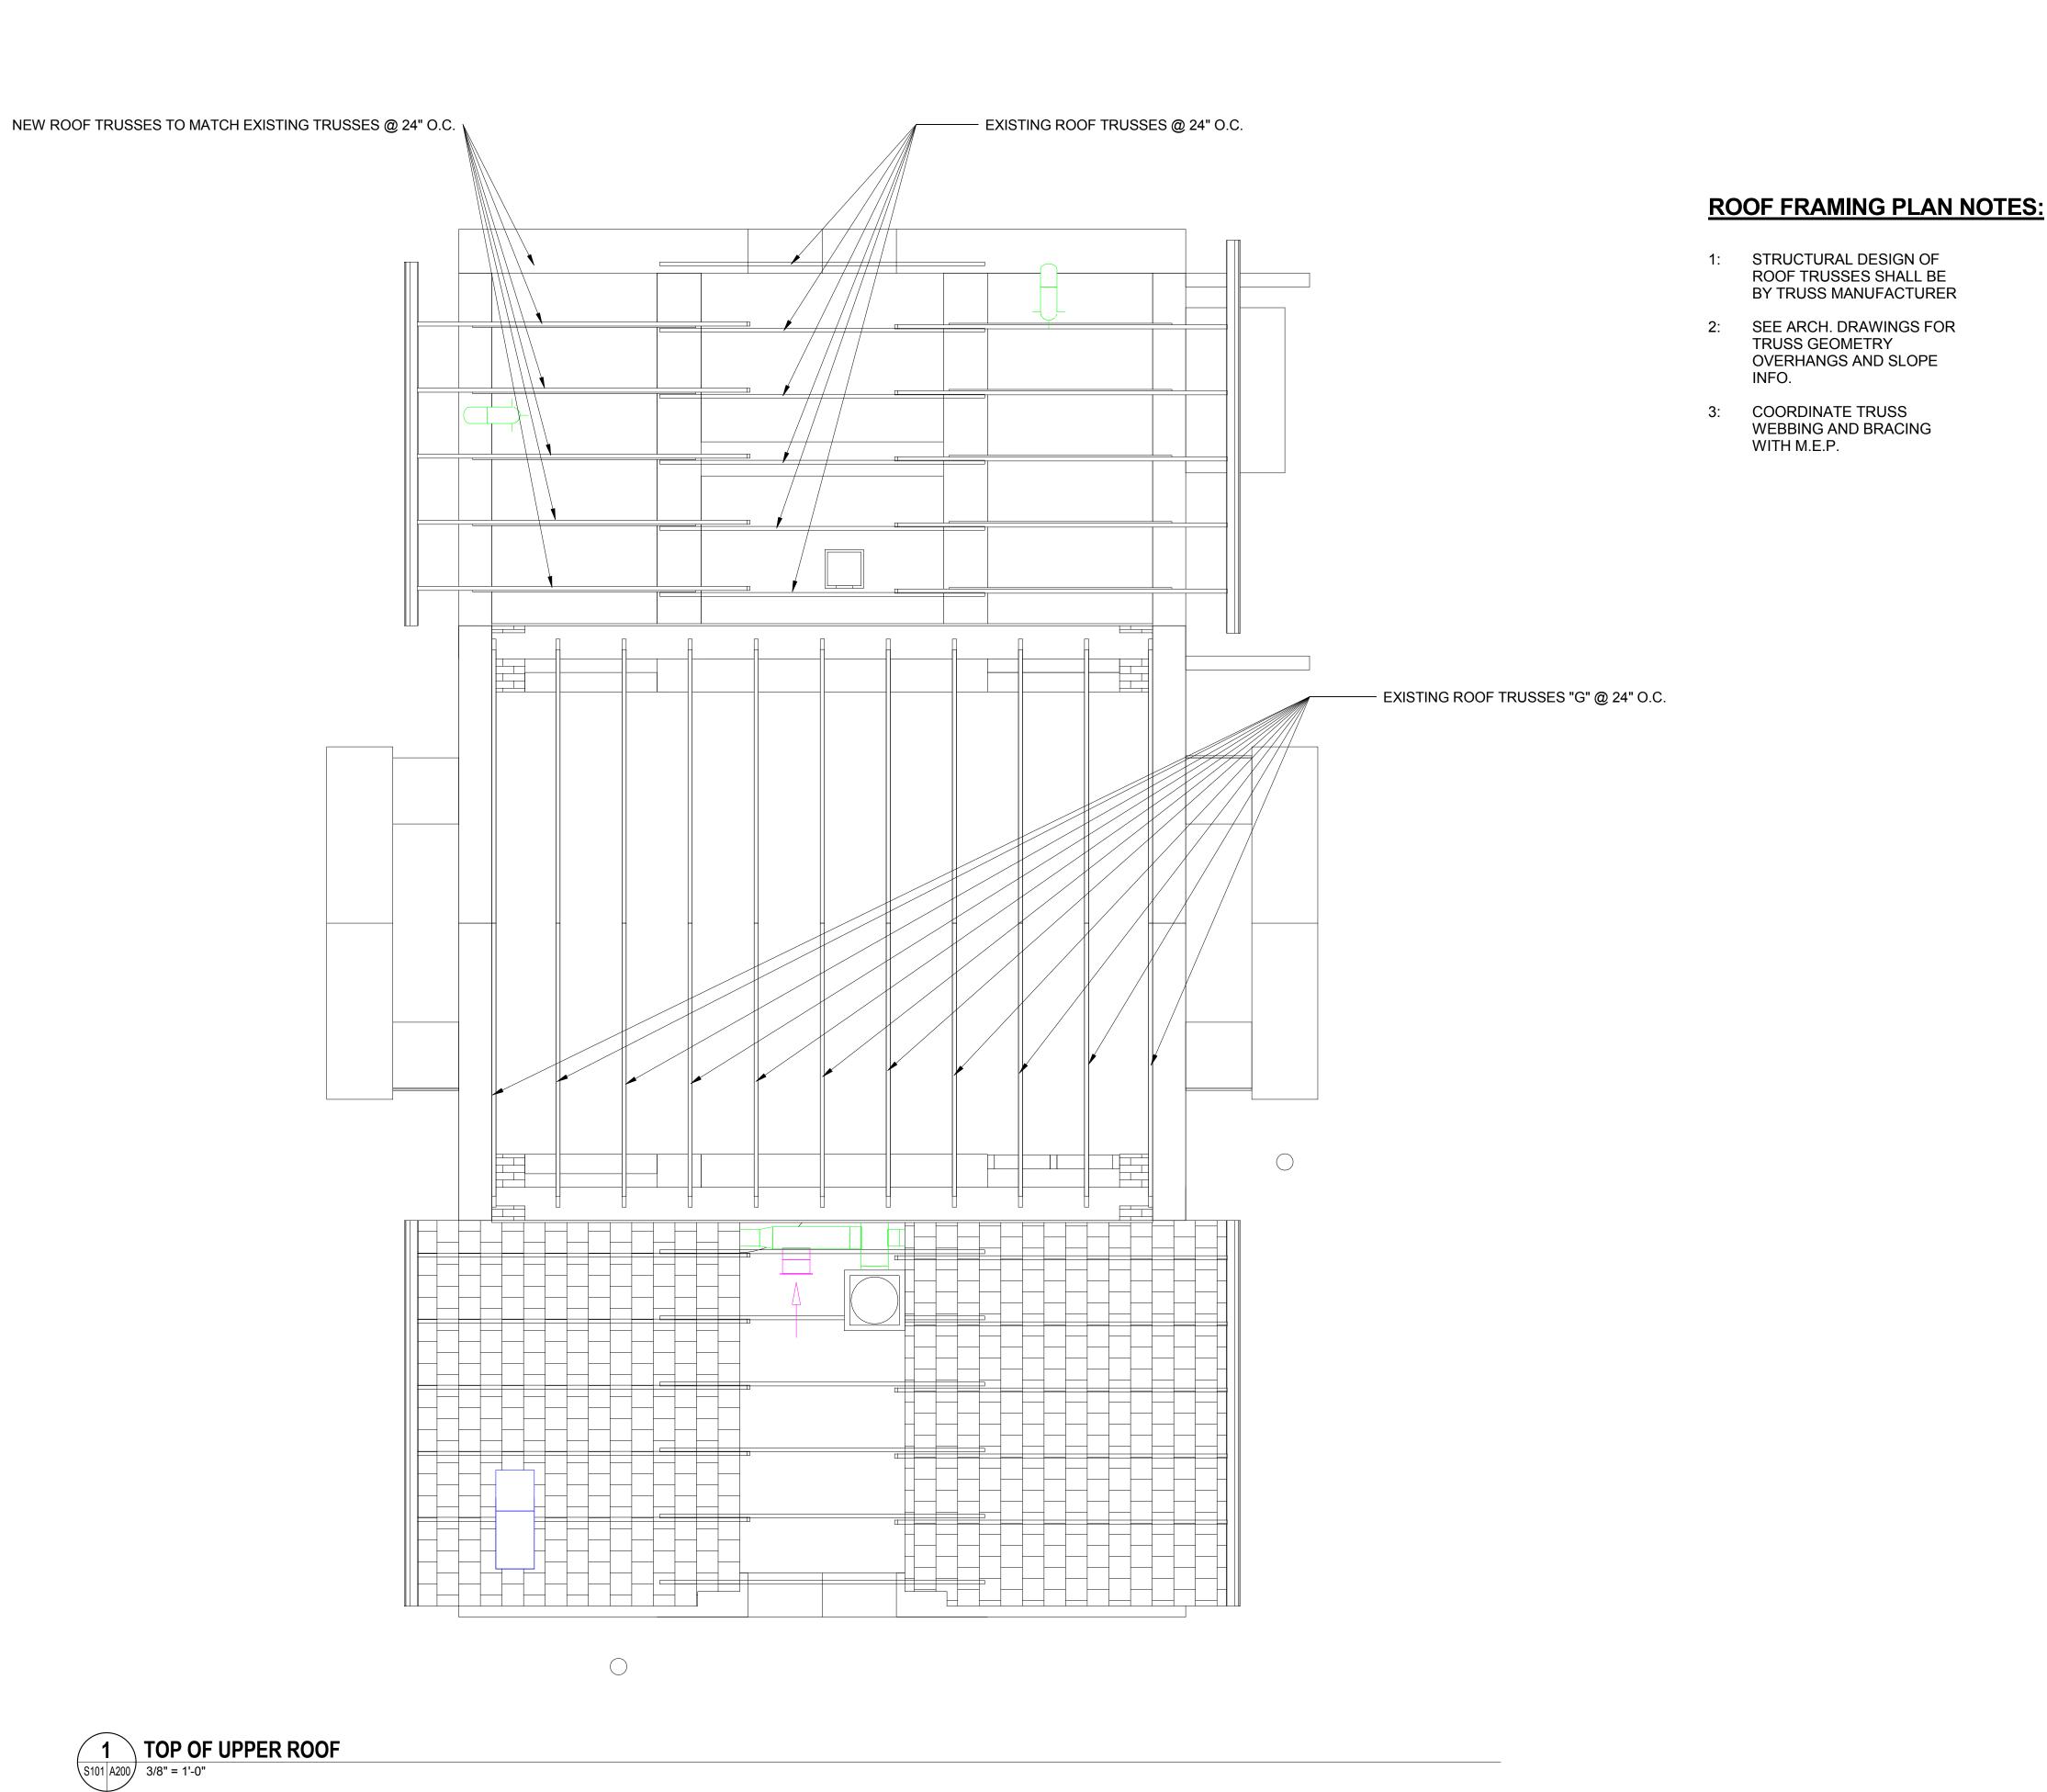



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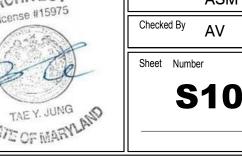
No.	Description	Date
1	REVISION # 1	06/30/2016
2	REVISION # 2	07/12/2016

STRUCTURAL ROOF PLAN


☐ CONCEPT ☐ 35% ☐ 60% ☐ 80% **☐** 100%

A/E Project Number 12-0009.012	Drawing Scale: AS NOTED		
Date 06.30.2016	CADD Filename CADD Plot Scale Revit Model 1:1		
WITECT	Drawn By A C M		





S101

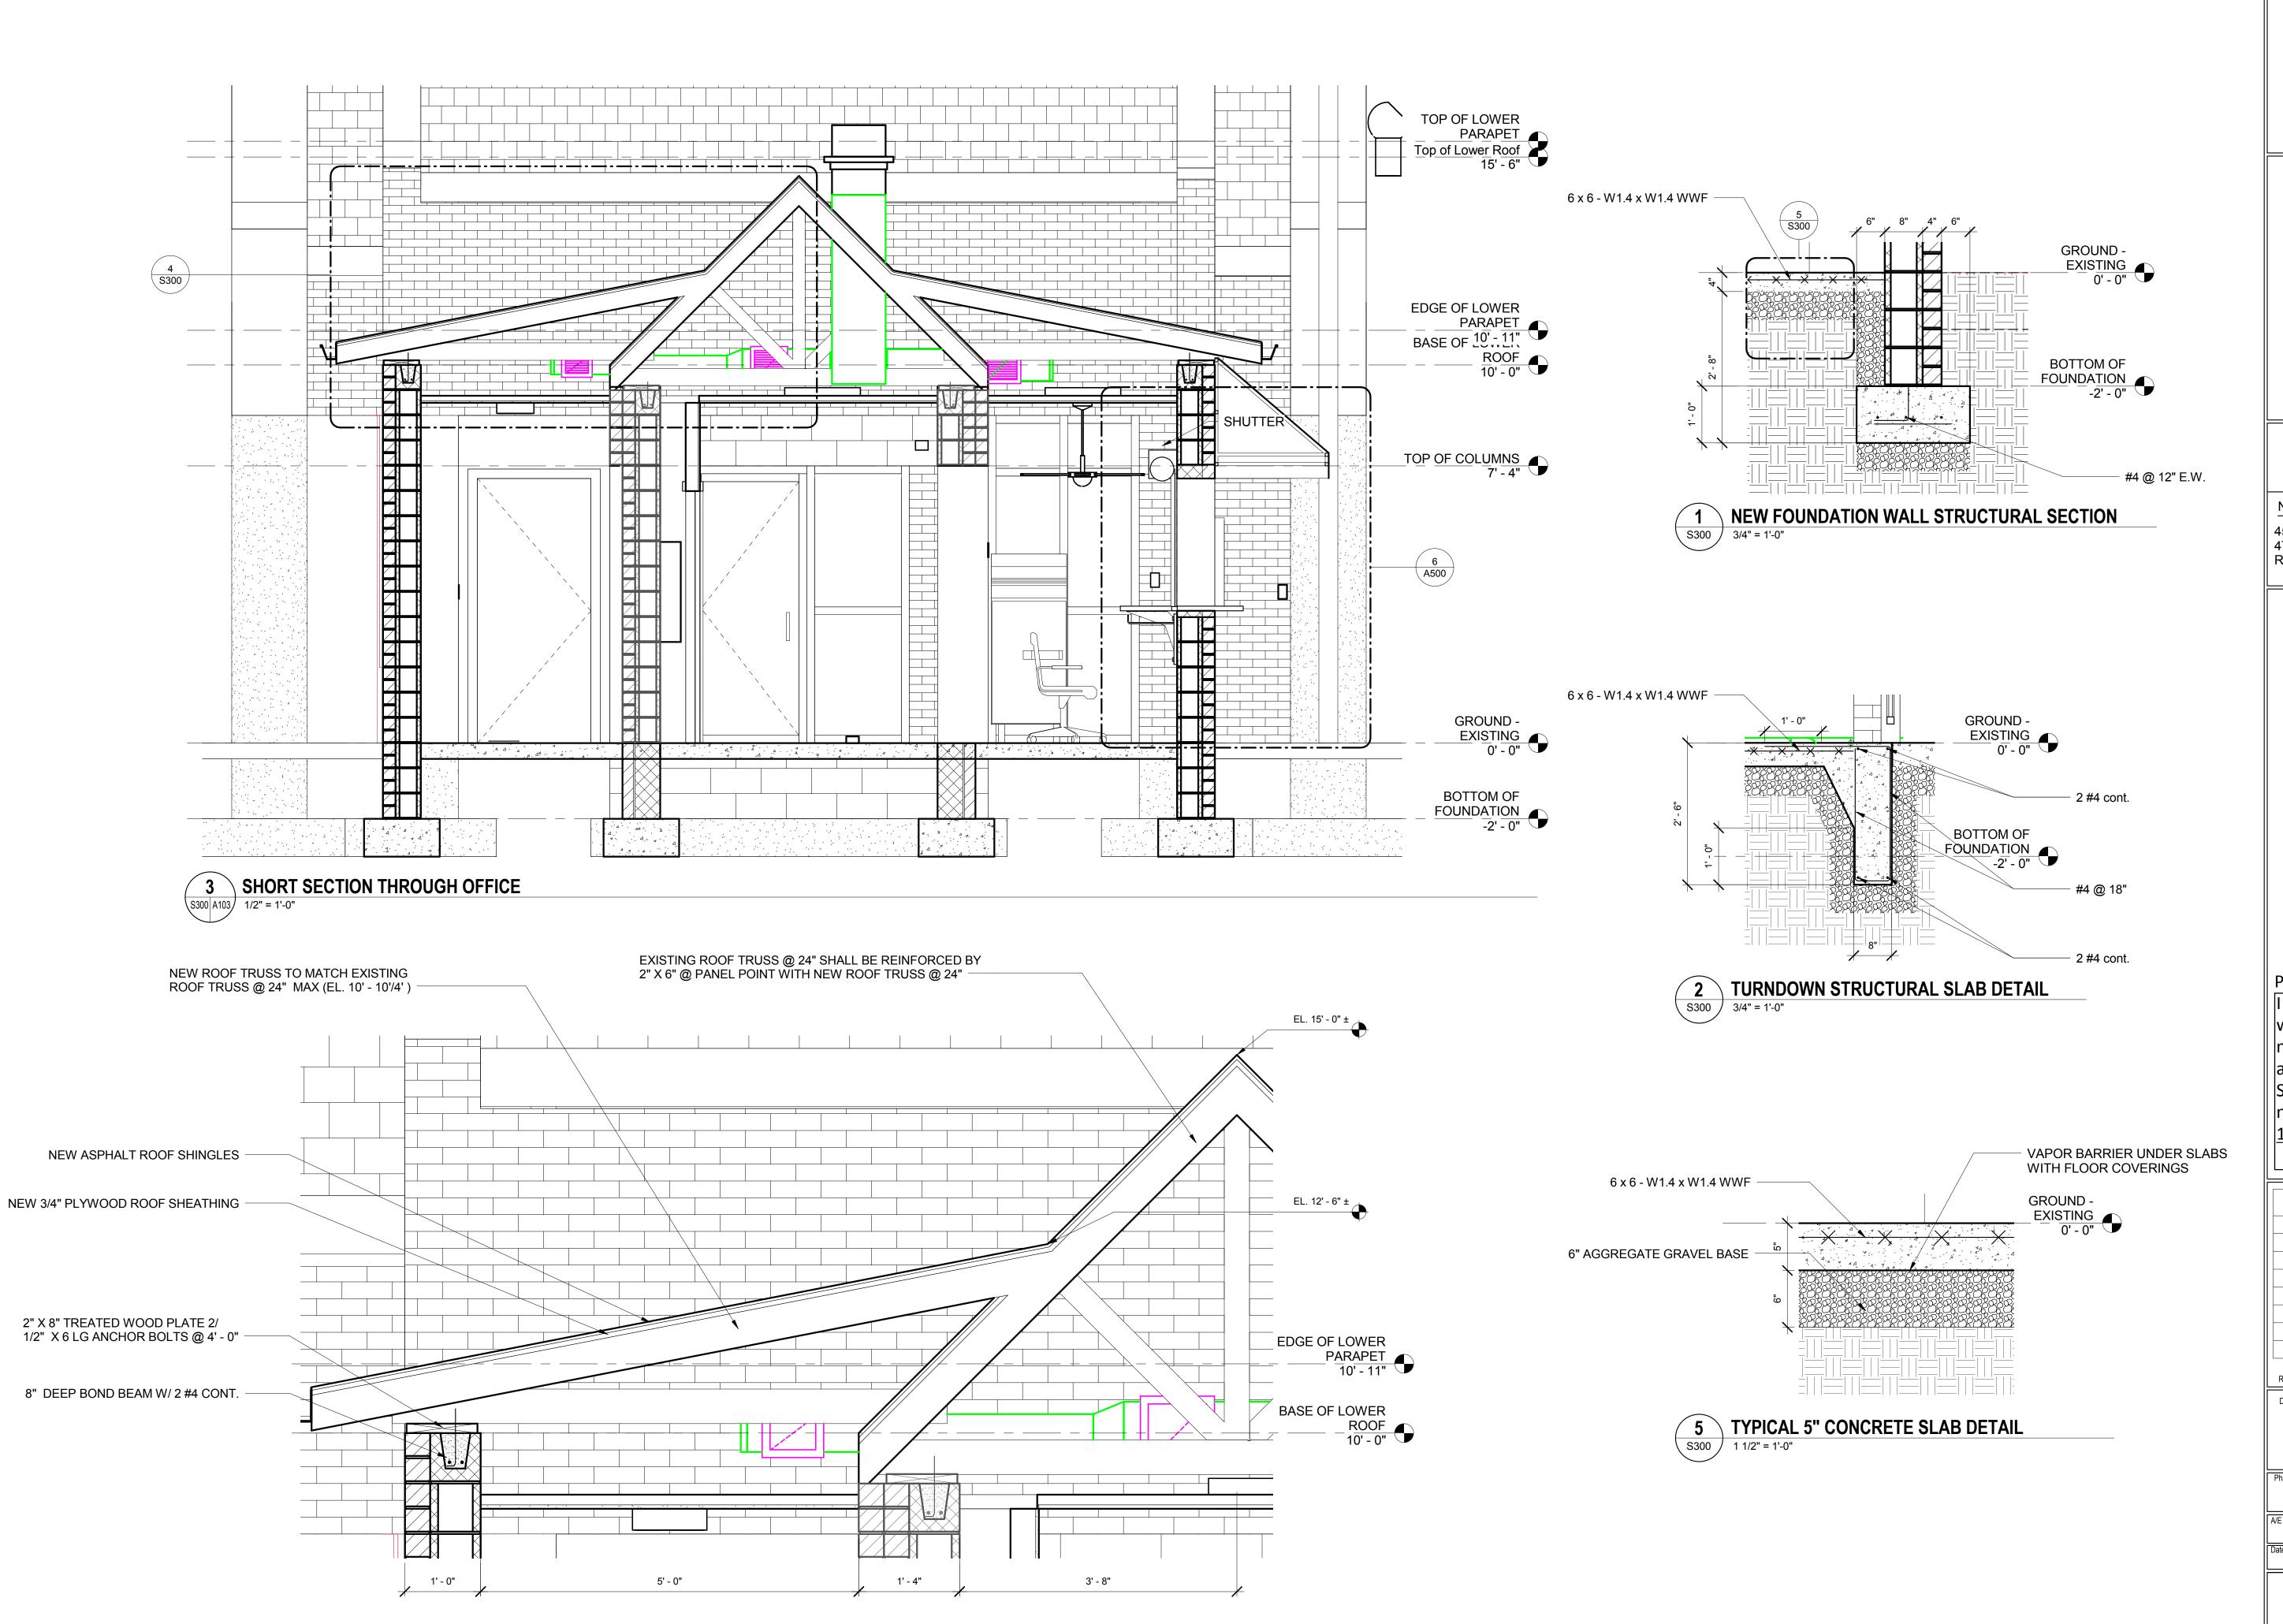

CALLOUT OF NEW ROOF TRUSSES OVER OFFICES

S300 1" = 1'-0"



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Drawing Title

STRUCTURAL - SECTION DETAILS



Checked By AV

Sheet Number

\$300